


Standard Detail Drawings

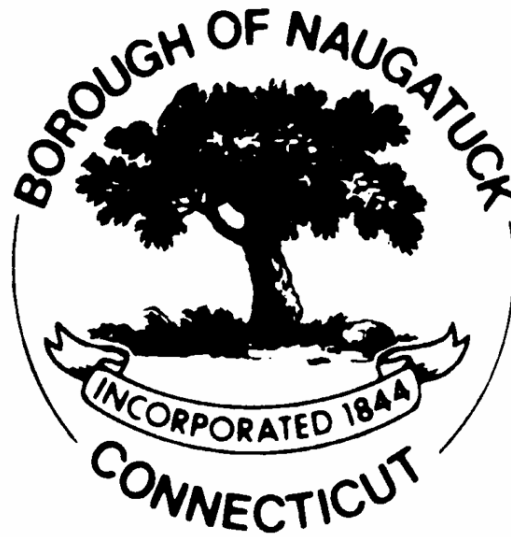

Borough of Naugatuck, Connecticut

ENGINEERING DEPARTMENT

October 2011

BOROUGH OF NAUGATUCK STANDARD DETAIL DRAWINGS

TABLE OF CONTENTS

AUTO AND PEDESTRIAN SURFACES

SD-1	Road Cross Section
SD-2	Permanent Pavement Repair in Borough Street
SD-3	Temporary Pavement Repair in Borough Street
SD-4	Cast-in-Place Concrete Curb
SD-5	Typical Utility Placement in Borough Street
SD-6	Cross Walk
SD-15	Gravel Parking Area with Reinforced Concrete Wheel Stop
SD-22	At Grade Driveway Ramp / Sidewalk
SD-24	Bituminous Concrete Driveway Apron
SD-25	Bituminous Concrete Walk
SD-33	Sidewalk Curb Ramp
SD-34	Sidewalk Curb Ramp Curved Section
SD-36	Sidewalk / Granite Curb
SD-37	Gravel Parking Area
SD-39	Sidewalk Joints
SD-40	Speed Bump
SD-45	Stone Dust Walkway
SD-46	Concrete Ramp Integral with Driveway
SD-47	Stone Dust Walkway in Fill Areas
SD-48	Combined Concrete Sidewalk Details
SD-51	Trench Repair – Borough Roads

CULVERT / SEWER AND STRUCTURES

SD-7	Sanitary Sewer Trench Section
SD-8	Heavy Duty Manhole Frame and Cover
SD-10	Roof Leader Connection
SD-11	Typical Pipe Trench
SD-12	Shallow Manhole
SD-13	Sewer Line Crossing Section
SD-14	Sewer Manhole
SD-16	Deep Drop Manhole Connection (Outside Drop)
SD-17	Sanitary Sewer Lateral Connection
SD-19	Catch Basin (ConnDOT)
SD-28	Sanitary Sewer House Connection and Water Service in Trench
SD-32	Oil-Water Separator (Grease Trap)
SD-49	Inside Drop Manhole
SD-50	Stainless Steel Splash Plate
SD-52	Dry Hydrant
SD-53	Typical Sanitary Sewer Trench
SD-54	Typical Sanitary Sewer Lateral Trench

DRAINAGE STRUCTURES

SD-31	Small Drainage Swale (Grass)
SD-55	Water Bar or Water Break
SD-56	Rip-Rap Level Spreader
SD-57	Retention Basin Example
SD-58	Plunge Pool
SD-59	Headwall
SD-60	Large Drainage Swale (Grass)
SD-61	Type "L" Endwall
SD-62	Dry Retention Basin Example

EARTHWORK / LANDSCAPING


SD-9	Typical Residential Rain Garden
SD-29	Tree Planting
SD-43	Tree Well
SD-44	Concrete Sidewalk with Tree Well
SD-64	Dry Stone Retaining Wall
SD-65	Stone Slope and Stone Slope Paving
SD-66	Unreinforced Segmental Retaining Wall

EROSION CONTROL

SD-21	Erosion Control Blanket on Fill Slope
SD-23	Anti-Tracking Pad
SD-26	Catch Basin Erosion Control
SD-30	Hay Bale Barrier
SD-35	Typical Erosion Control on Slopes
SD-41	Filter Fabric Sediment Control Fence Placement and Construction
SD-42	Hay Bale Sediment Check Dam
SD-68	Sediment Control Systems

INCIDENTALS

SD-18	Bridge Rail
SD-20	Metal Beam Rail
SD-27	Chain Link Double Swing Gate
SD-38	Chain Link Fence
SD-63	Timber Guide Rail
SD-67	Bollard
SD-69	Concrete Stairs

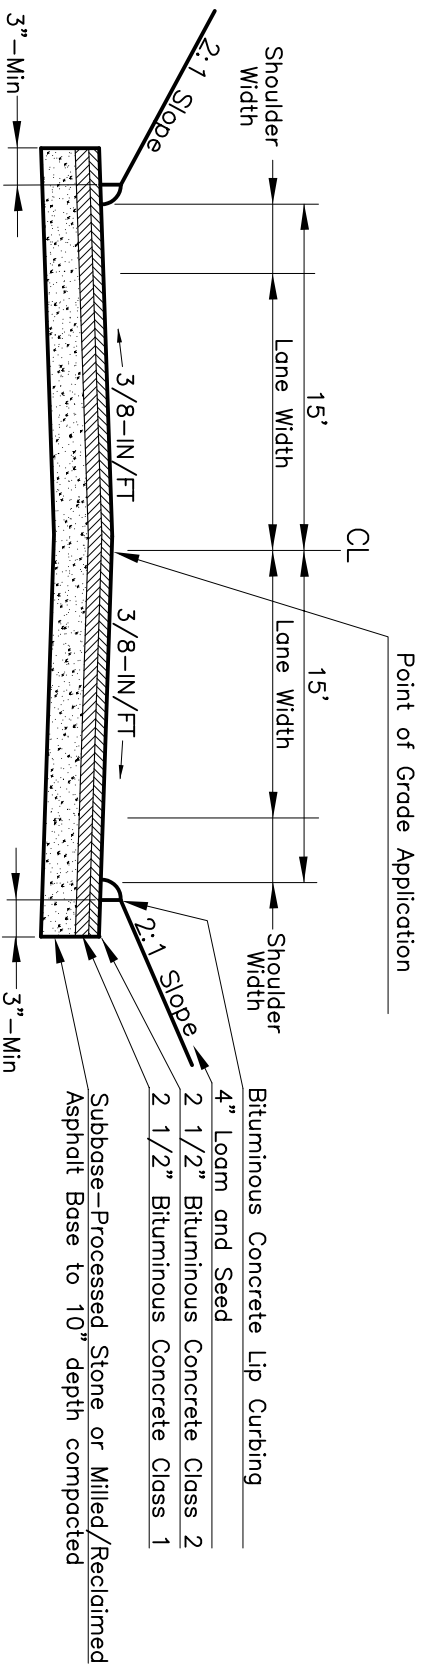

ROAD CROSS SECTION

**BOROUGH OF NAUGATUCK
ENGINEERING DEPARTMENT
STANDARD DETAIL**


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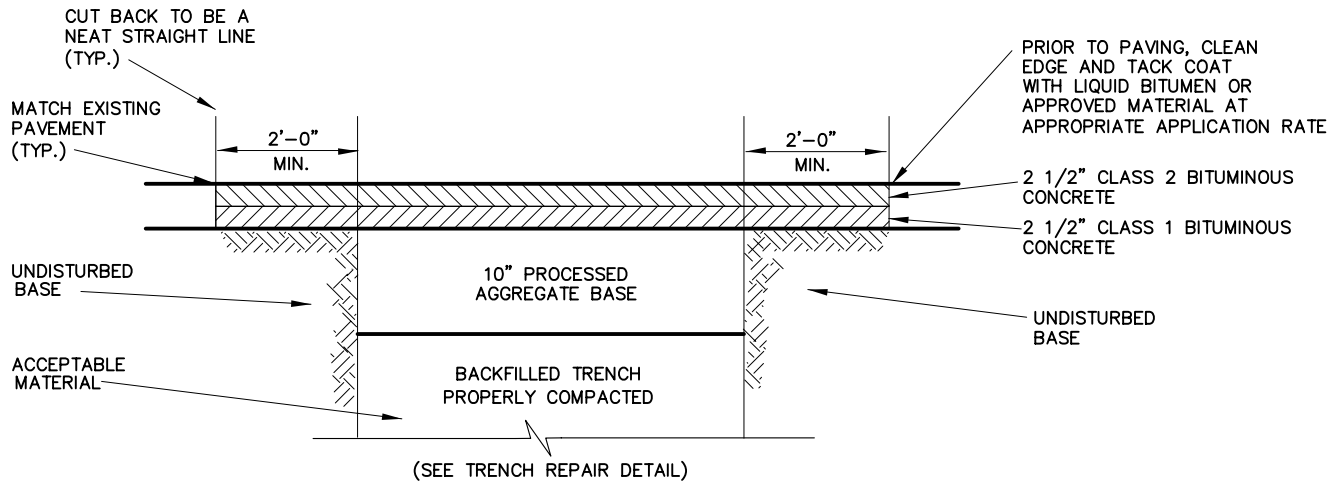
229 Church Street, Naugatuck, CT 06770 www.naugatuck-ct.gov

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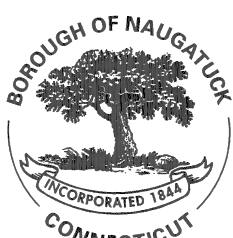


ROAD PAVING WITHIN LAST 8 YEARS



ROAD PAVING OVER 8 YEARS OLD

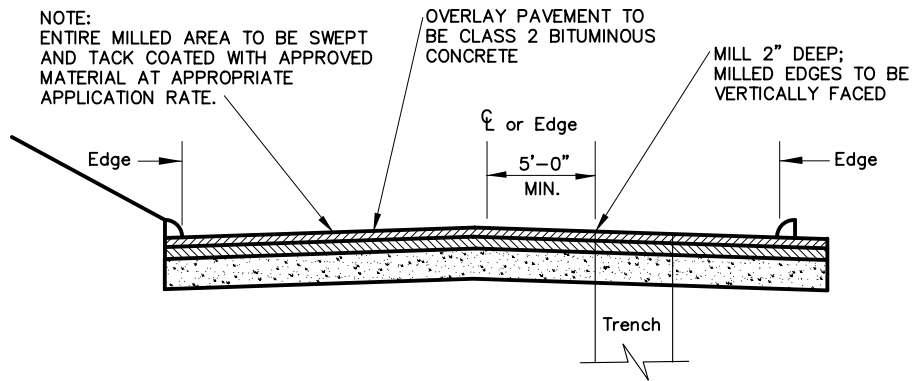NOTES:
 ACCEPTABLE MATERIAL COMPACTED IN LIFTS NOT TO EXCEED 12" WITH 95% COMPACTION FOR EACH LIFT.
 24" LIFTS MAY BE APPROVED IF COMPACTED BY HOE-PACK WITH 95% COMPACTION FOR EACH LIFT.
 COMPACTION TO MEET 95% MODIFIED PROCTOR DENSITY REQUIREMENTS.
 COMPACTION TESTS MAY BE REQUIRED PER INSPECTOR. ALL COSTS FOR COMPACTION TESTS TO BE BORNE BY CONTRACTOR.



PERMANENT PAVEMENT REPAIR IN BOROUGH STREET

**BOROUGH OF NAUGATUCK
ENGINEERING DEPARTMENT
STANDARD DETAIL**

229 Church Street, Naugatuck, CT 06770


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SD-2

Date: 10/2011



TEMPORARY PAVEMENT REPAIR IN BOROUGH STREET

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ENGINEERING DEPARTMENT
STANDARD DETAIL**

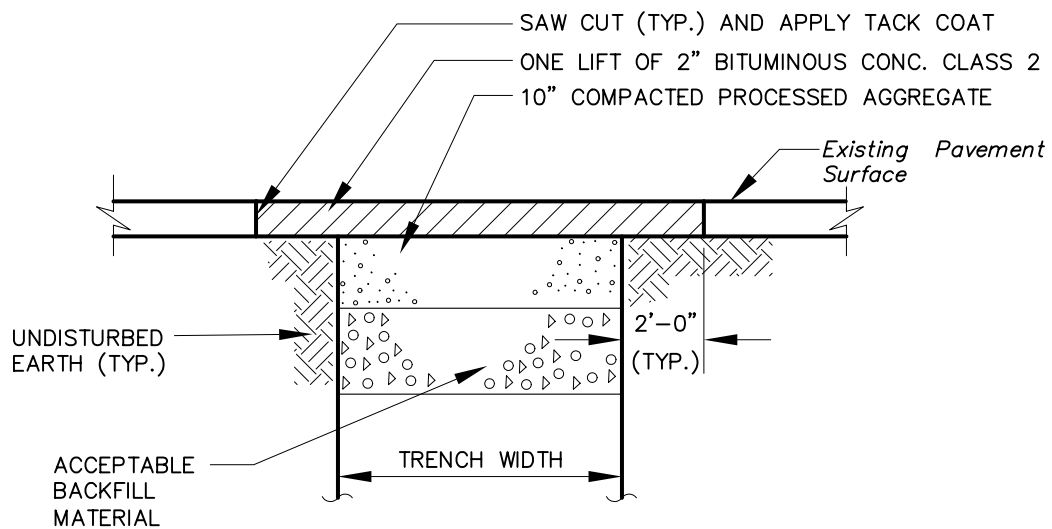229 Church Street, Naugatuck, CT 06770


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Drawing No.

SD-3

Date: 10/2011



- NOTES:
1. CONSTRUCTION JOINTS SHALL BE SPACED APPROXIMATELY EVERY 10 FEET BUT NOT LESS THAN 6 FEET. 1/2" THICK PREFORMED EXPANSION JOINT FILLER SHALL BE INSTALLED NOT MORE THAN 40 FEET C-C AT INTERSECTION OF CONCRETE SIDEWALK AND CURB AND AT SIDEWALK-BUILDING INTERFACE.
 2. FORMWORK SHALL REMAIN IN PLACE FOR 24 HOURS FOLLOWING CONCRETE POURING.

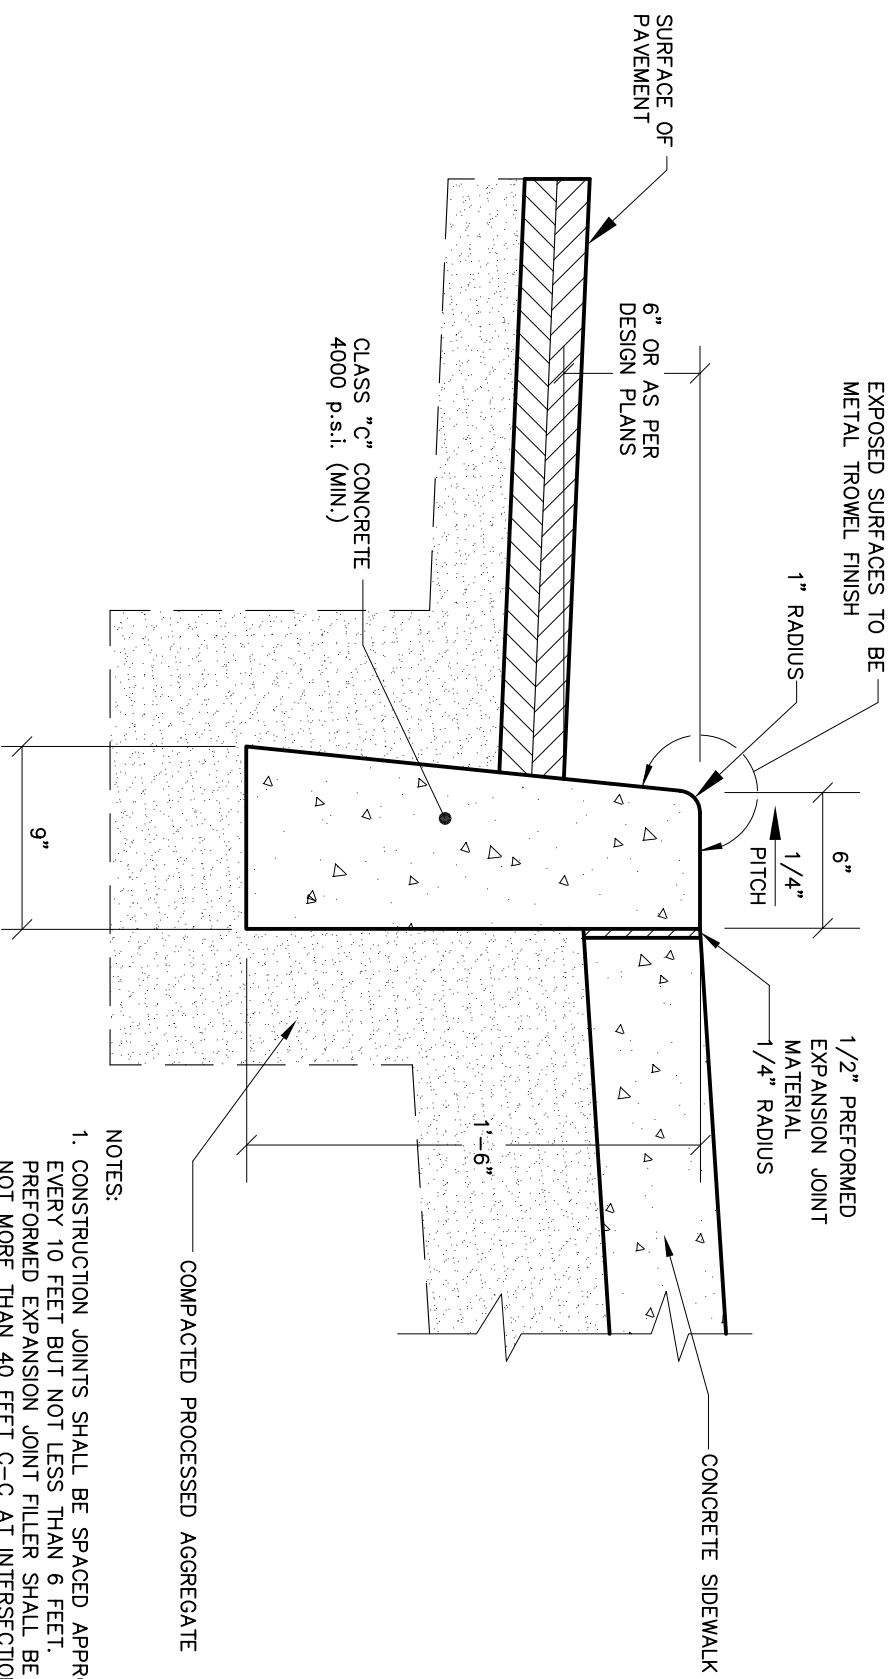CAST-IN-PLACE CONCRETE CURB

BOROUGH OF NAUGATUCK
ENGINEERING DEPARTMENT
STANDARD DETAIL

229 Church Street, Naugatuck, CT 06770

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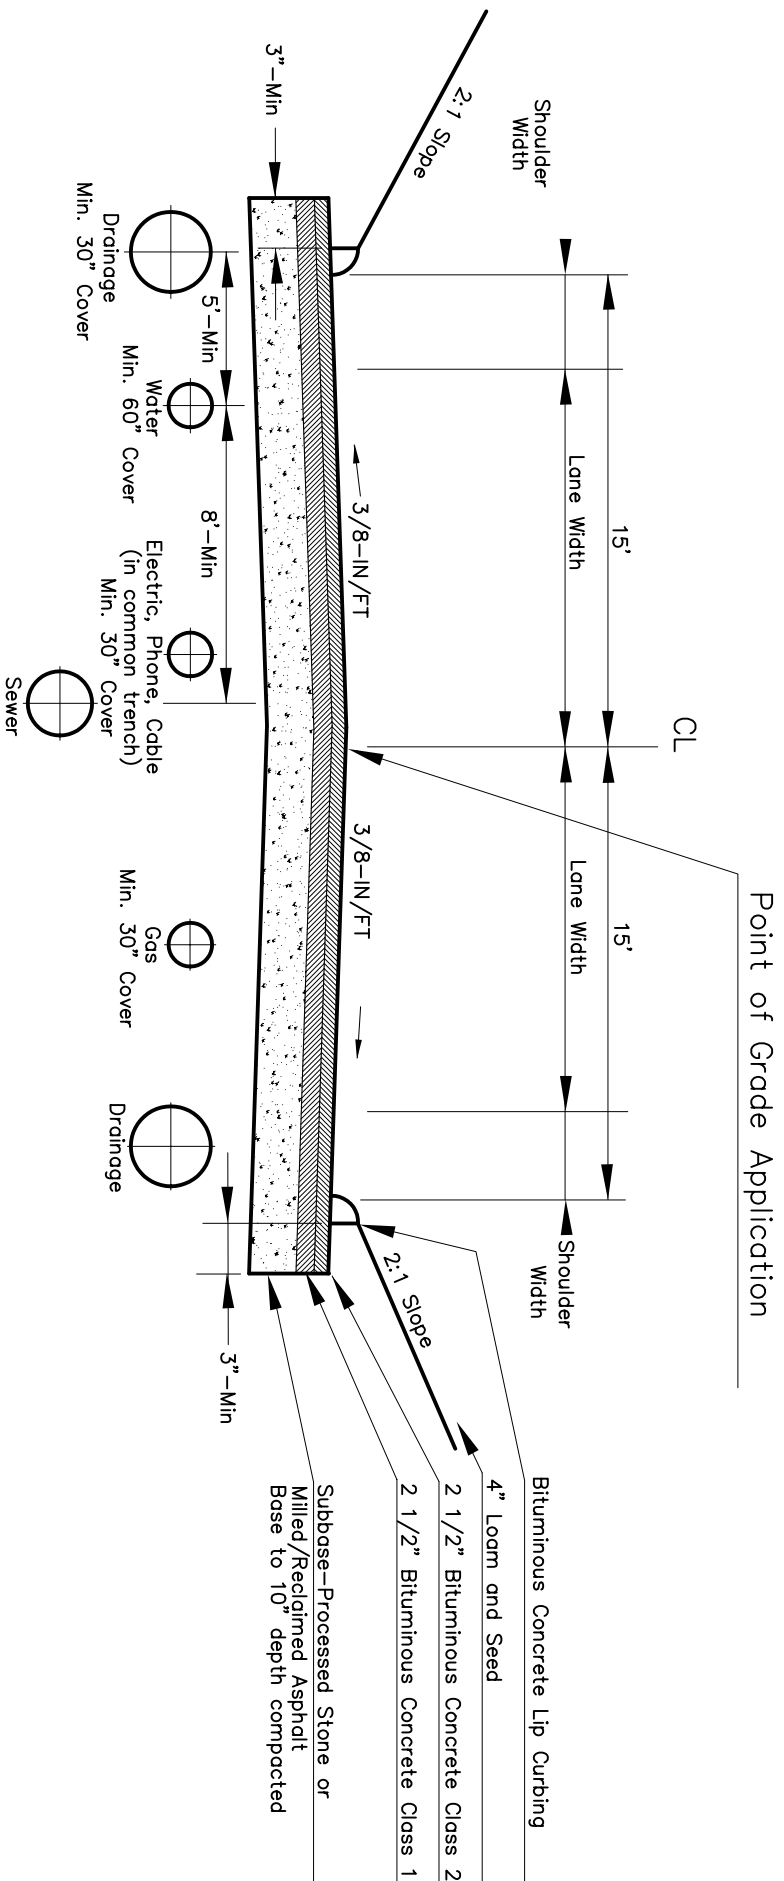
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SD-4

Date: 10/2011





DEPTHS AND LOCATION DIMENSIONS



TYPICAL UTILITY PLACEMENT IN BOROUGH STREET

BOROUGH OF NAUGATUCK ENGINEERING DEPARTMENT STANDARD DETAIL


229 Church Street, Naugatuck, CT 06770

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Drawing No.

SD-5

Date: 10/2011

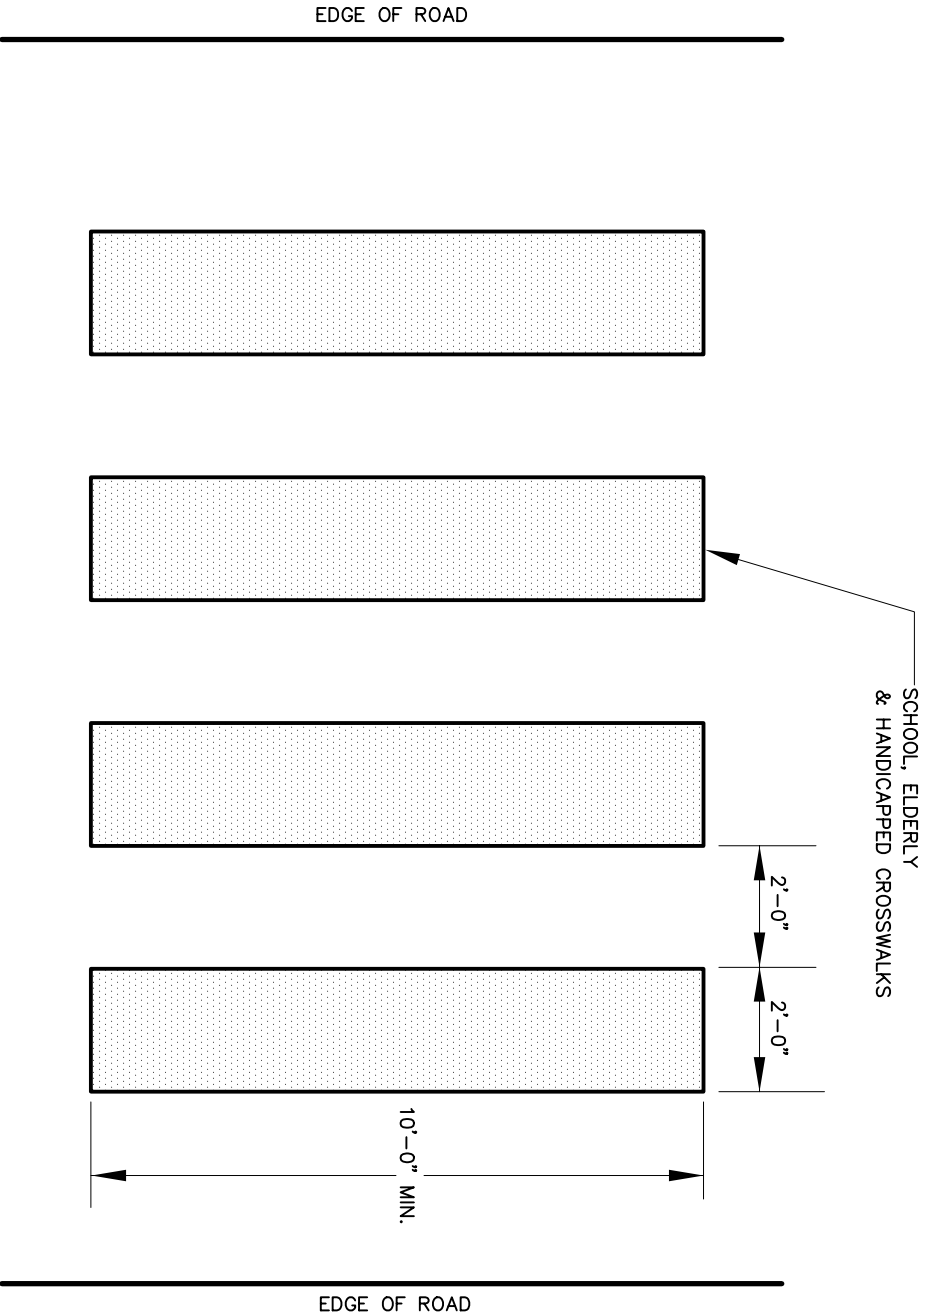

CROSS WALK

**BOROUGH OF NAUGATUCK
ENGINEERING DEPARTMENT
STANDARD DETAIL**



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SD-6

Date: 10/2011



GRAVEL PARKING AREA WITH REINFORCED CONCRETE WHEEL STOP

BOROUGH OF NAUGATUCK
ENGINEERING DEPARTMENT
STANDARD DETAIL

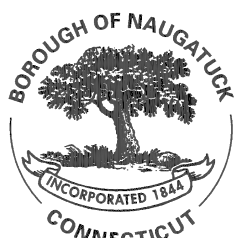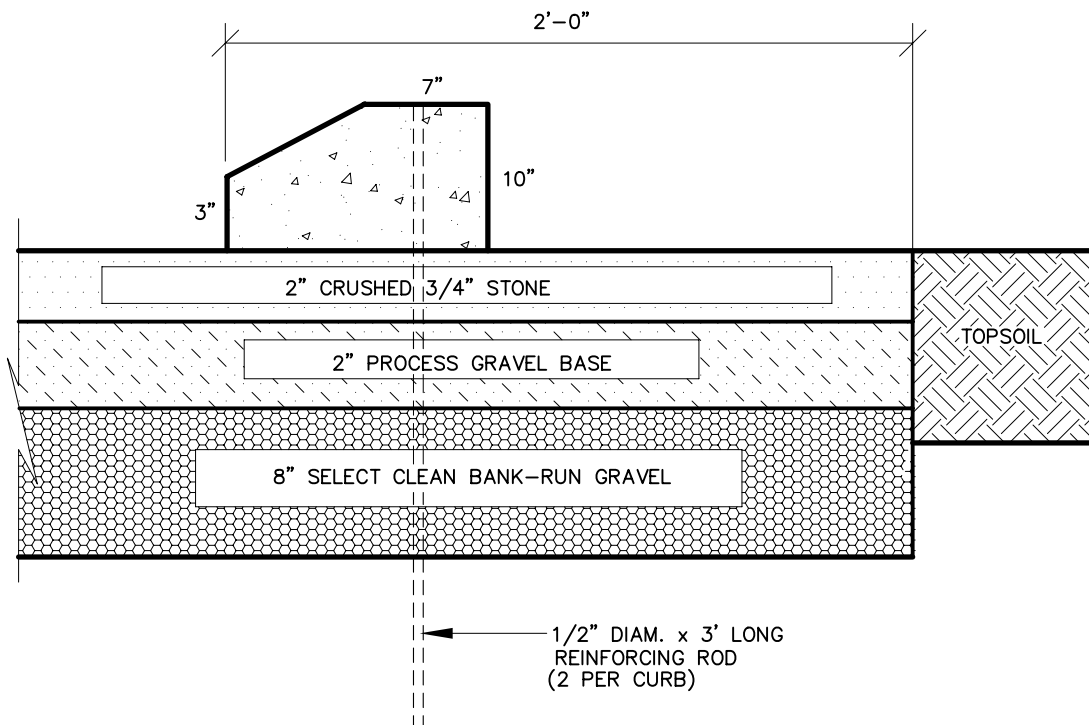229 Church Street, Naugatuck, CT 06770


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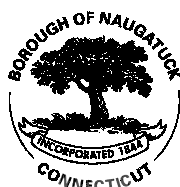
Drawing No.

SD-15

Date: 10/2011



NOTE:
DEPRESS CONCRETE SIDEWALK ACROSS DRIVEWAY WHEN
NECESSARY TO MATCH EXISTING DRIVEWAY. SLOPE SIDEWALK
APPROACHES DOWN TO MEET DRIVEWAY FROM A DISTANCE OF
5 FEET.

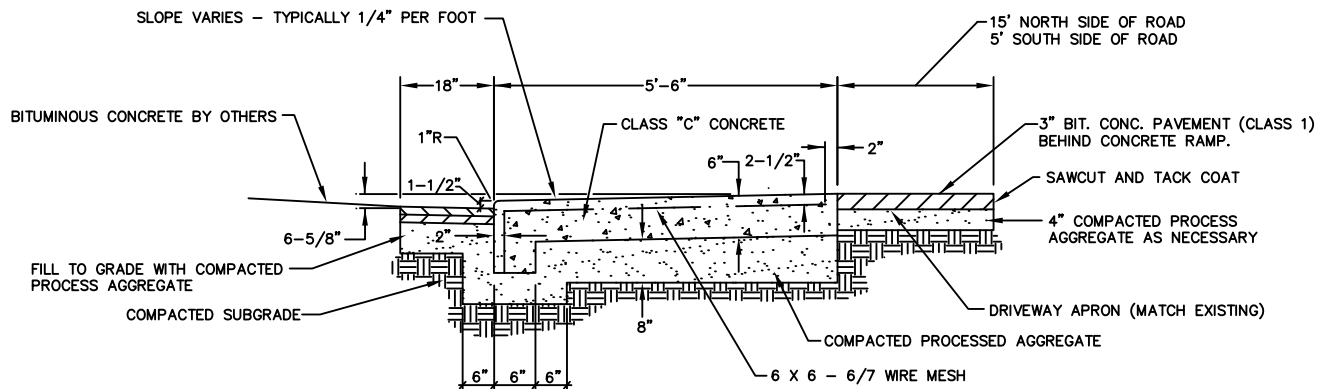

AT-GRADE DRIVEWAY RAMP/SIDEWALK

BOROUGH OF NAUGATUCK
ENGINEERING DEPARTMENT
STANDARD DETAIL

229 Church Street, Naugatuck, CT 06770


www.naugatuck-ct.gov

Scale: NTS

Drawing No.

SD-22

Date: 10/2011

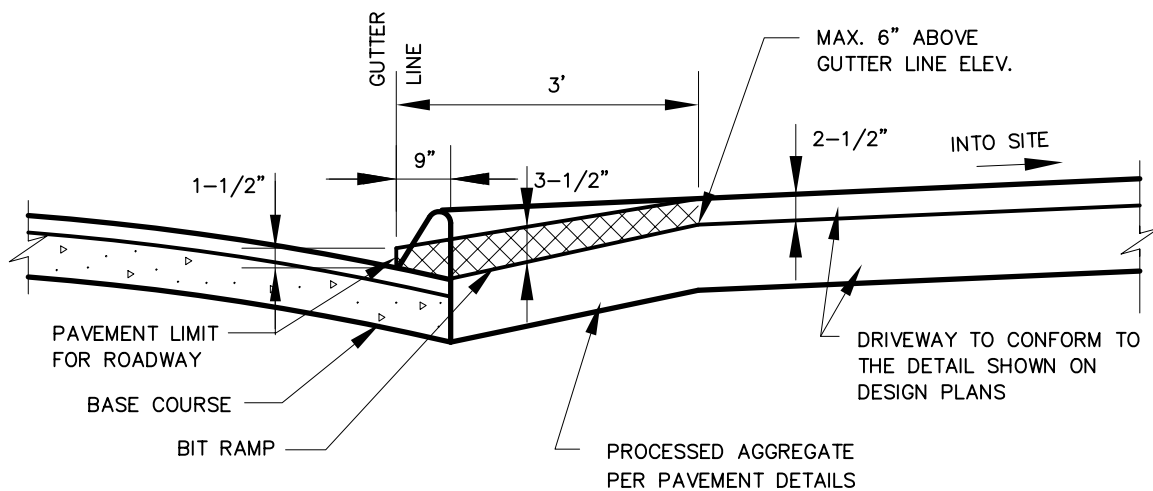

NOTE:

1. COMPACTION TO BE COMPLETED IN 4" LIFTS
2. DEPTHS SHOWN ARE AFTER COMPACTION



BITUMINOUS CONCRETE DRIVEWAY APRON

**BOROUGH OF NAUGATUCK
ENGINEERING DEPARTMENT
STANDARD DETAIL**

229 Church Street, Naugatuck, CT 06770


www.naugatuck-ct.gov

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Drawing No.

SD-24

Date: 10/2011

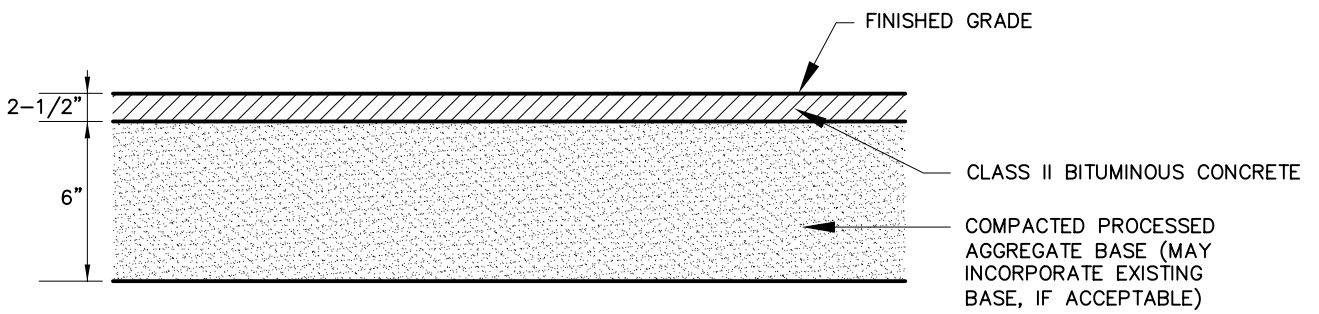

BITUMINOUS CONCRETE WALK

**BOROUGH OF NAUGATUCK
ENGINEERING DEPARTMENT
STANDARD DETAIL**

229 Church Street, Naugatuck, CT 06770


www.naugatuck-ct.gov

Scale: NTS

Drawing No.

SD-25

Date: 10/2011

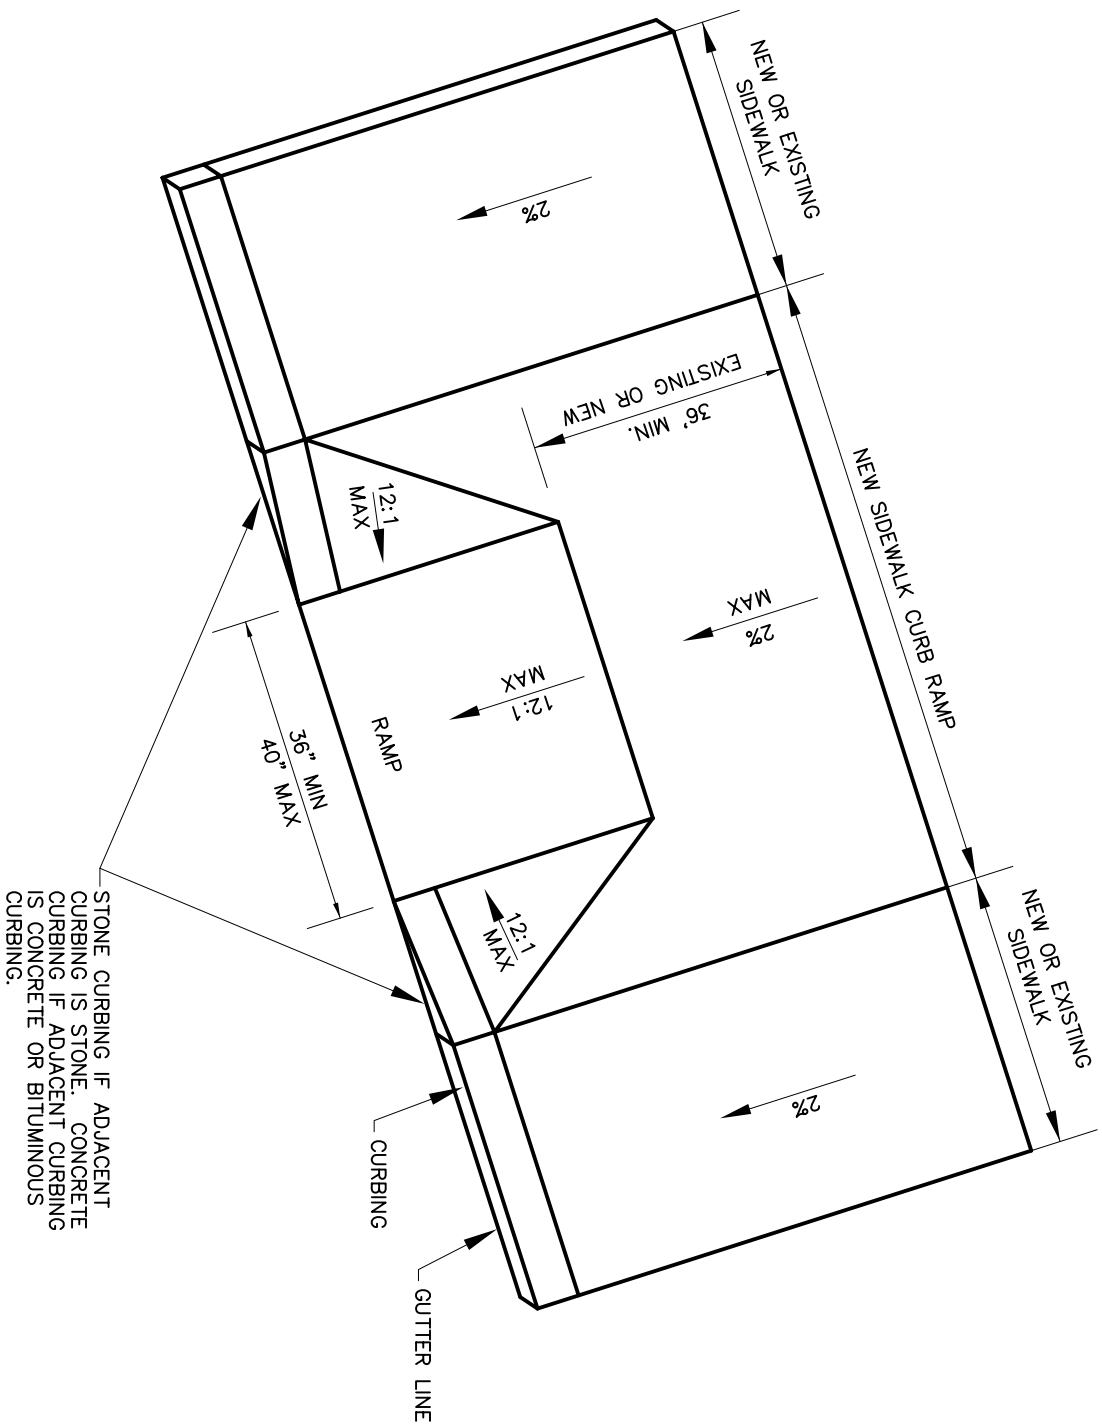

SIDEWALK CURB RAMP

**BOROUGH OF NAUGATUCK
ENGINEERING DEPARTMENT
STANDARD DETAIL**

229 Church Street, Naugatuck, CT 06770

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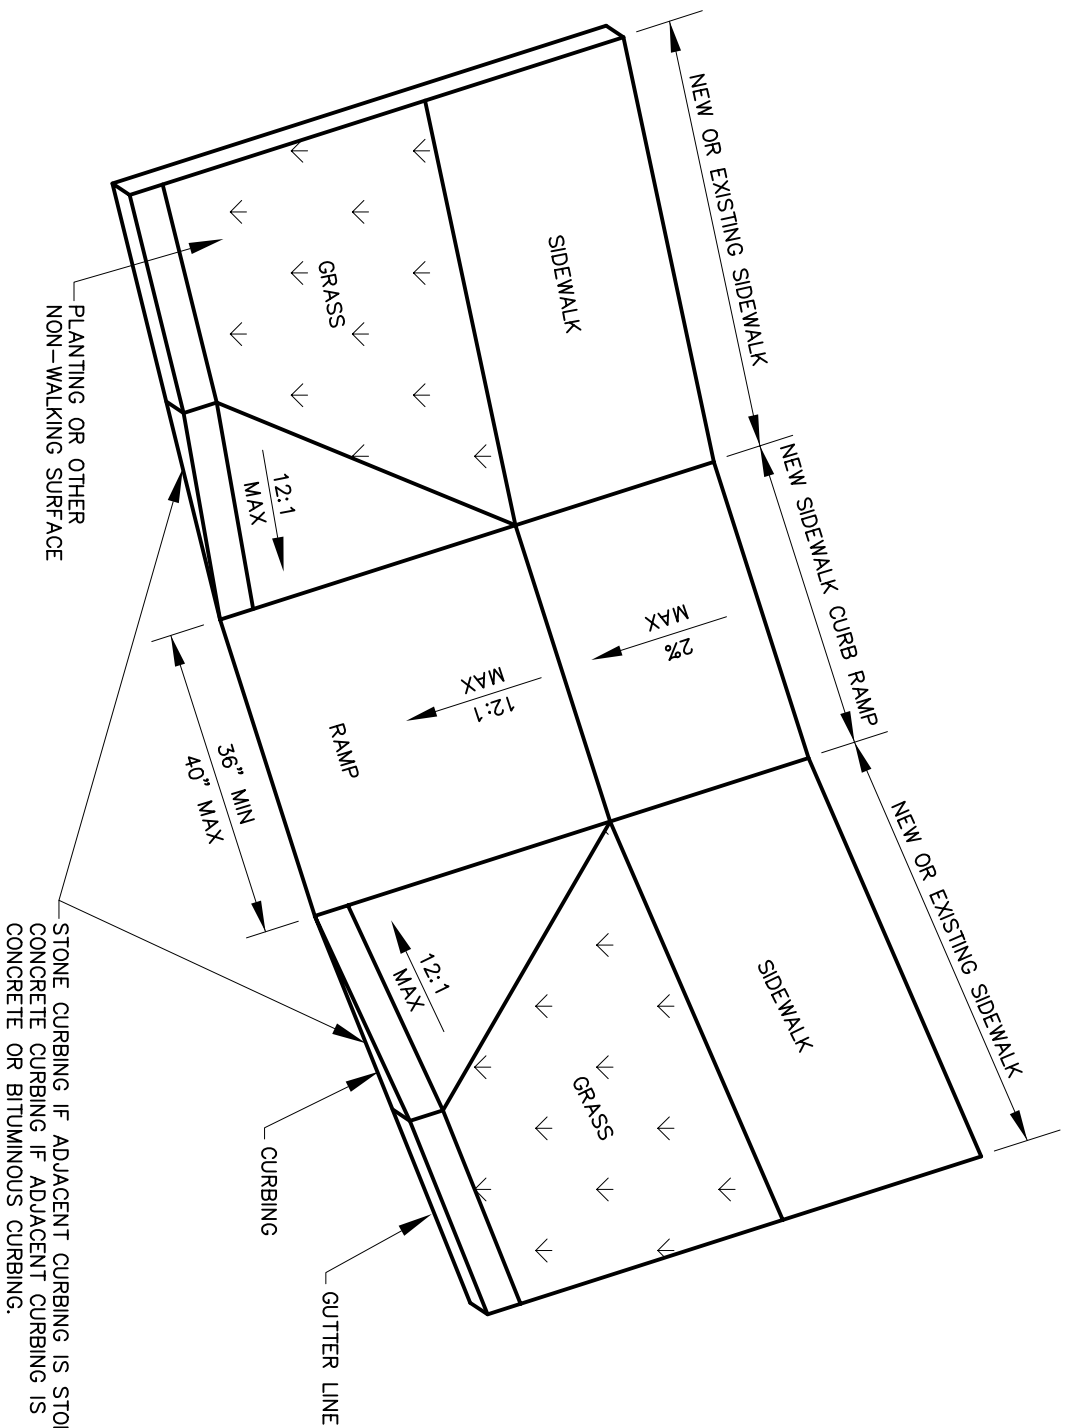
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Drawing No.

SD-33

Date: 10/2011





SIDEWALK CURB RAMP CURVED SECTION

BOROUGH OF NAUGATUCK
ENGINEERING DEPARTMENT
STANDARD DETAIL

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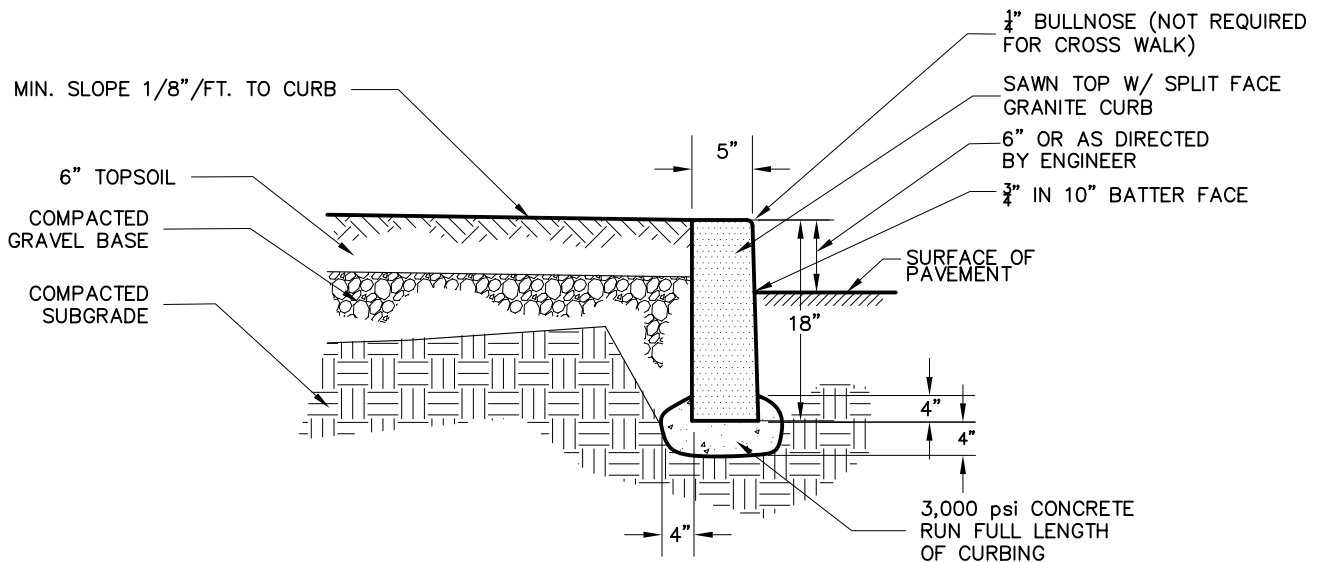
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Drawing No.

SD-34

Date: 10/2011







THE CURBING SHALL HAVE A SMOOTH, QUARRY-SPLIT FRONT FACE, NO EXPOSED DRILL HOLES, NO PROJECTIONS GREATER THEN 3/4" OR DEPRESSIONS GREATER THEN 1/2".

CURVED SECTIONS SHALL BE PROVIDED FOR RADIUS OF 50' OR LESS.

GRANITE CURB

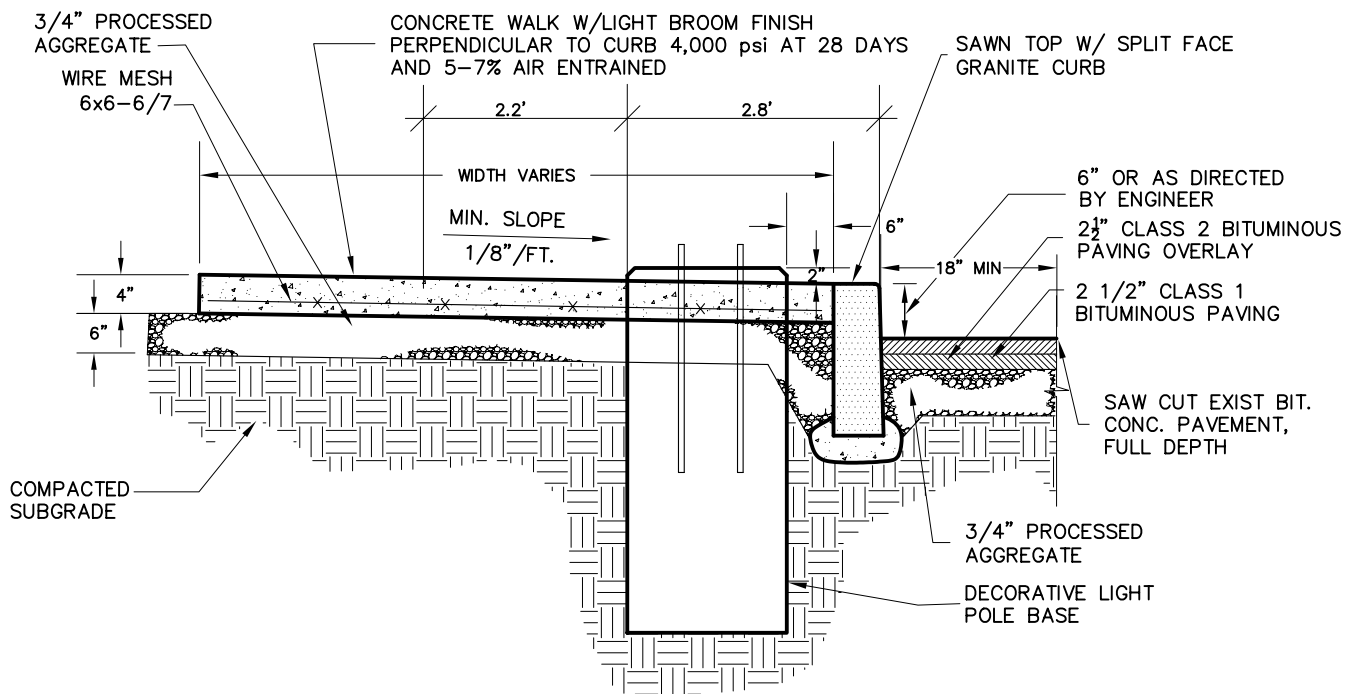

SIDEWALK/GRANITE CURB WITH LIGHT POLE BASE

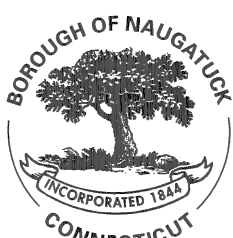

SIDEWALK/GRANITE CURB

BOROUGH OF NAUGATUCK
ENGINEERING DEPARTMENT
STANDARD DETAIL

229 Church Street, Naugatuck, CT 06770


www.naugatuck-ct.gov

Scale: NTS

Drawing No.

SD-36

Date: 10/2011

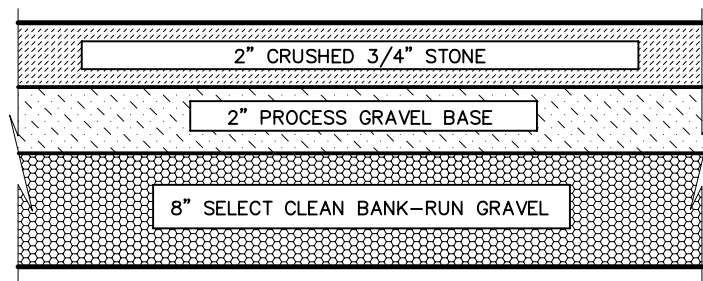

GRAVEL PARKING AREA

**BOROUGH OF NAUGATUCK
ENGINEERING DEPARTMENT
STANDARD DETAIL**

229 Church Street, Naugatuck, CT 06770


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Scale: NTS

Drawing No.

SD-37

Date:10/2011

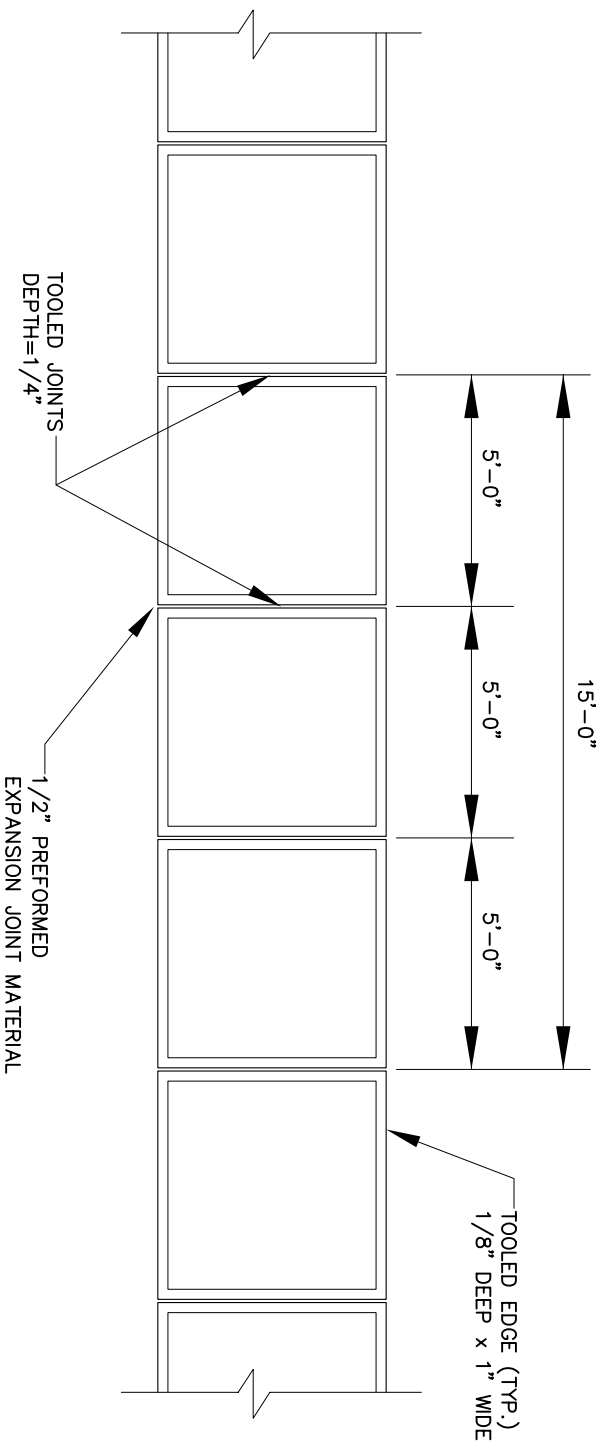

SIDEWALK JOINTS



**BOROUGH OF NAUGATUCK
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STANDARD DETAIL**

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Scale: NTS
Drawing No.

SD-39

Date: 10/2011

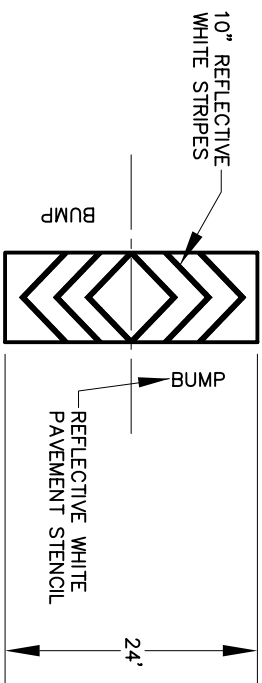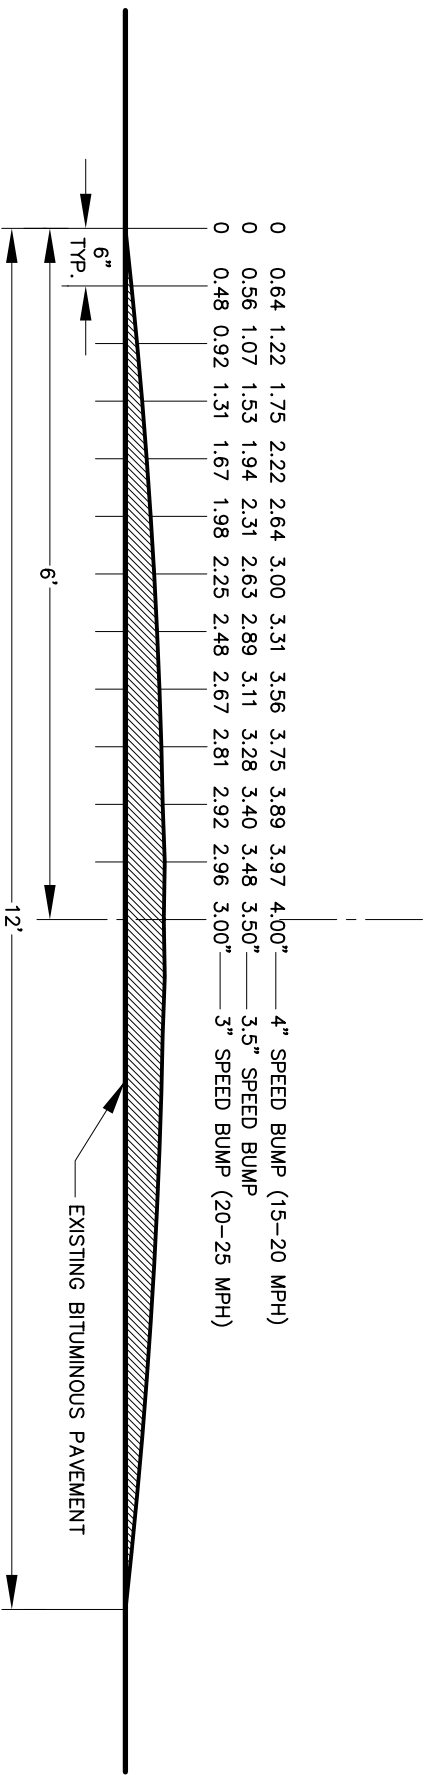

SPEED BUMP

**BOROUGH OF NAUGATUCK
ENGINEERING DEPARTMENT
STANDARD DETAIL**

229 Church Street, Naugatuck, CT 06770

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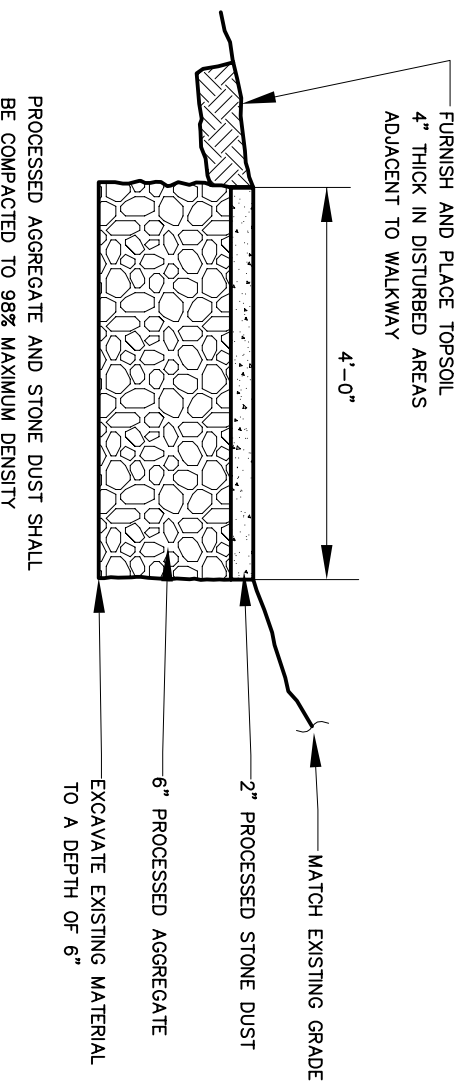
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Drawing No.

SD-40

Date: 10/2011





STONE DUST WALKWAY

**BOROUGH OF NAUGATUCK
ENGINEERING DEPARTMENT
STANDARD DETAIL**

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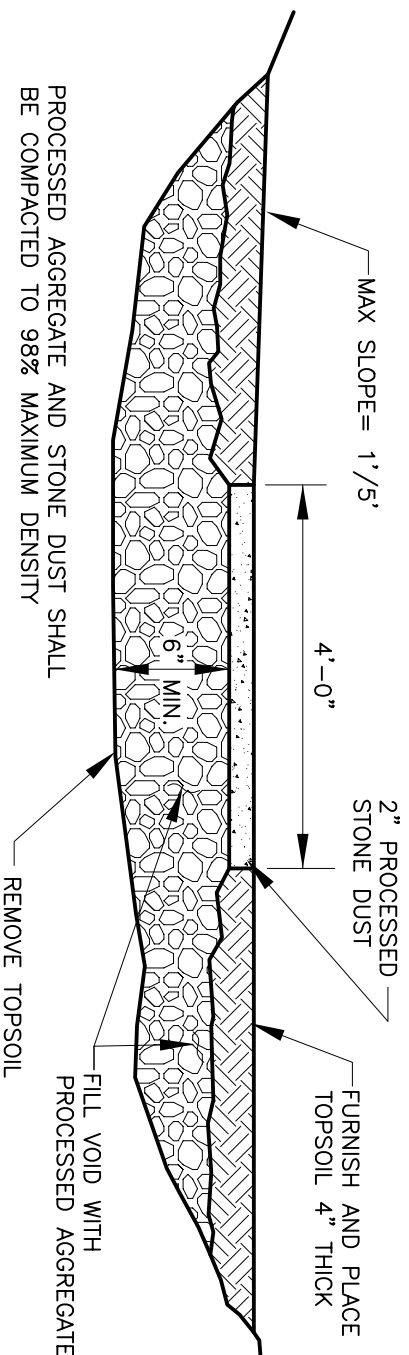


Scale: NTS

Drawing No.

SD-45

Date: 10/2011



STONE DUST WALKWAY IN FILL AREAS

**BOROUGH OF NAUGATUCK
ENGINEERING DEPARTMENT
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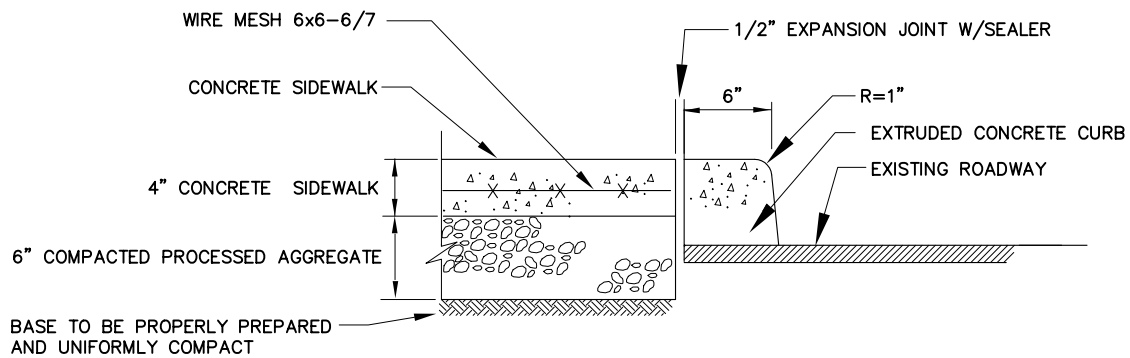


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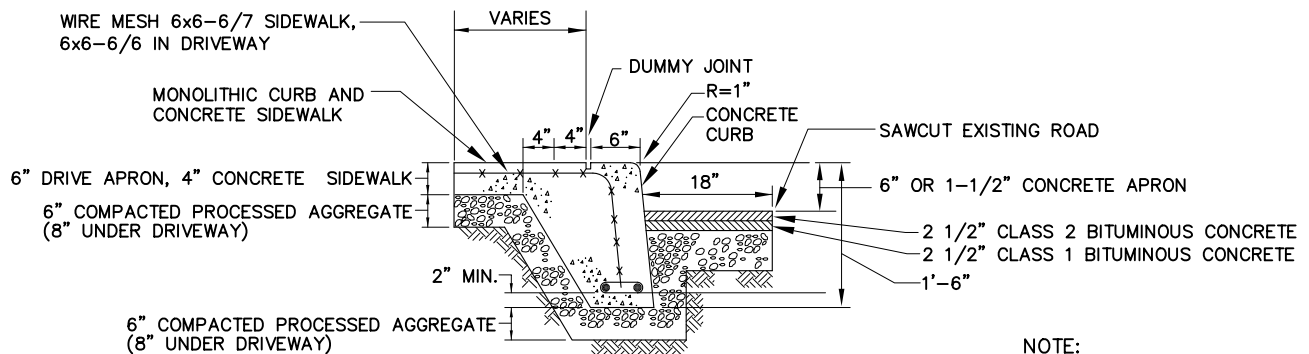
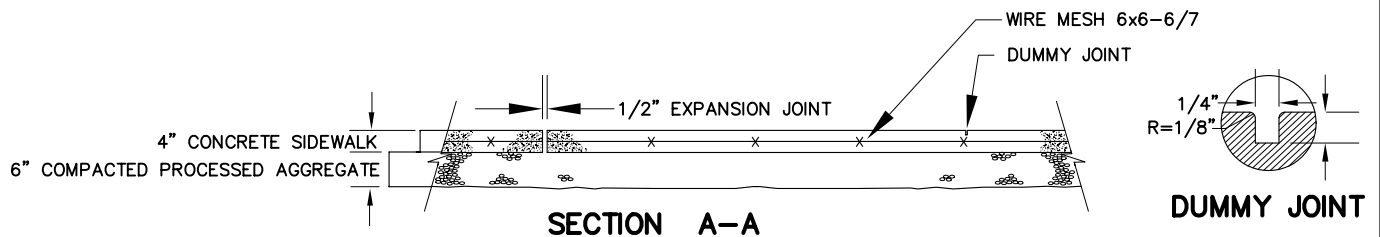
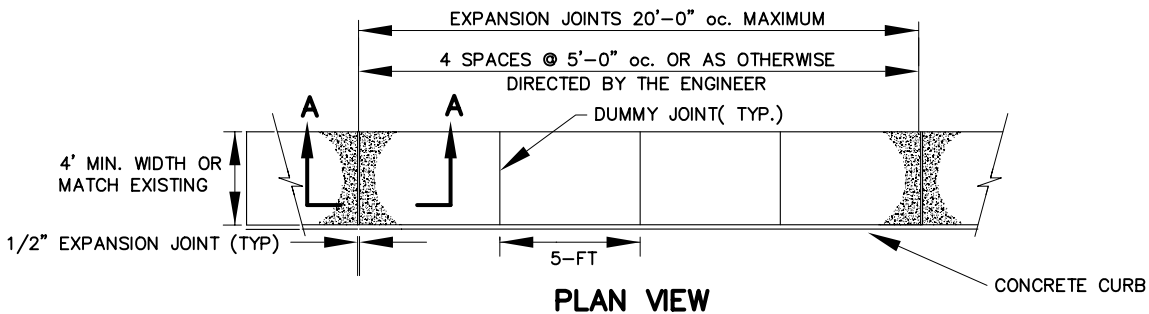
Drawing No.

SD-47

Date: 10/2011



EXTRUDED CONCRETE CURB AND WALK DETAIL



MONOLITHIC CURB AND SIDEWALK DETAIL

NOTE:
ALL CAST CONCRETE
STRUCTURES TO BE CURED IN
ACCORDANCE WITH STANDARD
CURING PRACTICE.



COMBINED CONCRETE SIDEWALK DETAILS

**BOROUGH OF NAUGATUCK
ENGINEERING DEPARTMENT
STANDARD DETAIL**

229 Church Street, Naugatuck, CT 06770



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Scale: NTS

Drawing No.

SD-48

Date: 10/2011

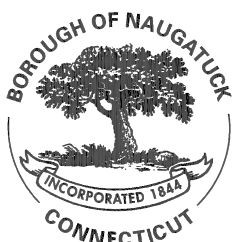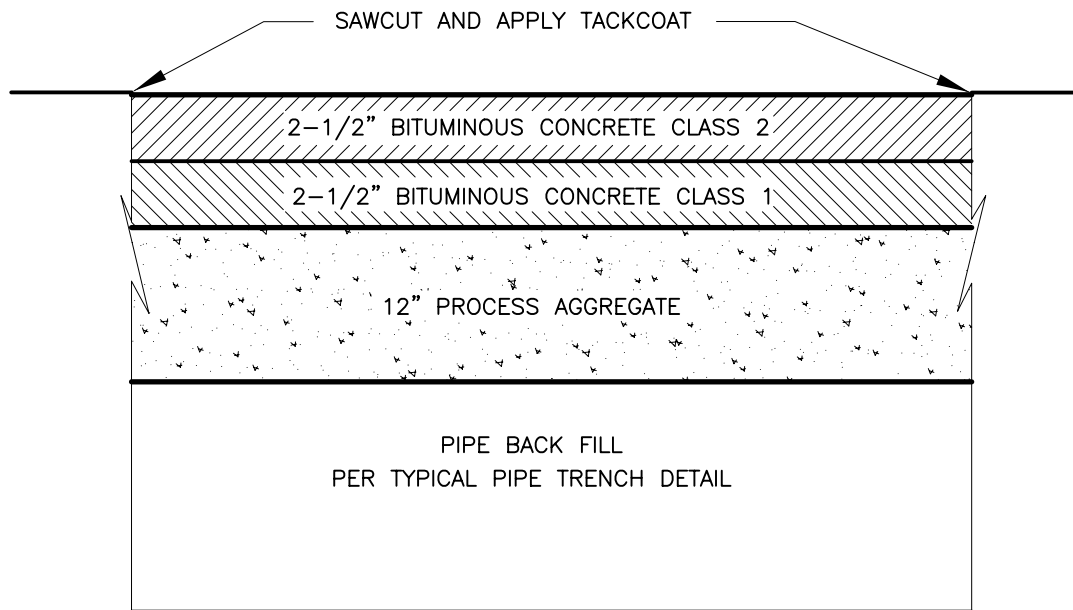

TRENCH REPAIR – BOROUGH STREETS

**BOROUGH OF NAUGATUCK
ENGINEERING DEPARTMENT
STANDARD DETAIL**

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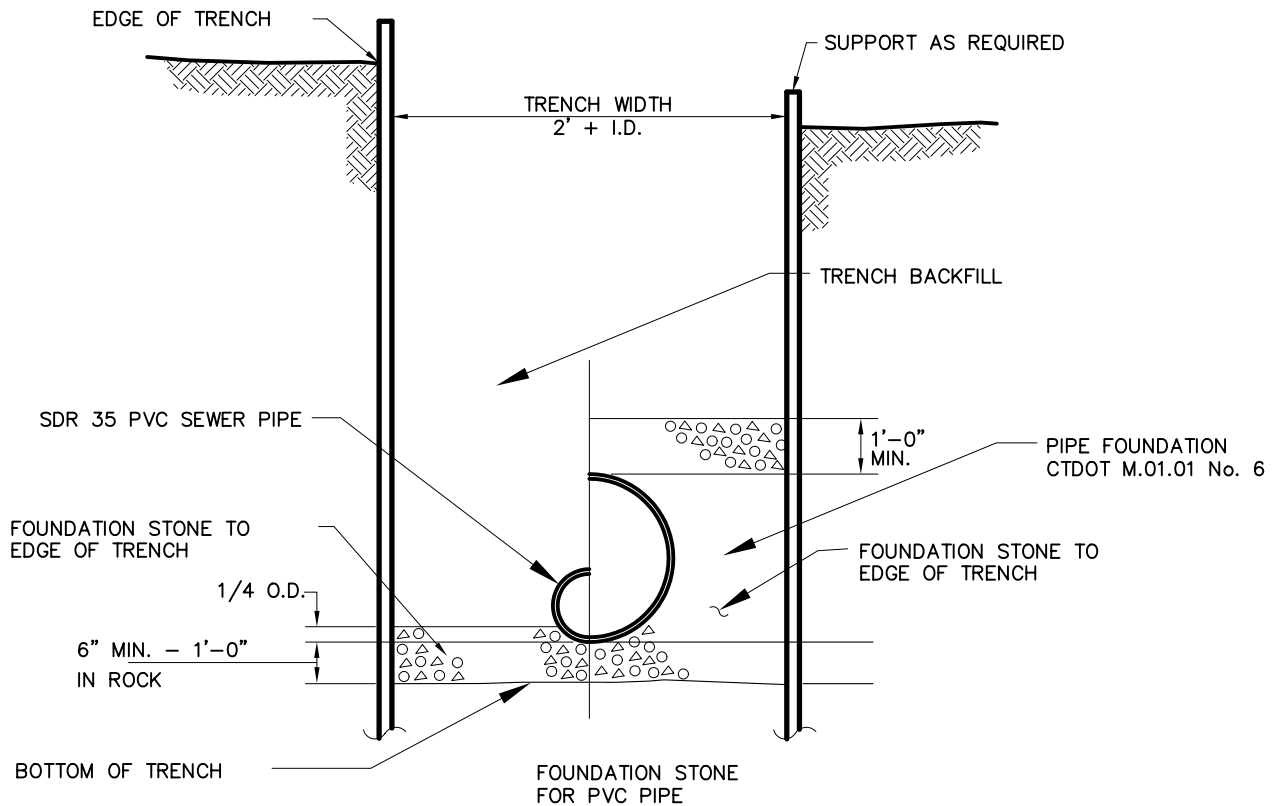
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Scale: NTS

Drawing No.

SD-51

Date:10/2011



SANITARY SEWER TRENCH SECTION

**BOROUGH OF NAUGATUCK
ENGINEERING DEPARTMENT
STANDARD DETAIL**

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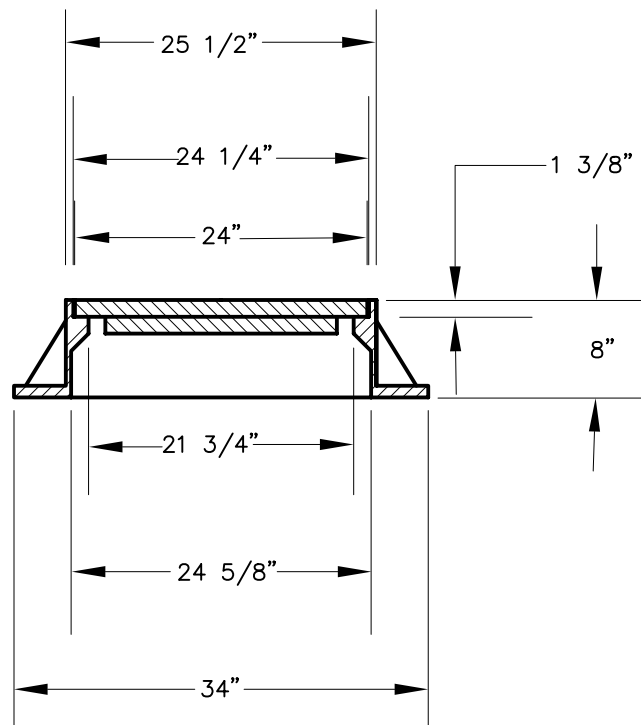
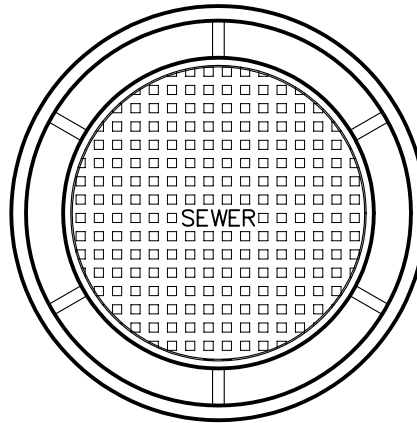
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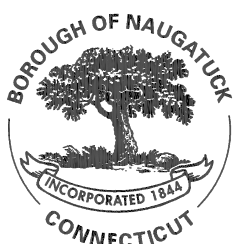
Drawing No.

SD-7

Date: 10/2011



**CAMPBELL CONSTRUCTION CASTINGS
PATTERN NO. 1007D
HEAVY DUTY MANHOLE FRAME AND COVER**



**HEAVY DUTY
MANHOLE FRAME AND COVER**

**BOROUGH OF NAUGATUCK
ENGINEERING DEPARTMENT
STANDARD DETAIL**

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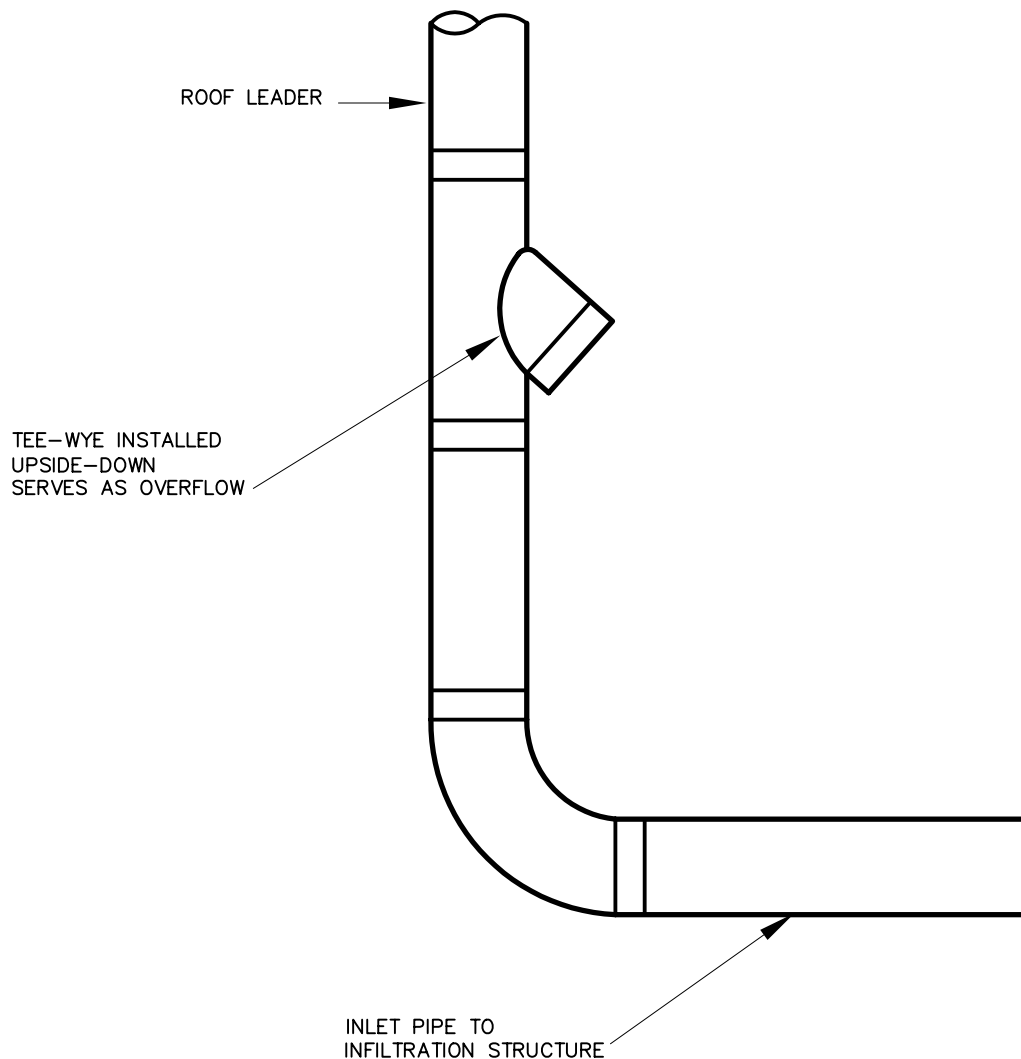
www.naugatuck-ct.gov

Scale: NTS

Drawing No.

SD-8

Date: 10/2011



ROOF LEADER CONNECTION

**BOROUGH OF NAUGATUCK
ENGINEERING DEPARTMENT
STANDARD DETAIL**

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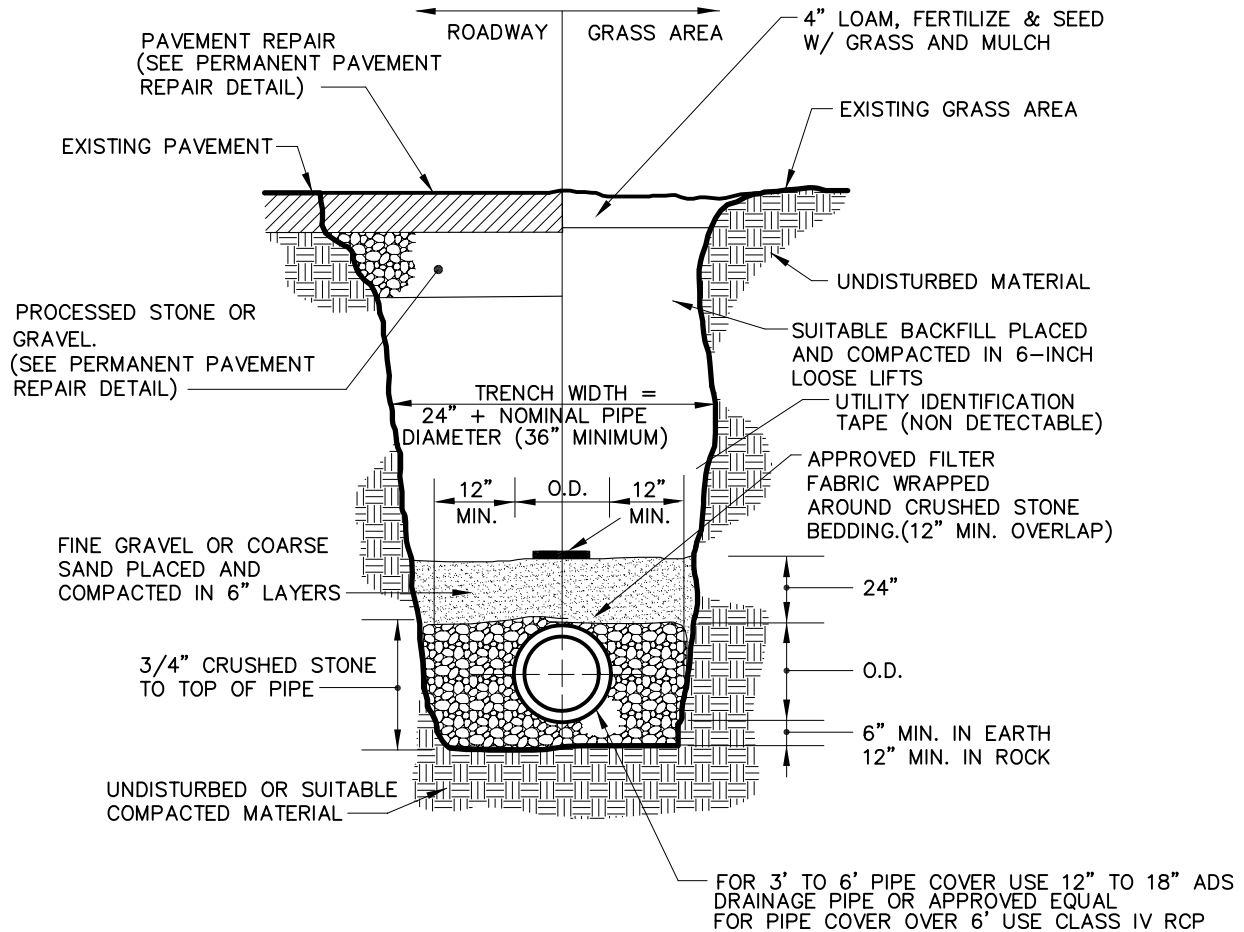
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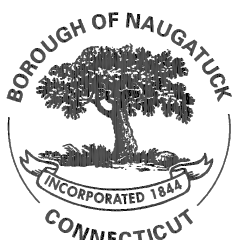
SD-10

Date: 10/2011



NOTES:

- 1) ALL PIPE SYSTEMS SHALL BE INSTALLED IN ACCORDANCE WITH STANDARD PRACTICE FOR UNDERGROUND INSTALLATION OF SEWER AND DRAINAGE PIPES AND OTHER GRAVITY FLOW APPLICATIONS.
- 2) ALL TRENCH WORK TO BE SUPPORTED AS REQUIRED.



TYPICAL PIPE TRENCH

**BOROUGH OF NAUGATUCK
ENGINEERING DEPARTMENT
STANDARD DETAIL**

229 Church Street, Naugatuck, CT 06770



www.naugatuck-ct.gov

Scale: NTS

Drawing No.

SD-11

Date:10/2011

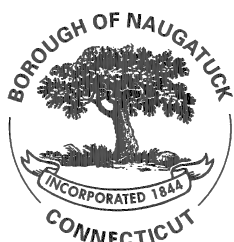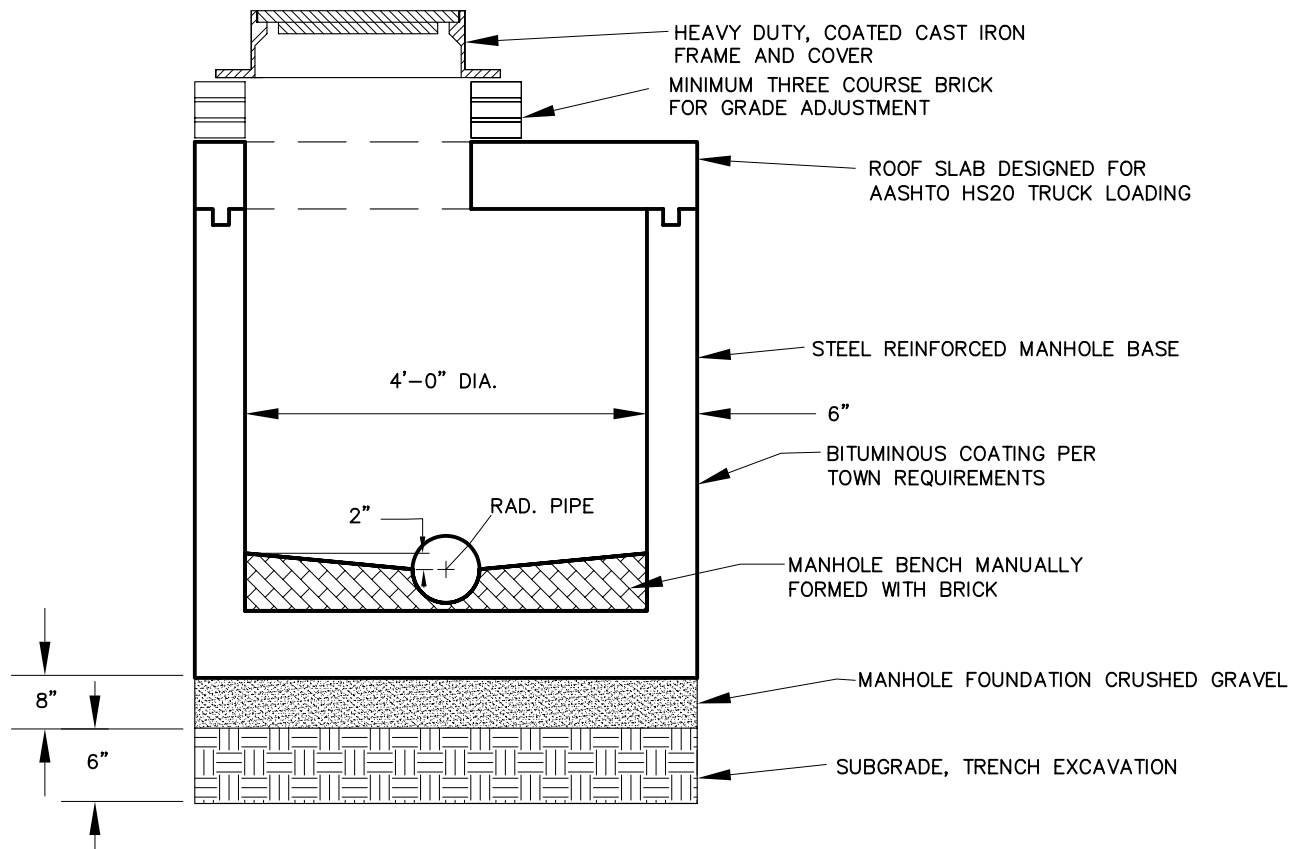

SHALLOW MANHOLE

**BOROUGH OF NAUGATUCK
ENGINEERING DEPARTMENT
STANDARD DETAIL**

229 Church Street, Naugatuck, CT 06770


www.naugatuck-ct.gov

Scale: NTS

Drawing No.

SD-12

Date: 10/2011

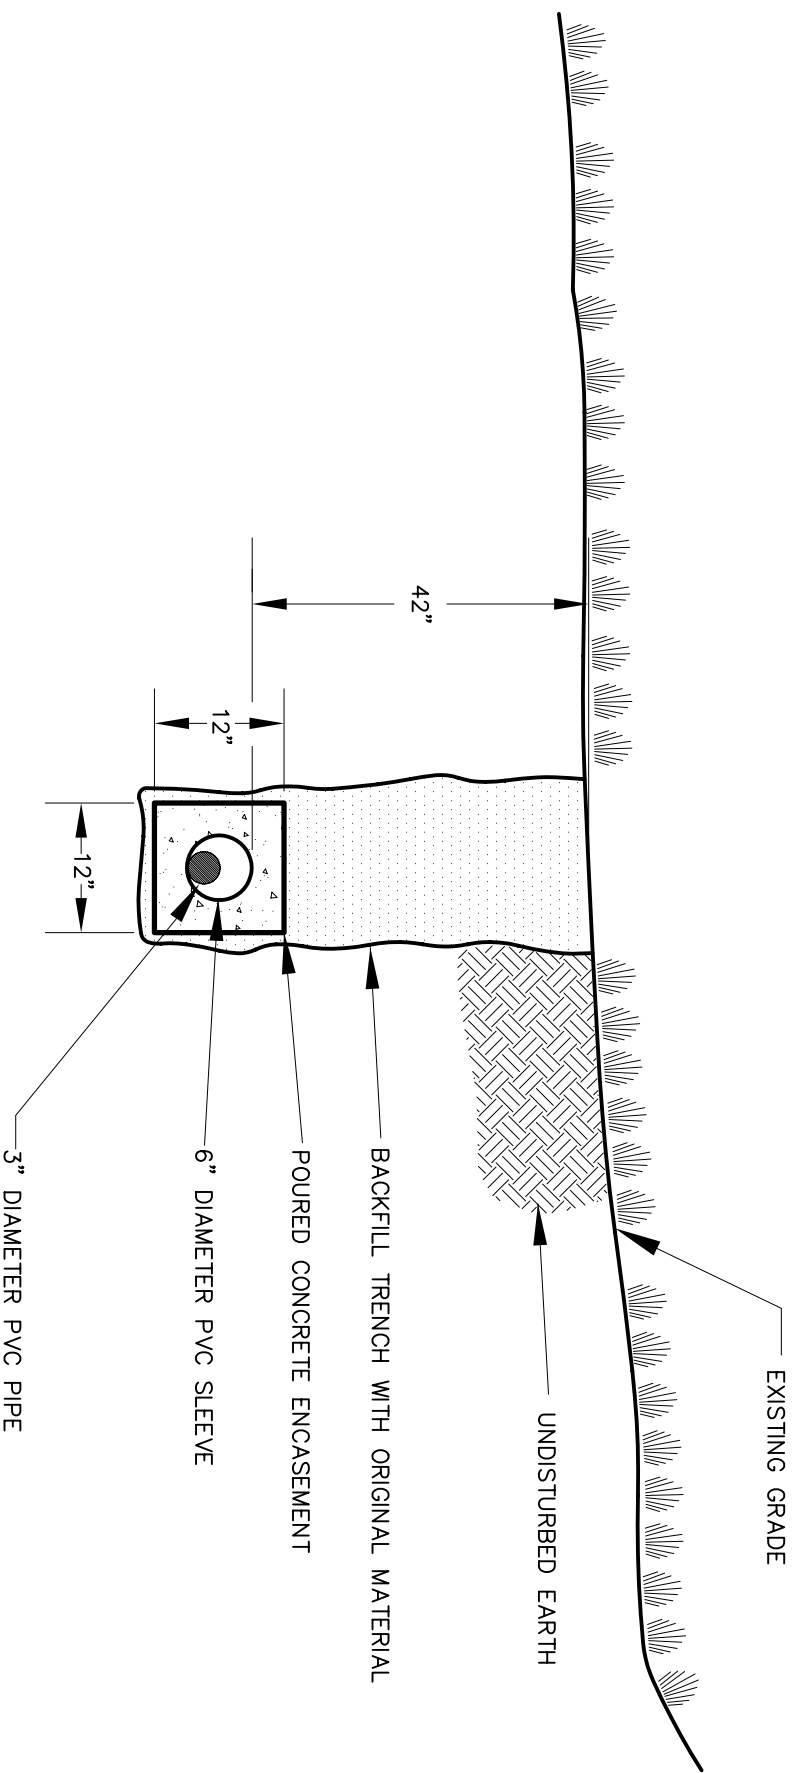

SEWER LINE CROSSING SECTION

**BOROUGH OF NAUGATUCK
ENGINEERING DEPARTMENT
STANDARD DETAIL**

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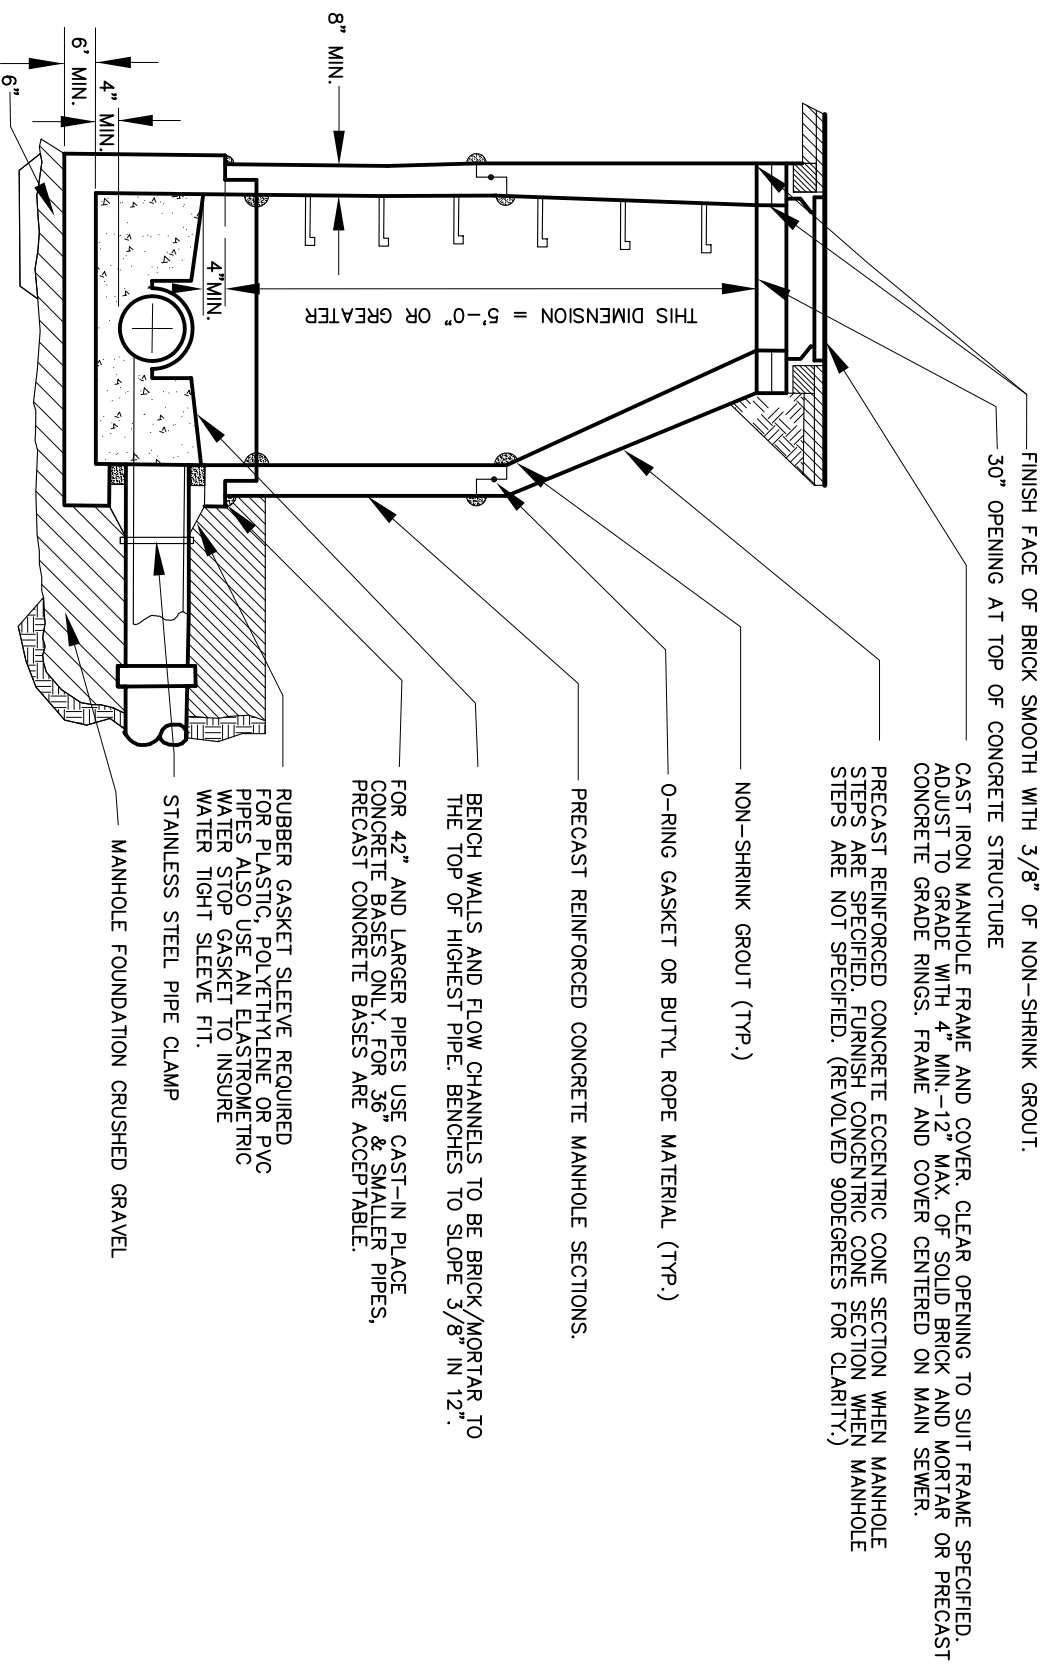
Scale: NTS

Drawing No.

SD-13

Date: 10/2011





SEWER MANHOLE

BOROUGH OF NAUGATUCK
 ENGINEERING DEPARTMENT
 STANDARD DETAIL

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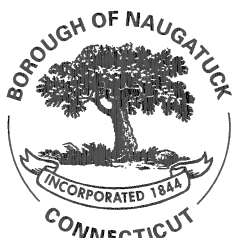
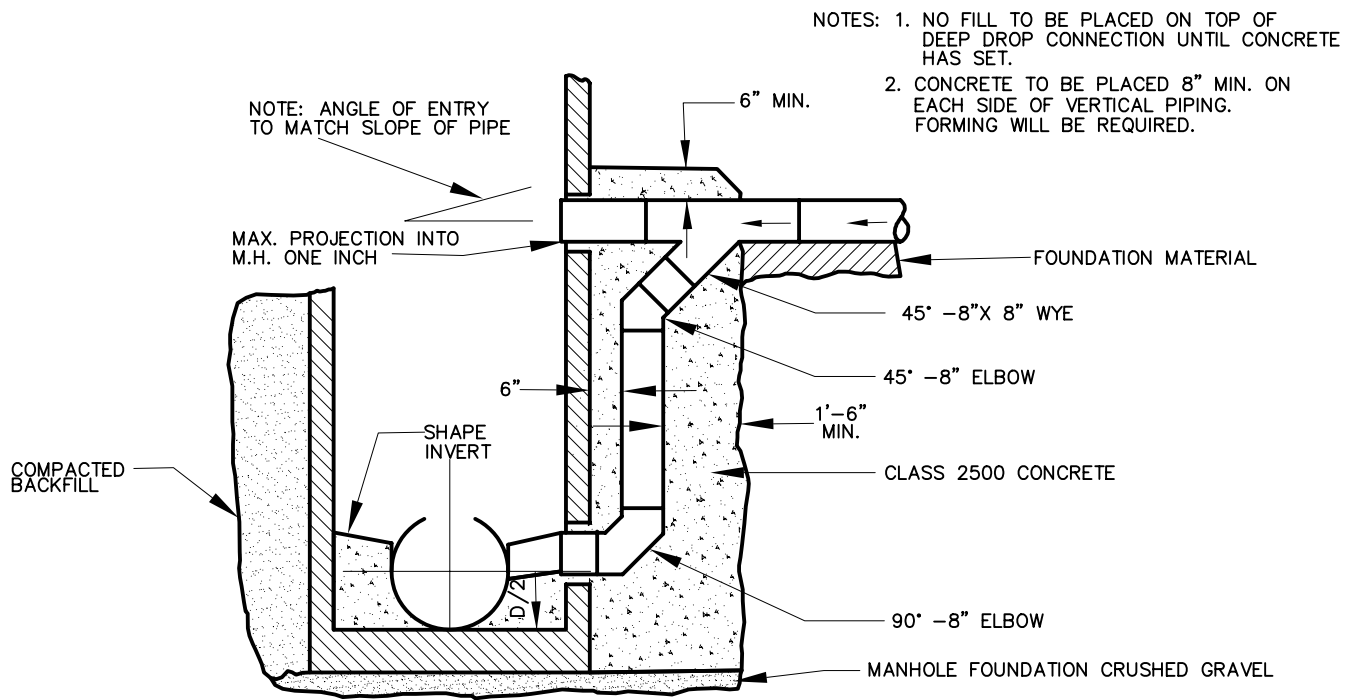
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Drawing No.

SD-14

Date: 10/2011





DEEP DROP MANHOLE CONNECTION (OUTSIDE DROP)

**BOROUGH OF NAUGATUCK
ENGINEERING DEPARTMENT
STANDARD DETAIL**

229 Church Street, Naugatuck, CT 06770



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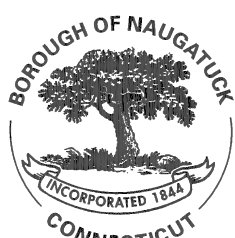
SD-16

Date: 10/2011



NOTES:

- 1.) THE END OF THE COMPLETED LATERAL SHALL BE LEFT EXPOSED UNTIL THE ENGINEER HAS TIME TO LOCATE THE LATERAL FOR AN AS-BUILT.
- 2.) FOR LATERAL CONNECTIONS TO EXISTING PIPE WHERE NO TEE IS PROVIDED, USE INJECTION MOLDED RUBBER GASKETED TEE SADDLE.

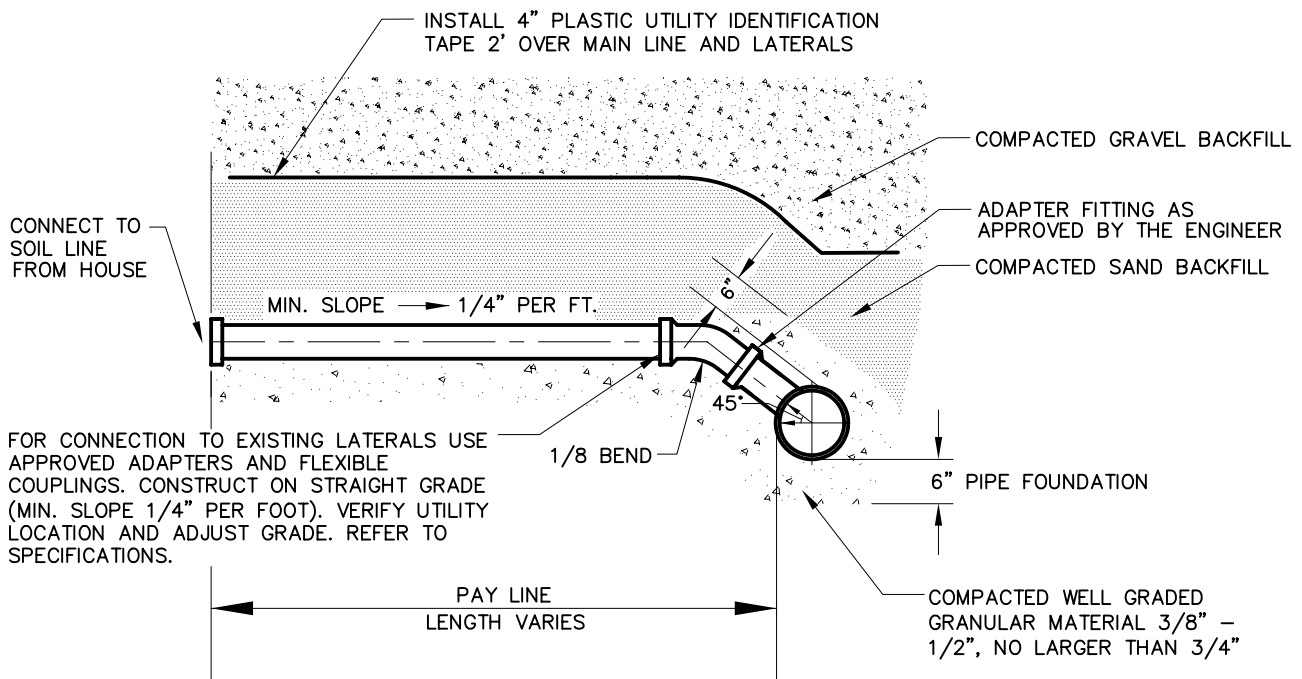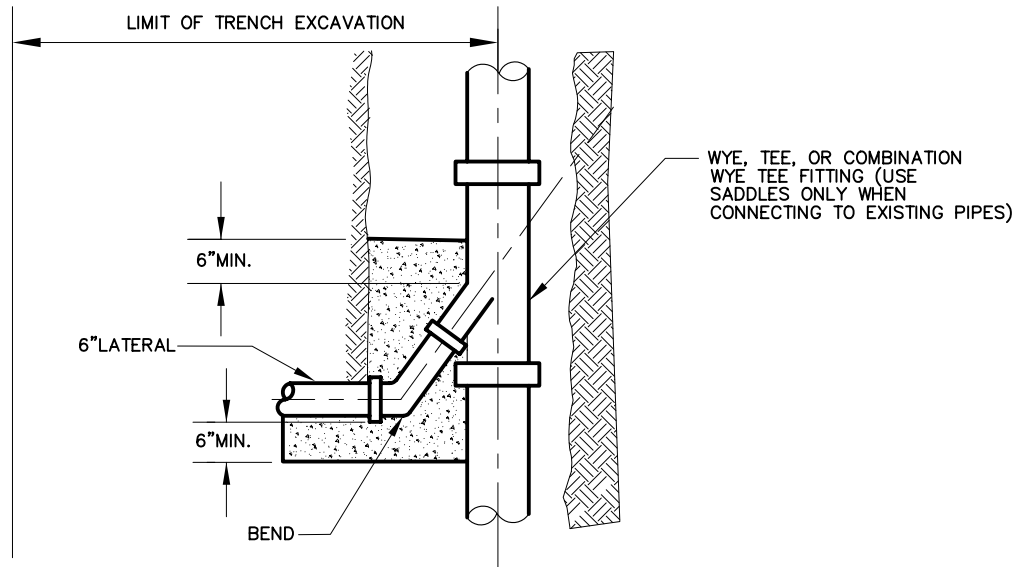

SANITARY SEWER LATERAL CONNECTION

**BOROUGH OF NAUGATUCK
ENGINEERING DEPARTMENT
STANDARD DETAIL**

229 Church Street, Naugatuck, CT 06770



www.naugatuck-ct.gov

Scale: NTS

Drawing No.

SD-17

Date: 10/2011

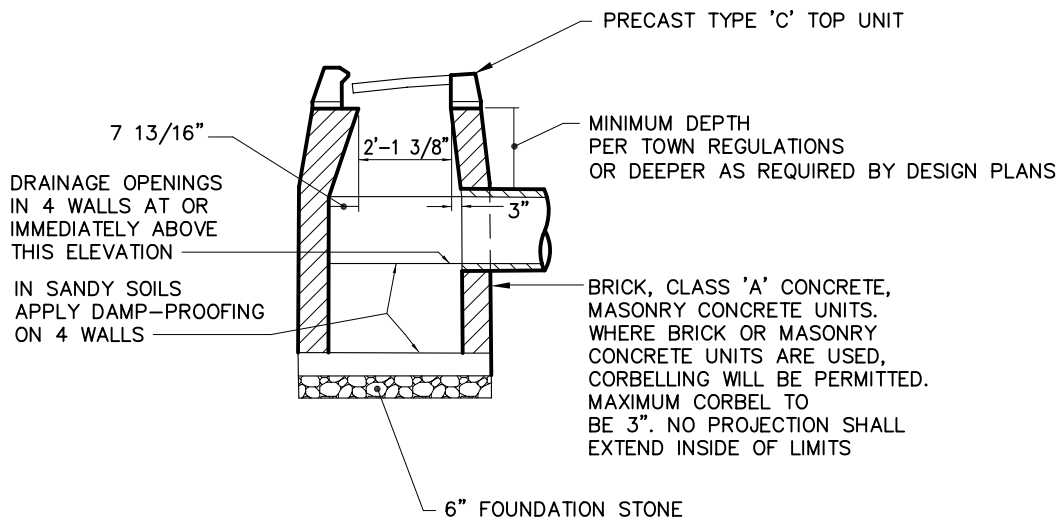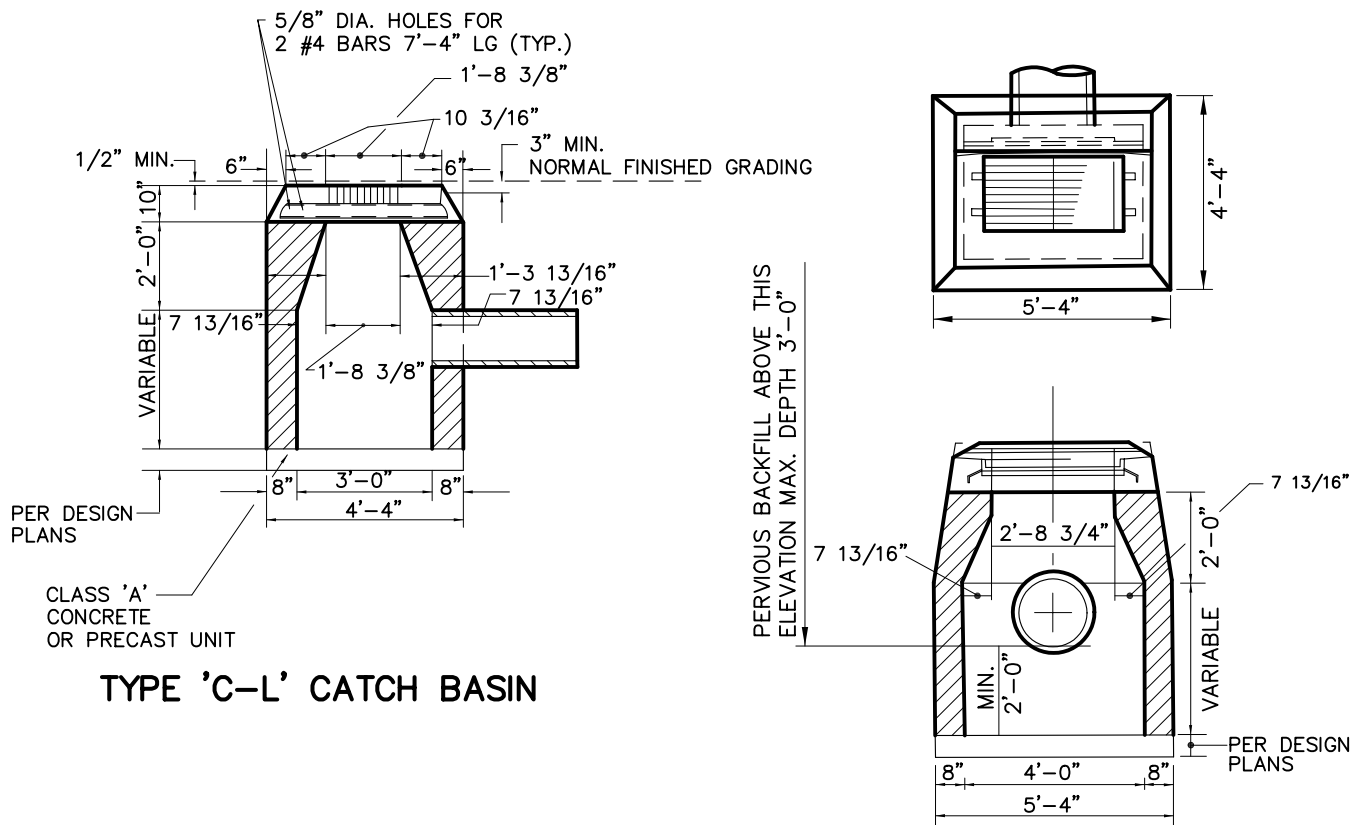

CATCH BASIN (ConnDOT)

**BOROUGH OF NAUGATUCK
ENGINEERING DEPARTMENT
STANDARD DETAIL**

229 Church Street, Naugatuck, CT 06770


www.naugatuck-ct.gov

Scale: NTS

Drawing No.

SD-19

Date: 10/2011

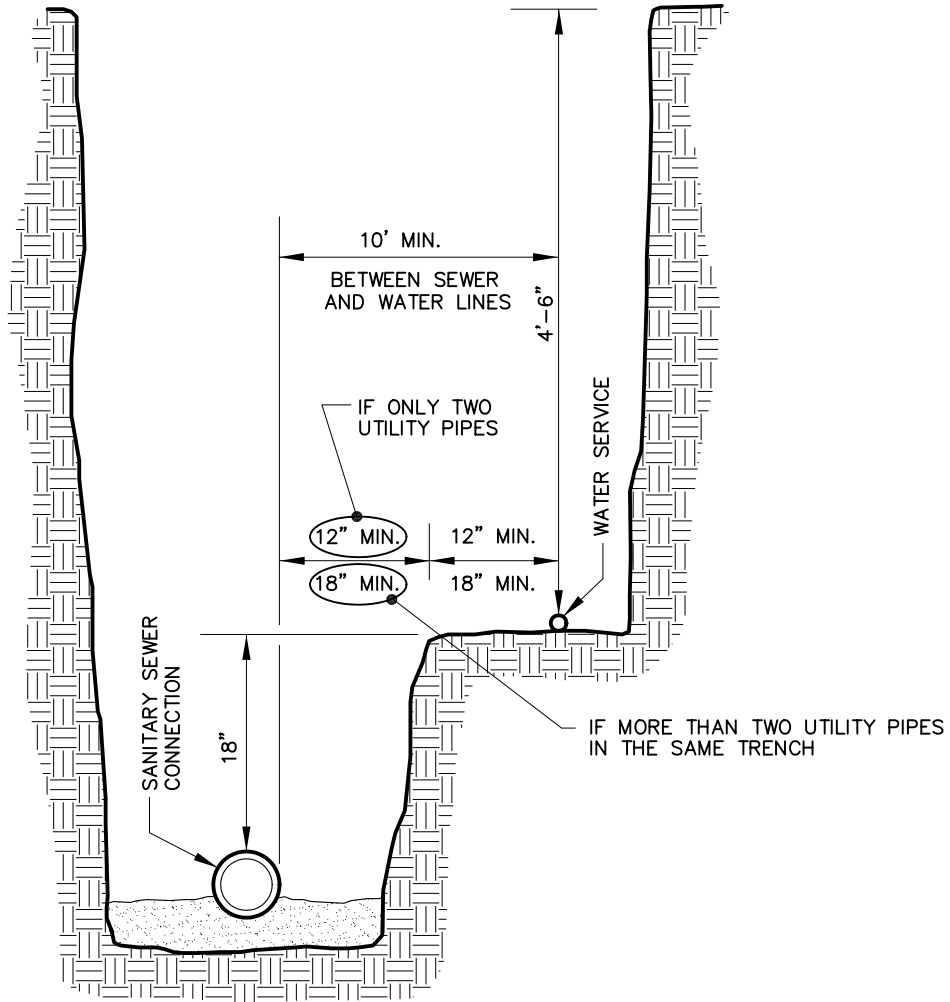

SANITARY SEWER HOUSE CONNECTION AND WATER SERVICE IN TRENCH

**BOROUGH OF NAUGATUCK
ENGINEERING DEPARTMENT
STANDARD DETAIL**

229 Church Street, Naugatuck, CT 06770


www.naugatuck-ct.gov

Scale: NTS

Drawing No.

SD-28

Date: 10/2011

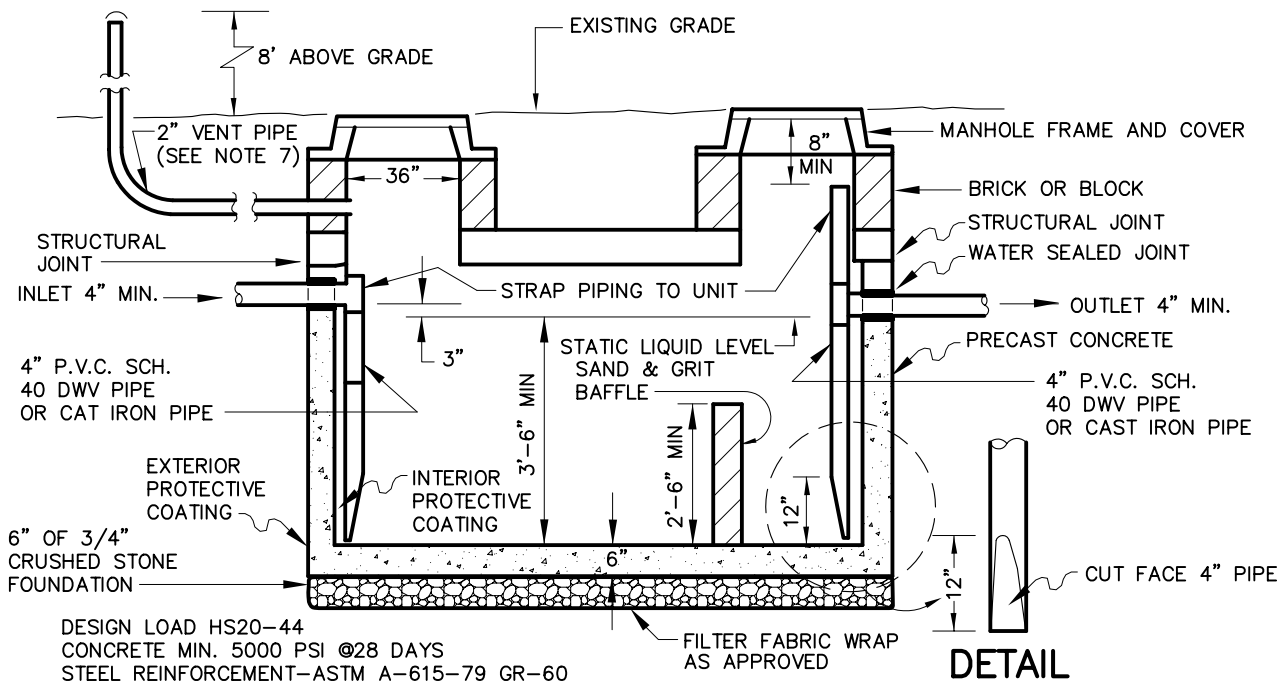

1. Tank shall have a minimum capacity sufficient to pre-treat the maximum daily flow proposed and no less than 1000 gallons. Tank shall be constructed of precast concrete.
2. Interior of the tank and extension to grade manholes shall be coated with an epoxy petroleum resistant sealant. Exterior of the tank and extension grade manholes shall be coated with a waterproof foundation sealant. This includes the tank exteriors top and bottom.
3. Structural seam of the tank shall be filled in with non-shrinking cement or water plug and coated with a waterproof sealant.
4. Voids between inlet and outlet piping of the tank shall be grouted with non-shrinking cement and coated with a waterproof sealant.
5. The tank shall have extensions to grade above the inlet and outlet piping. The extension shall have frames and manhole covers. The manholes, extensions and accesses to the tank shall be at least 24 inches in diameter.
6. The outlet piping shall utilize a tee-pipe on the interior of the tank. The tee-pipe shall be equipped with a stand pipe riser extending up the extension to grade but no closer than eight (8) inches from the manhole cover. The tee-pipe shall extend six (6) to twelve (12) inches from the bottom of the tank.
7. The inlet extension to grade shall be provided with a vent line which extends eight (8) feet above finished grade and properly secured to the building. The size of the vent shall be half the size of the outlet discharge line.
8. The horizontal structural seam of the tank shall be located above the static liquid level of the tank.
9. The incoming pipe shall not include any sources of domestic wastewater.
10. The outlet pipe shall be connected to the sanitary sewer.
11. The outlet pipe shall be at least the size of the inlet pipe or greater and at a minimum should be 4.0 inches in diameter.
12. If heavy piping, such as cast iron is used, all piping must be structurally secured.
13. The concrete covers provided by the oil separator manufacturer must be removed and discarded.



OIL-WATER SEPARATOR (GREASE TRAP)

**BOROUGH OF NAUGATUCK
ENGINEERING DEPARTMENT
STANDARD DETAIL**

229 Church Street, Naugatuck, CT 06770


www.naugatuck-ct.gov

Scale: NTS

Drawing No.

SD-32

Date: 10/2011

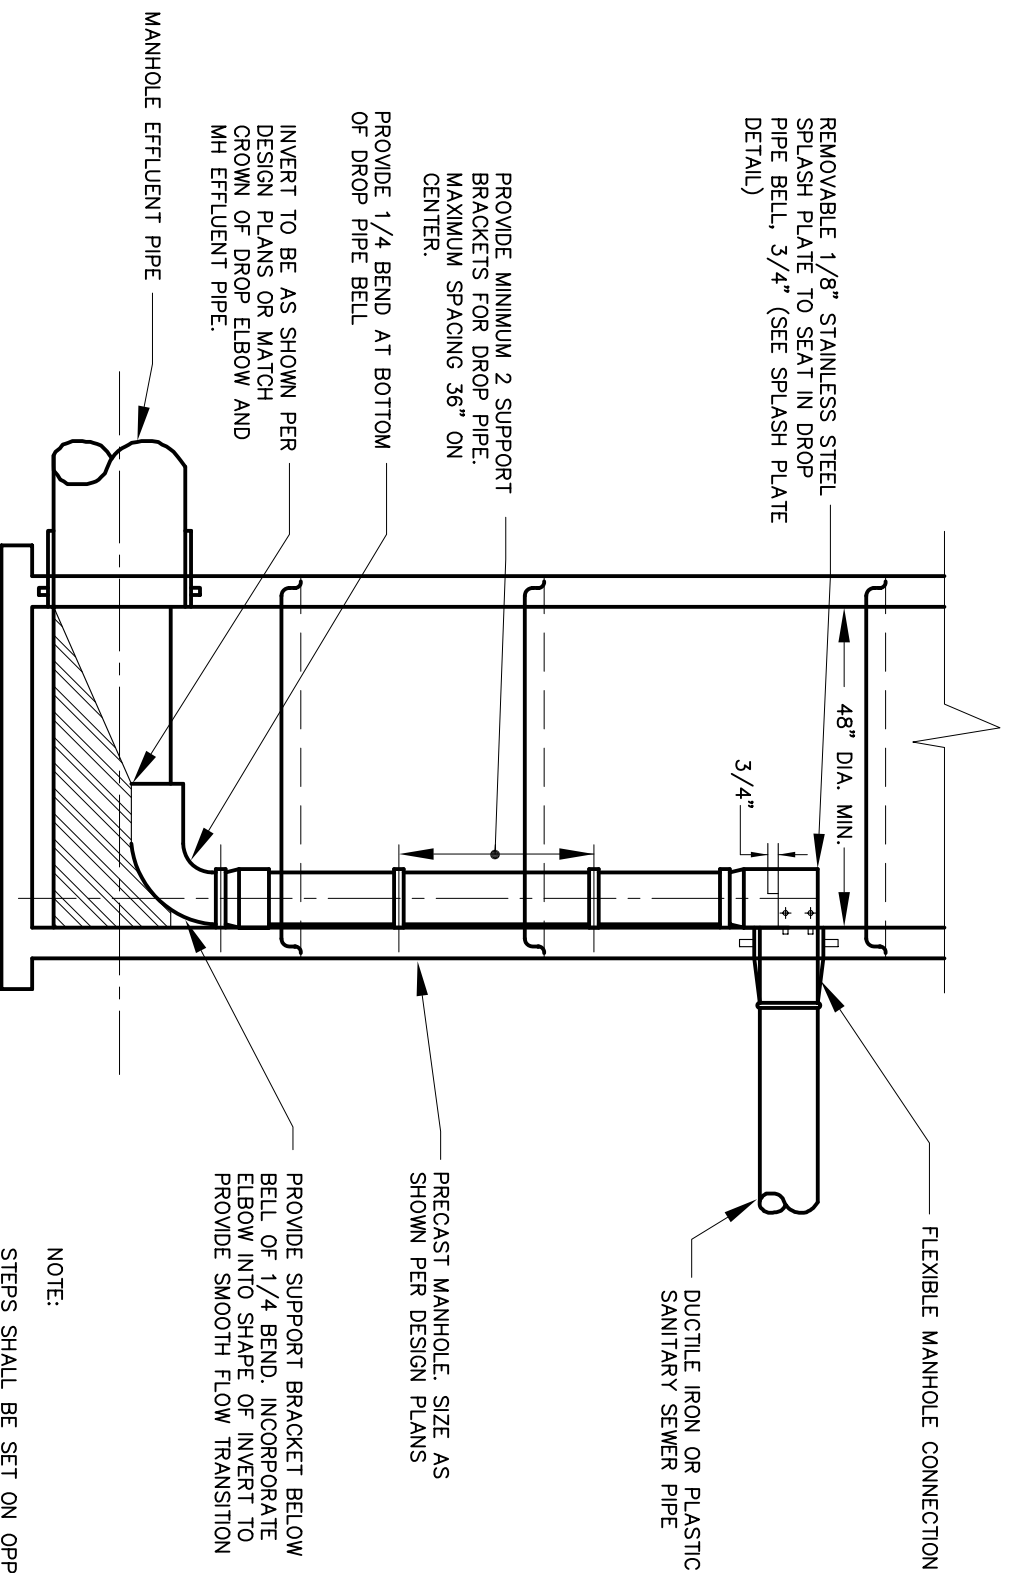

NOTE:

STEPS SHALL BE SET ON OPPOSITE SIDE OF MANHOLE THAN DROP PIPING.
 INSIDE MANHOLE DIAMETER TO BE 48"
 MINIMUM FOR ACCESS AND SERVICEABILITY.




INSIDE DROP MANHOLE
BOROUGH OF NAUGATUCK
ENGINEERING DEPARTMENT
STANDARD DETAIL

229 Church Street, Naugatuck, CT 06770 www.naugatuck-ct.gov

Scale: NTS
 Drawing No.

SD-49

Date: 10/2011

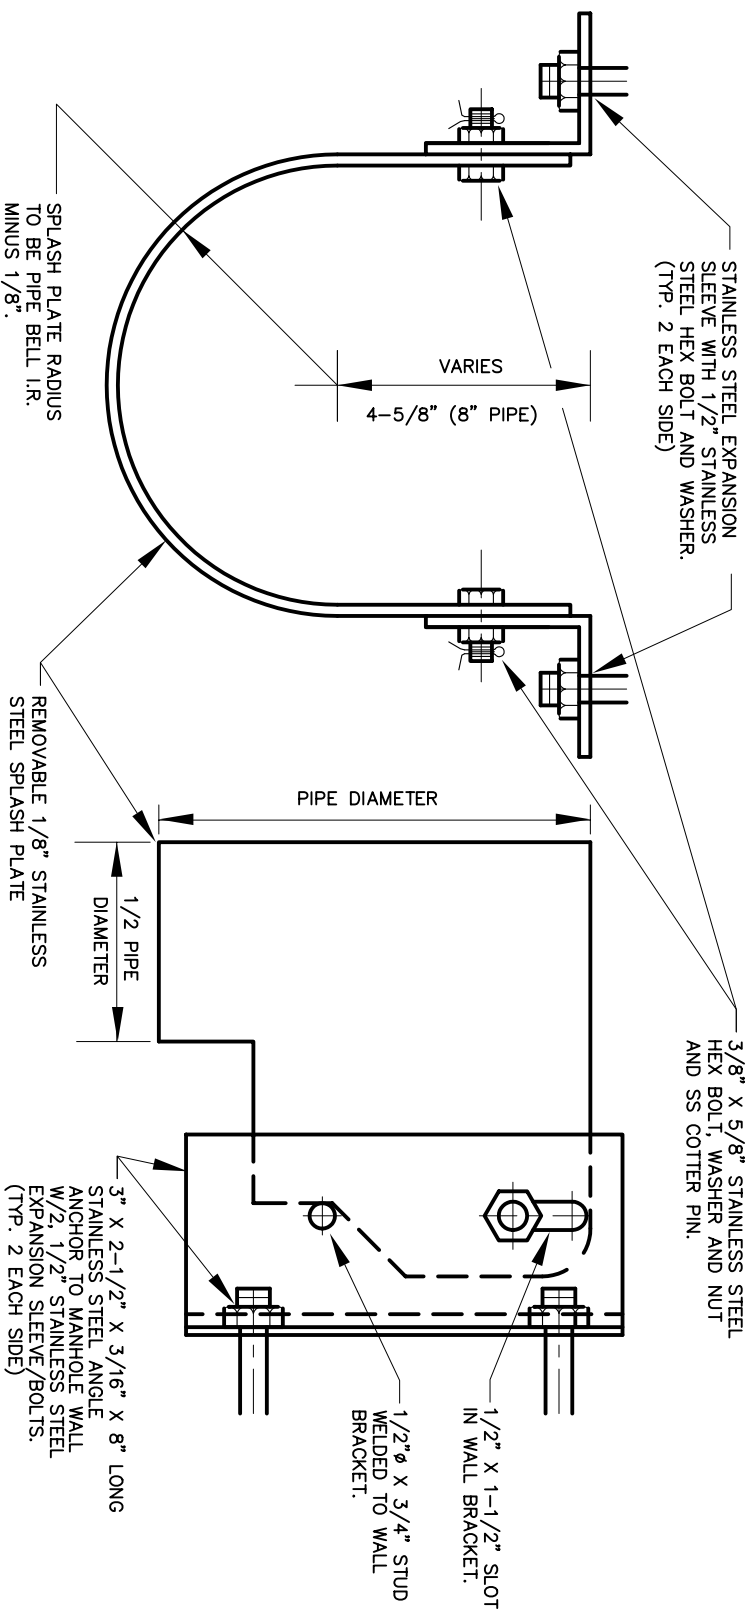

STAINLESS STEEL SPLASH PLATE

BOROUGH OF NAUGATUCK
ENGINEERING DEPARTMENT
STANDARD DETAIL

229 Church Street, Naugatuck, CT 06770

www.naugatuck-ct.gov


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Drawing No.


SD-50

Date: 10/2011



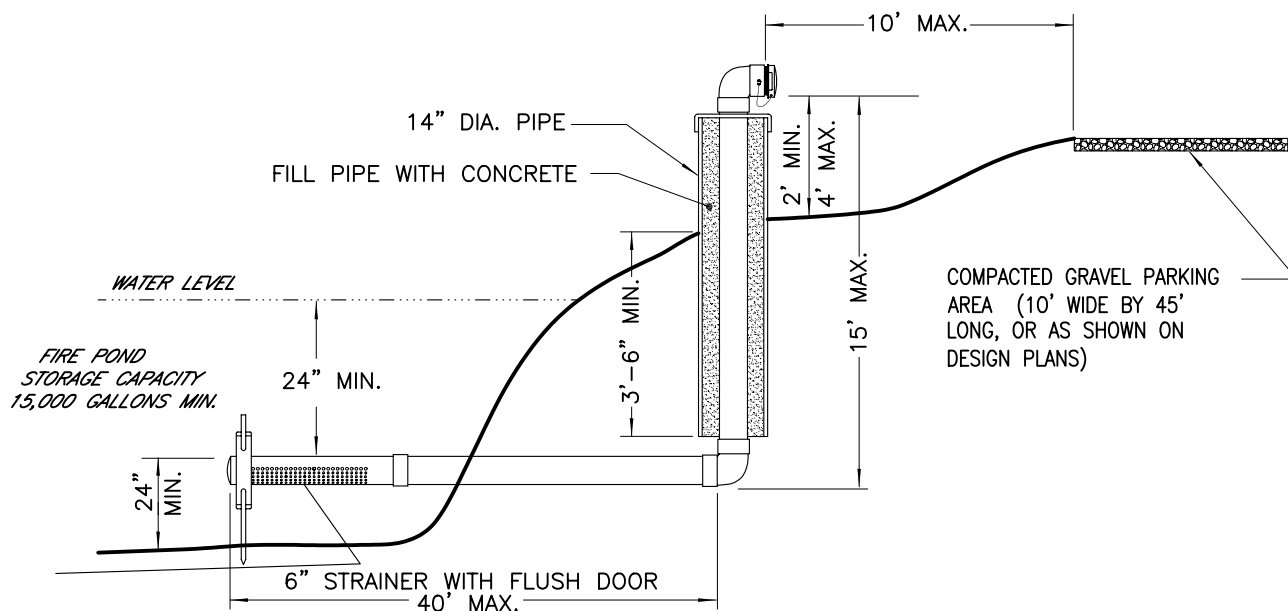

- 1.) ALL UNDERGROUND AND UNDERWATER PIPING SHALL BE PVC SCHEDULE 40 WITH A MINIMUM DIAMETER OF 6 INCHES.
- 2.) ALL JOINTS SHALL BE CLEANED AND SECURELY GLUED BEFORE BEING PLACED IN THE WATER. ALL JOINTS UNDERGROUND OR UNDERWATER WILL BE SCREWED WITH STAINLESS STEEL SCREWS ON EVERY JOINT AT LEAST THREE PLACES. GLUING OF JOINTS ABOVE GROUND OR ABOVE WATER IS ACCEPTABLE.
- 3.) ALL PIPING EXTENDING INTO THE WATER SUPPLY SHALL BE SUPPORTED ON AND SECURED TO CONCRETE OR STONE BLOCKS AT LEAST EVERY 10 FEET. THE STRAINER PORTION SHOULD BE SET A MINIMUM OF 24 INCHES OFF THE BOTTOM OF THE WATER SUPPLY. THE STRAINER AND HYDRANT HEAD TO BE PURCHASED FROM THE CONNECTICUT WATER CO. AT THEIR COST.
- 4.) HYDRANT RISER SHALL BE PROTECTED BY TWO STEEL CONCRETE FILLED POST 6 INCHES IN DIAMETER, PLACED 24 INCHES ON EITHER SIDE OF THE RISER AND EXTEND 48 INCHES ABOVE THE FINISH GRADE. THE POSTS SHALL BE EMBEDDED IN CONCRETE AFTER THE HYDRANT IS ACCEPTED BY THE CONNECTICUT WATER CO. POST SHALL BE PAINTED SAFETY YELLOW WITH 6 INCH RED BAND AT THE TOP.

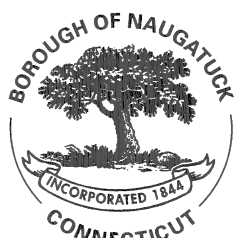

DRY HYDRANT

**BOROUGH OF NAUGATUCK
ENGINEERING DEPARTMENT
STANDARD DETAIL**

229 Church Street, Naugatuck, CT 06770


www.naugatuck-ct.gov

Scale: NTS

Drawing No.

SD-52

Date: 10/2011

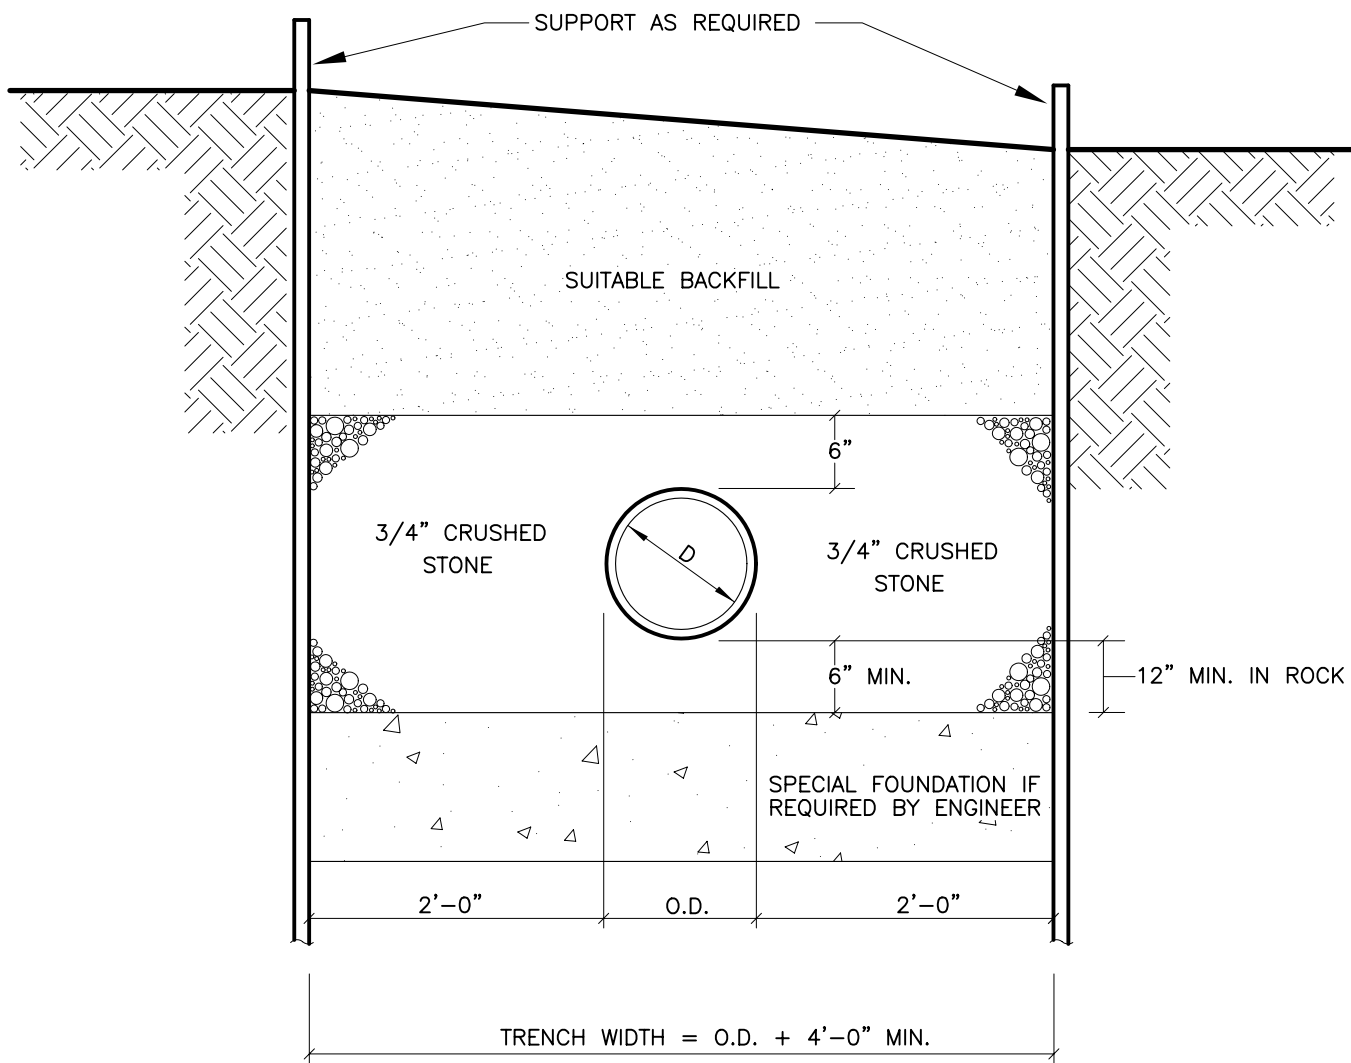

TYPICAL SANITARY SEWER TRENCH

**BOROUGH OF NAUGATUCK
ENGINEERING DEPARTMENT
STANDARD DETAIL**

229 Church Street, Naugatuck, CT 06770


www.naugatuck-ct.gov

Scale: NTS

Drawing No.

SD-53

Date: 10/2011

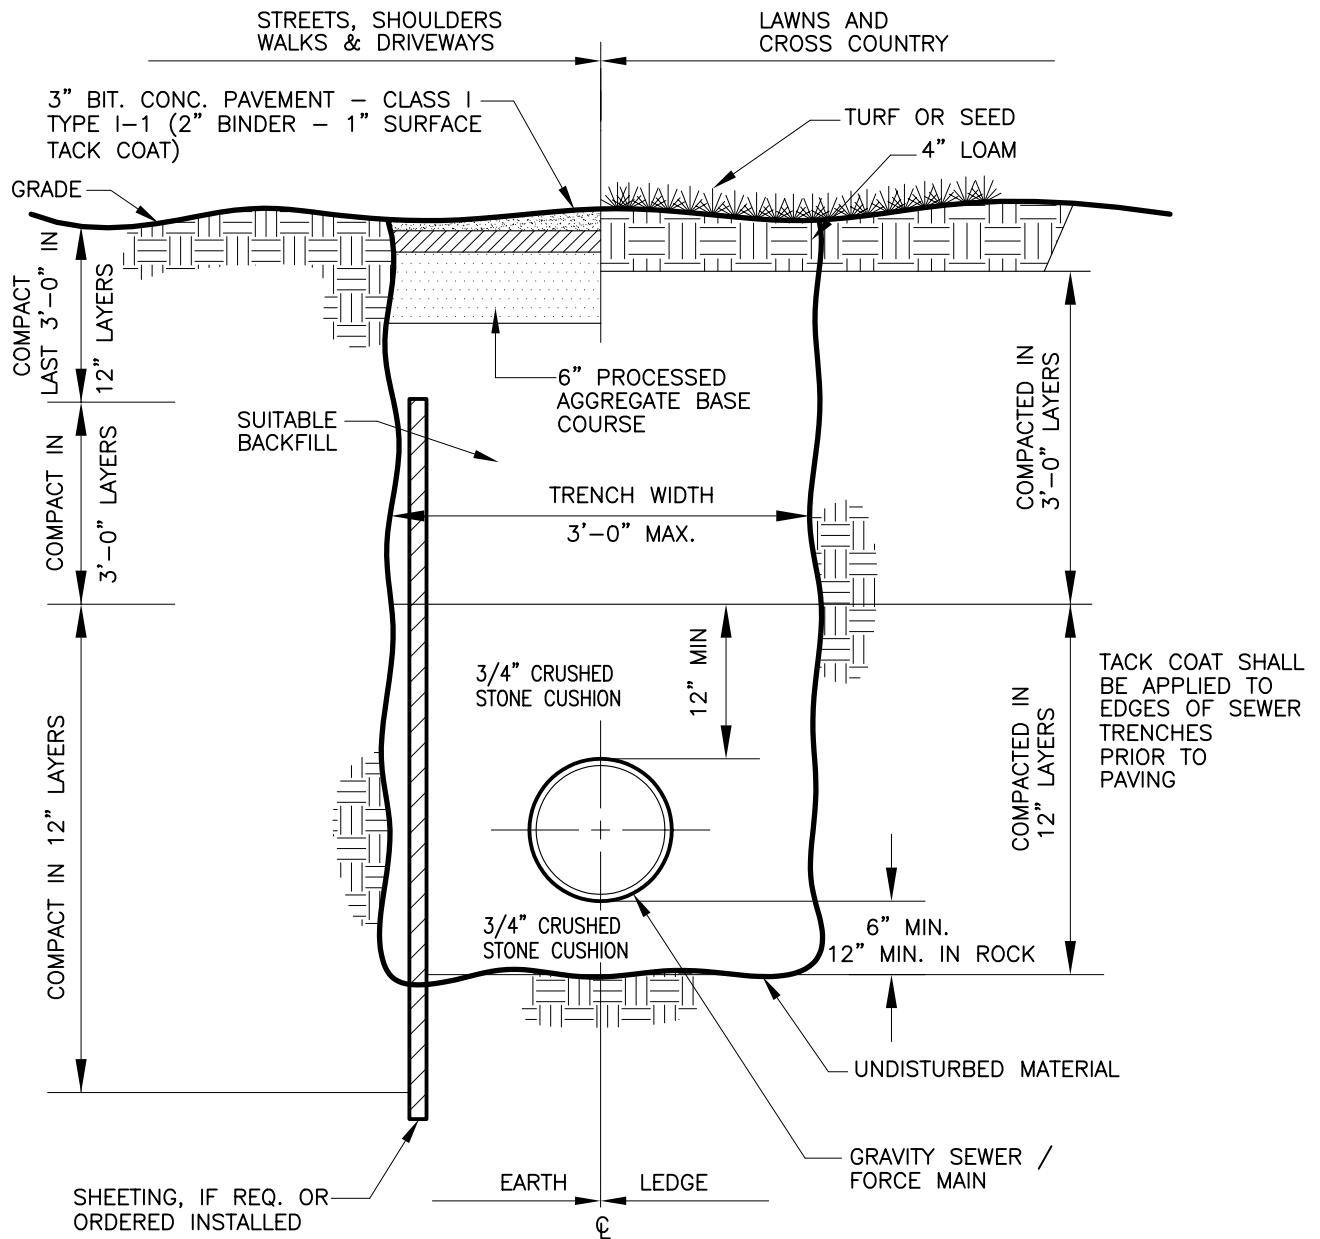

TYPICAL SANITARY SEWER LATERAL TRENCH

**BOROUGH OF NAUGATUCK
ENGINEERING DEPARTMENT
STANDARD DETAIL**

229 Church Street, Naugatuck, CT 06770


www.naugatuck-ct.gov

Scale: NTS

Drawing No.

SD-54

Date: 10/2011

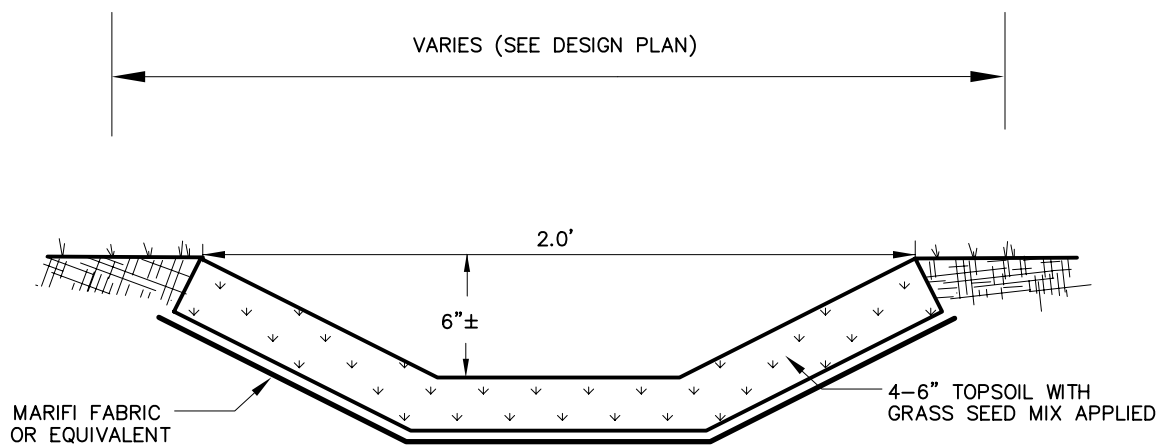

SMALL DRAINAGE SWALE (GRASS)

**BOROUGH OF NAUGATUCK
ENGINEERING DEPARTMENT
STANDARD DETAIL**

229 Church Street, Naugatuck, CT 06770


www.naugatuck-ct.gov

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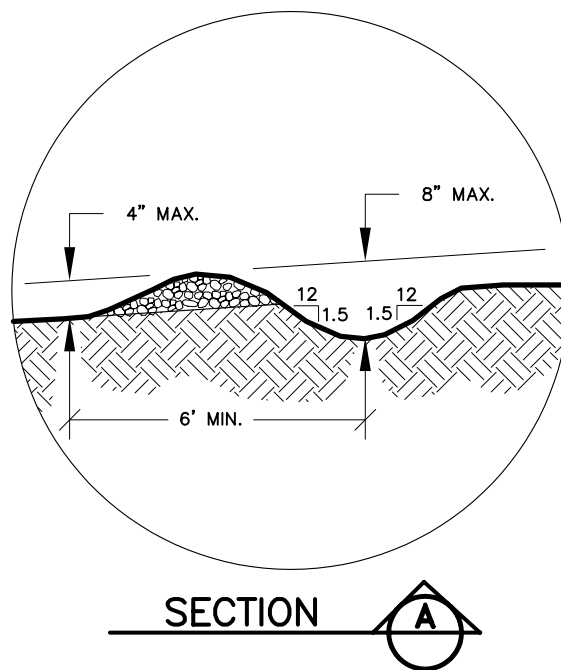
Drawing No.

SD-31

Date: 10/2011

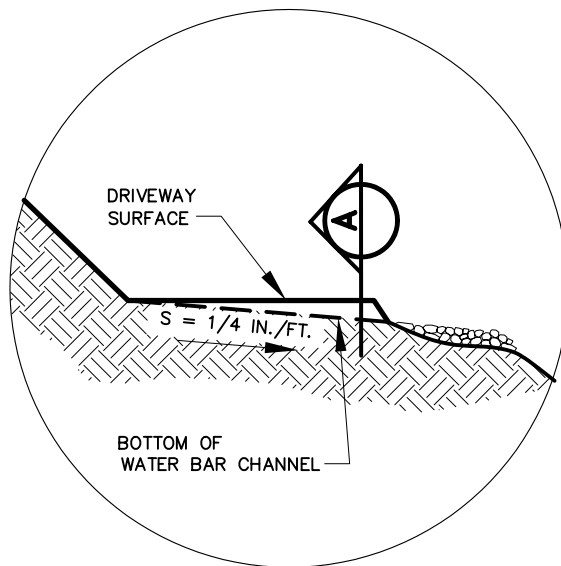

WATER BAR OR WATER BREAK



SECTION



WATER BAR OR WATER BREAK

BOROUGH OF NAUGATUCK
ENGINEERING DEPARTMENT
STANDARD DETAIL

229 Church Street, Naugatuck, CT 06770


www.naugatuck-ct.gov

Scale: NTS

Drawing No.

SD-55

Date: 10/2011

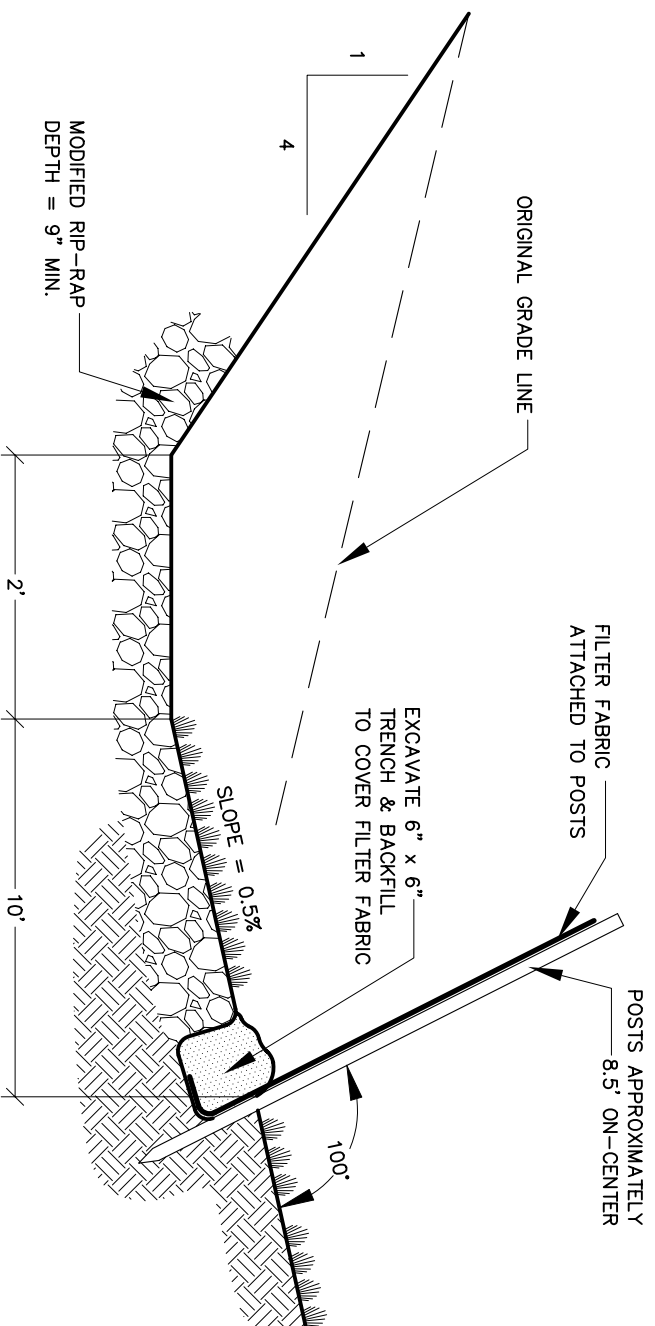

RIP-RAP LEVEL SPREADER

BOROUGH OF NAUGATUCK
 ENGINEERING DEPARTMENT
 STANDARD DETAIL


229 Church Street, Naugatuck, CT 06770 www.naugatuck-ct.gov

Scale: NTS

Drawing No.

SD-56

Date: 10/2011

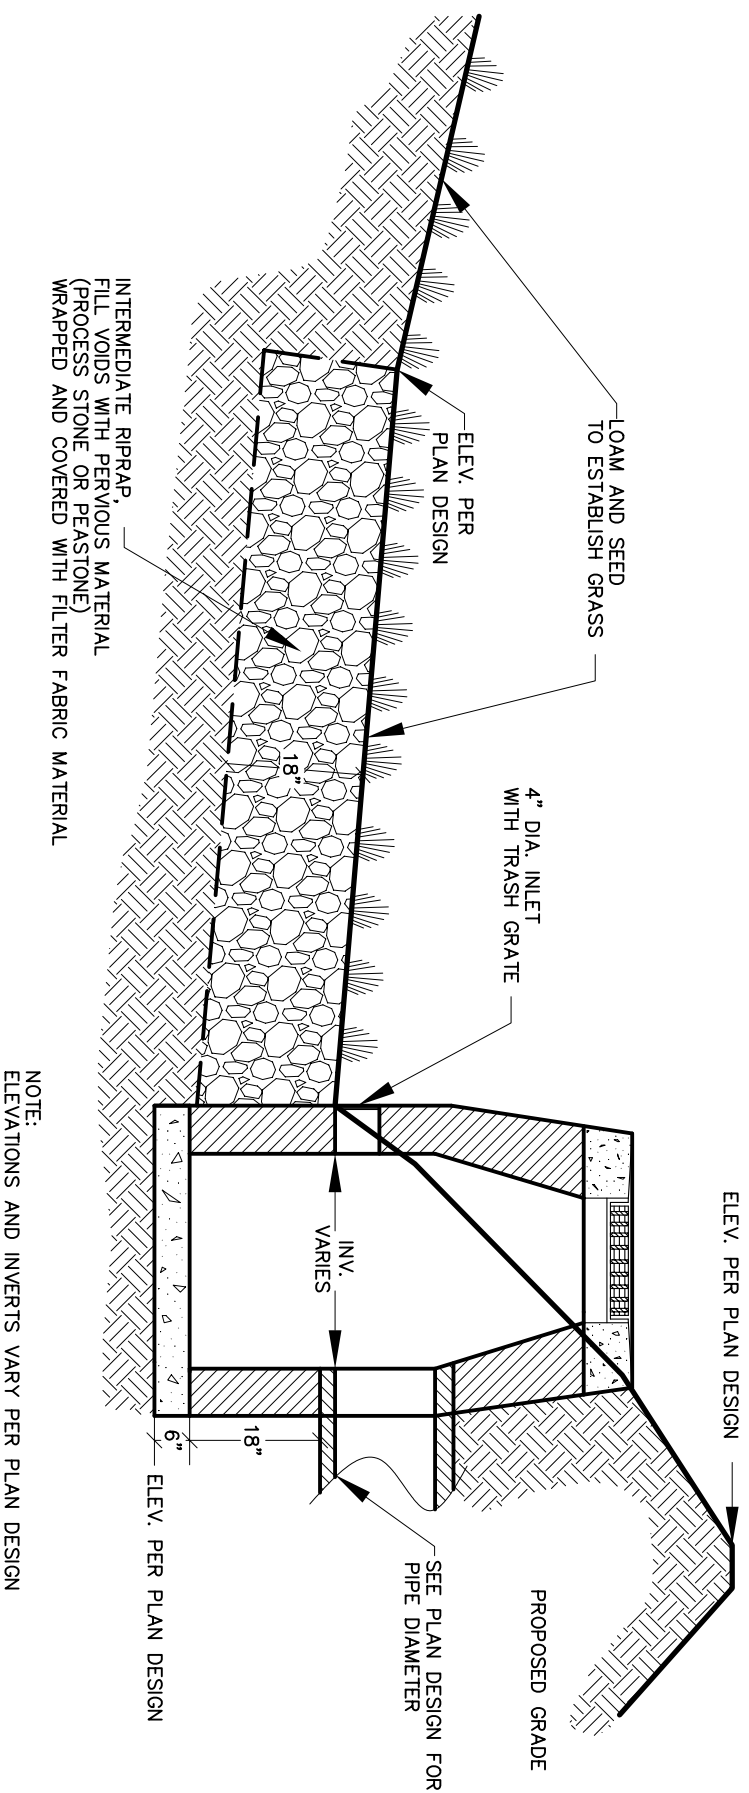

RETENTION BASIN EXAMPLE

**BOROUGH OF NAUGATUCK
ENGINEERING DEPARTMENT
STANDARD DETAIL**

229 Church Street, Naugatuck, CT 06770

www.naugatuck-ct.gov




Scale: NTS

Drawing No.

SD-57

Date: 10/2011

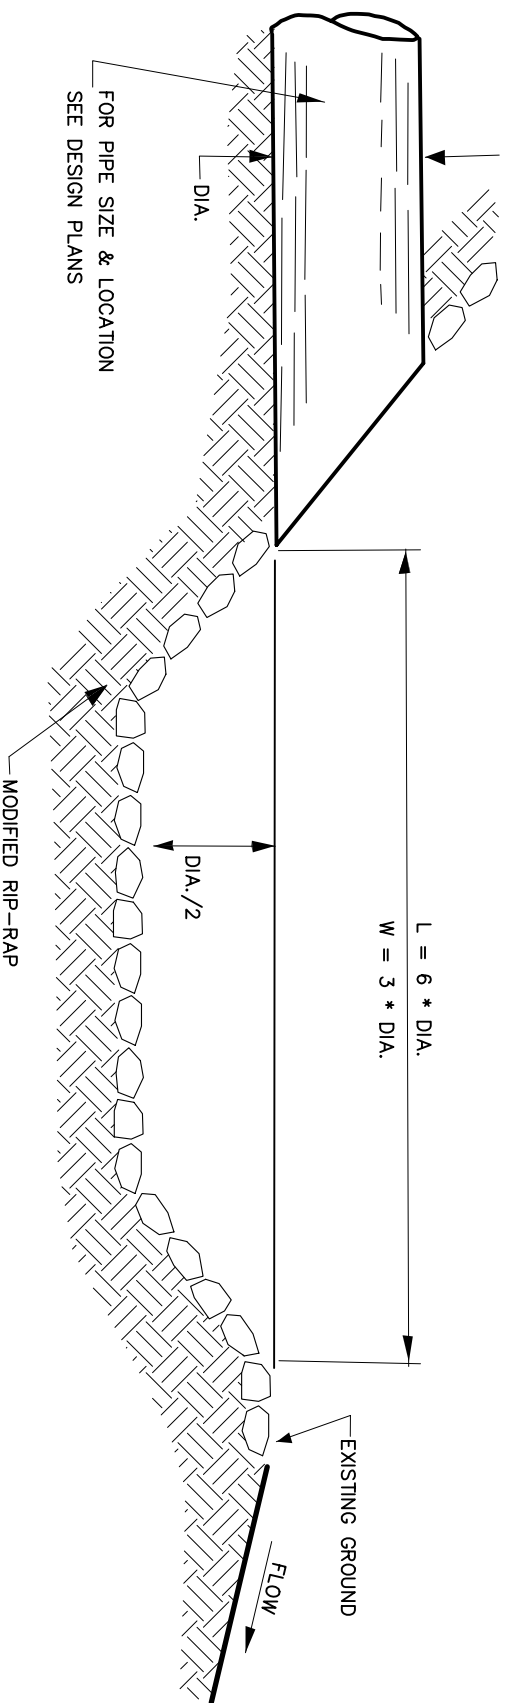

NOTE:
PLUNGE POOL TO BE SIZED ACCORDING TO DESIGN PLANS



PLUNGE POOL

**BOROUGH OF NAUGATUCK
ENGINEERING DEPARTMENT
STANDARD DETAIL**


229 Church Street, Naugatuck, CT 06770 www.naugatuck-ct.gov

Scale: NTS

Drawing No.

SD-58

Date: 10/2011

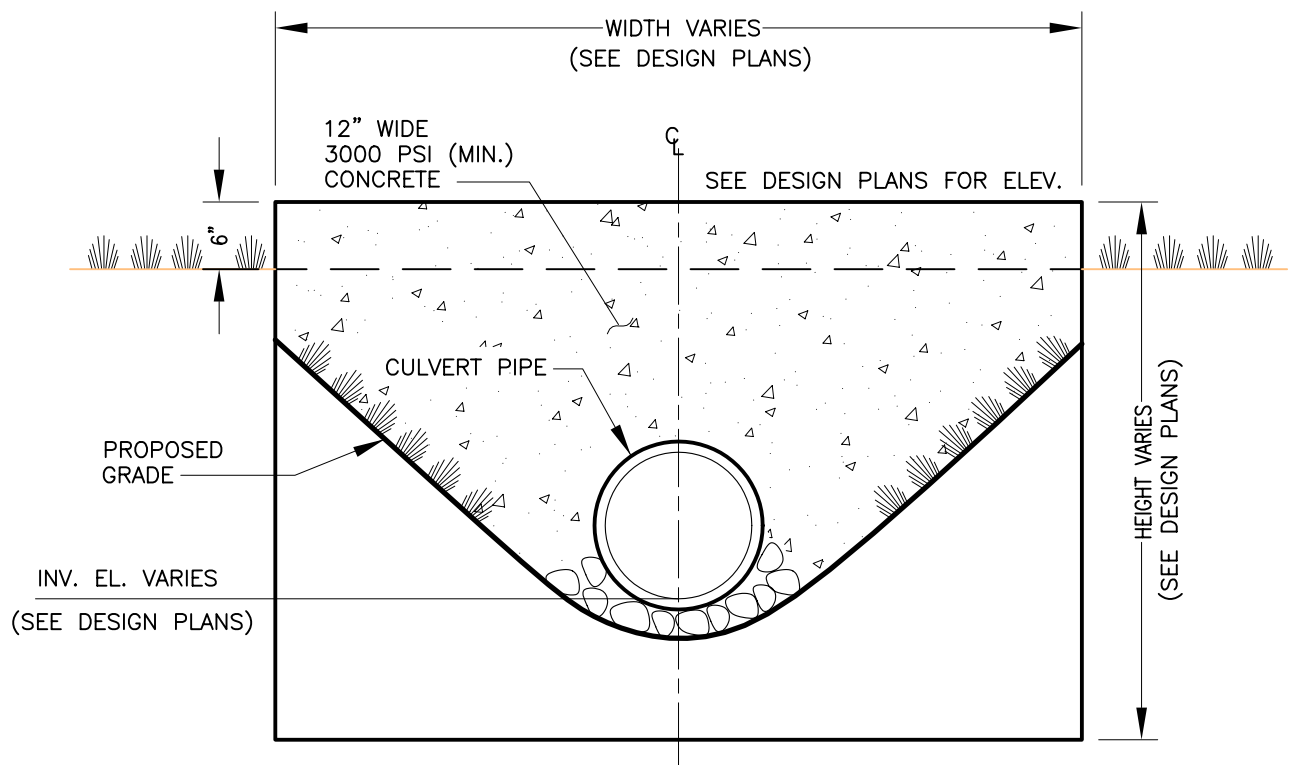

HEADWALL

**BOROUGH OF NAUGATUCK
ENGINEERING DEPARTMENT
STANDARD DETAIL**

229 Church Street, Naugatuck, CT 06770


www.naugatuck-ct.gov

Scale: NTS

Drawing No.

SD-59

Date: 10/2011

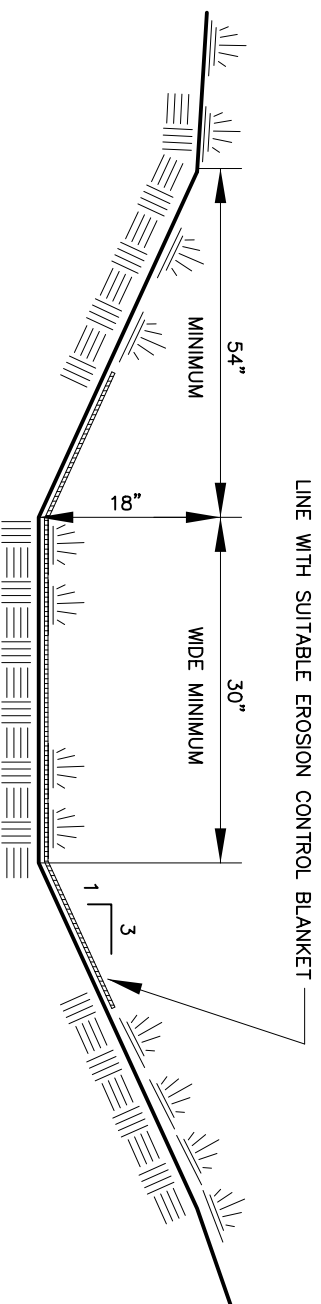


LARGE DRAINAGE SWALE (GRASS)

BOROUGH OF NAUGATUCK
ENGINEERING DEPARTMENT
STANDARD DETAIL

229 Church Street, Naugatuck, CT 06770 www.naugatuck-ct.gov

Scale: NTS
Drawing No.
SD-60
Date: 10/2011



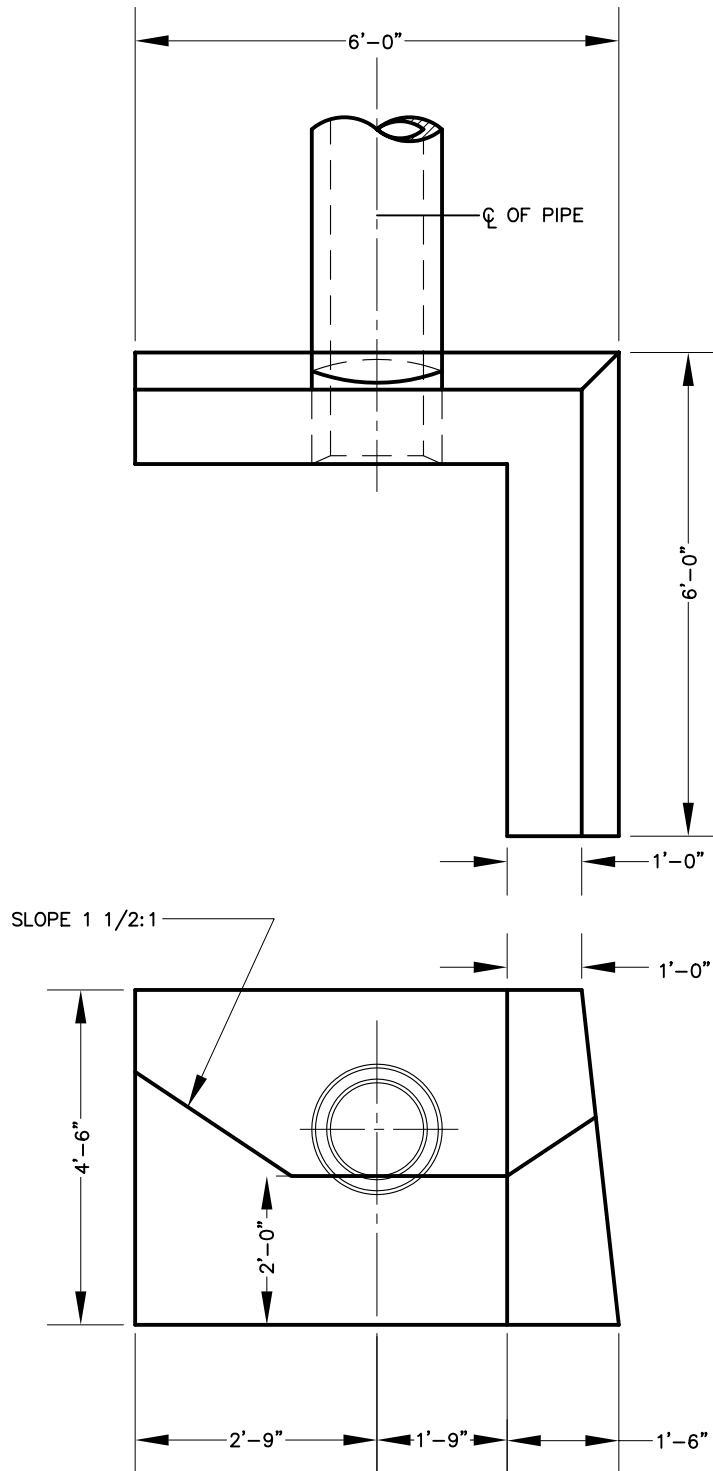

TYPE "L" ENDWALL

**BOROUGH OF NAUGATUCK
ENGINEERING DEPARTMENT
STANDARD DETAIL**

229 Church Street, Naugatuck, CT 06770


www.naugatuck-ct.gov

Scale: NTS

Drawing No.

SD-61

Date: 10/2011

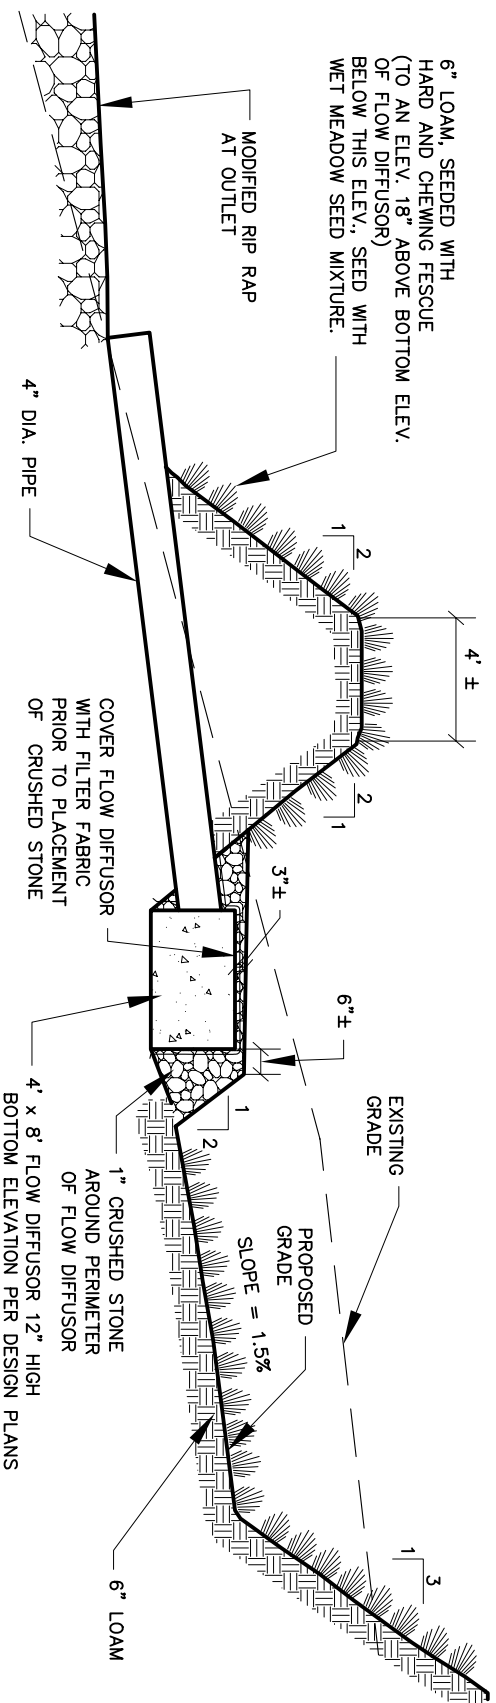

NOTE:
ELEVATIONS AND INVERTS PER DESIGN PLANS

DRY RETENTION BASIN EXAMPLE

**BOROUGH OF NAUGATUCK
ENGINEERING DEPARTMENT
STANDARD DETAIL**

229 Church Street, Naugatuck, CT 06770

www.naugatuck-ct.gov


Scale: NTS

Drawing No.

SD-62

Date: 10/2011



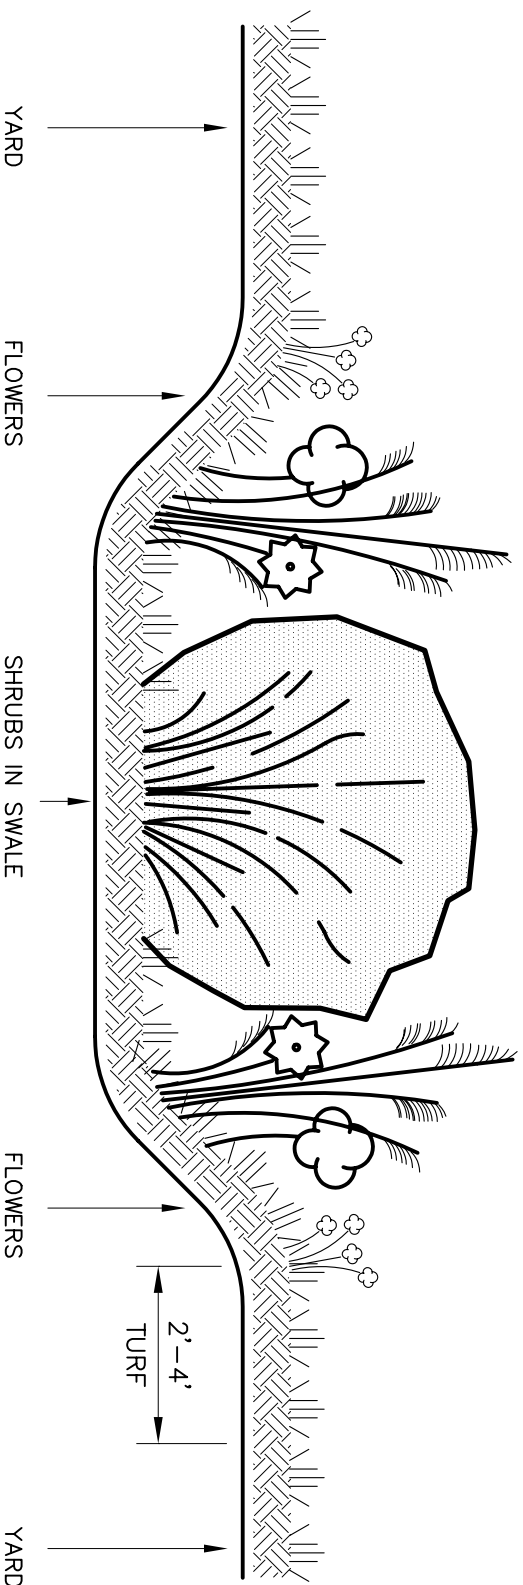

TYPICAL RESIDENTIAL RAIN GARDEN

BOROUGH OF NAUGATUCK
ENGINEERING DEPARTMENT
STANDARD DETAIL

229 Church Street, Naugatuck, CT 06770 www.naugatuck-ct.gov




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Drawing No.


SD-9

Date: 10/2011

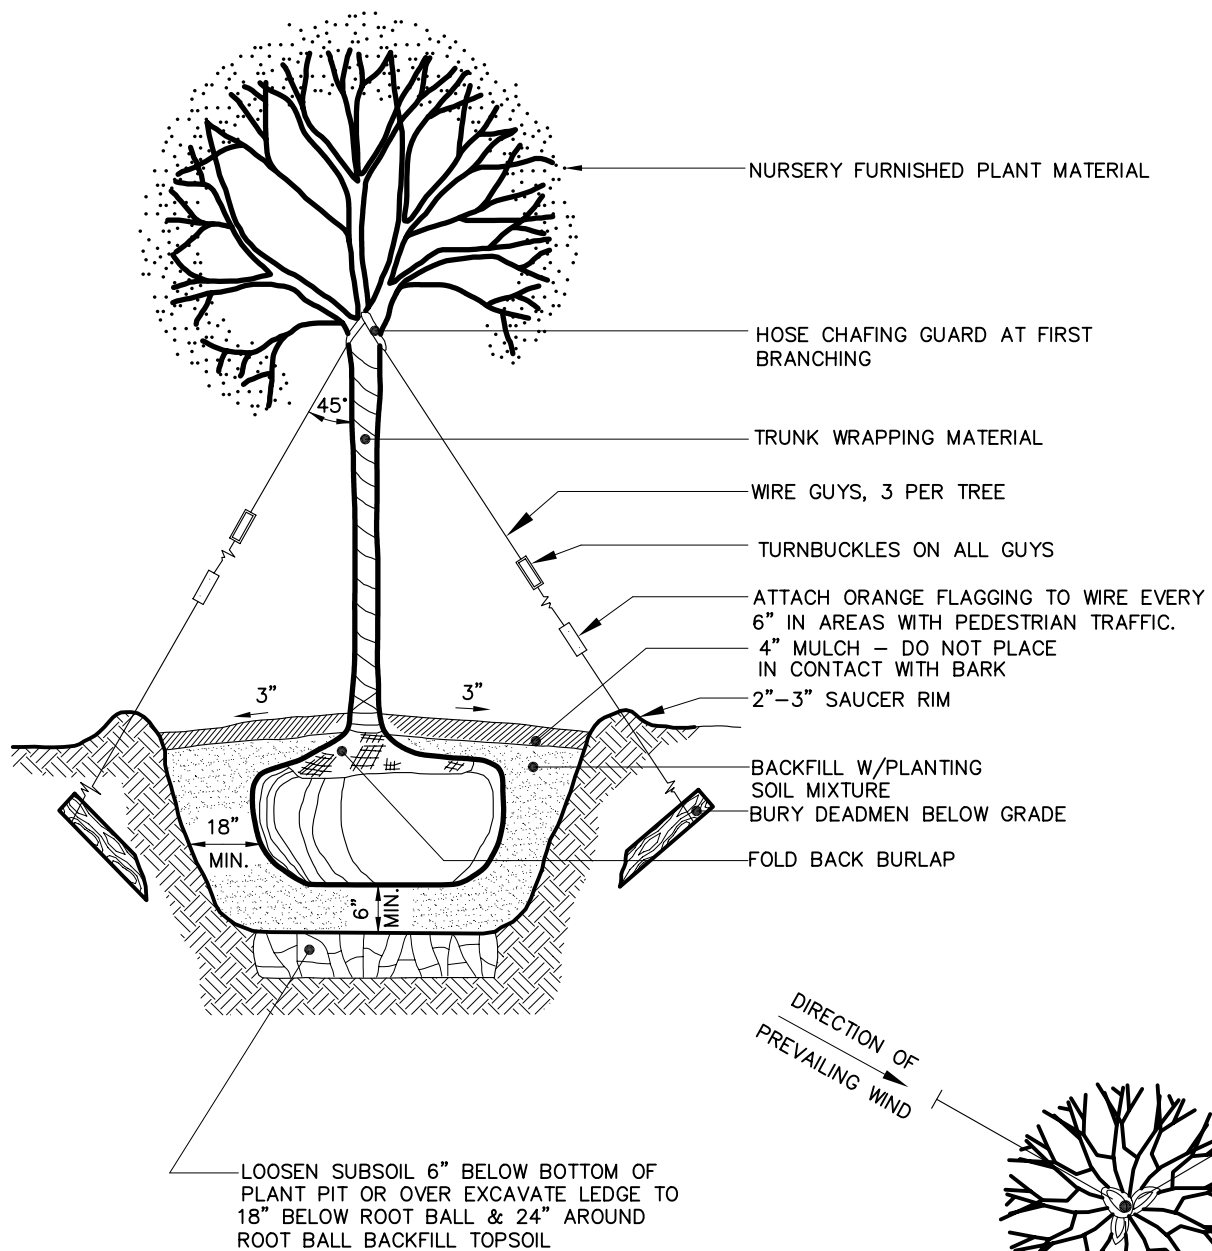


NOTE:
ALL TREES PLANTED WITHIN PARKING LOT ISLANDS SHALL
BE INSTALLED WITH A ROOT BARRIER. (SEE TREE WELL DETAIL.)

TREE PLANTING

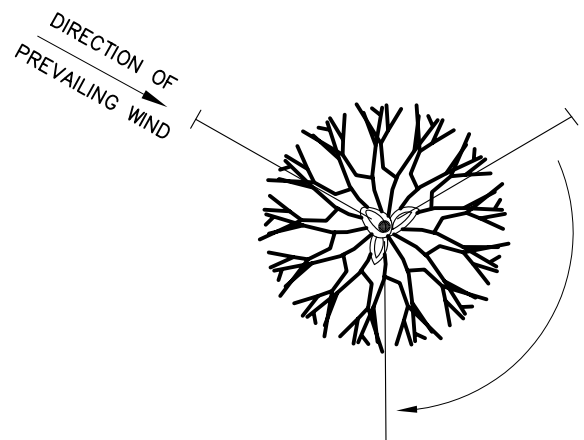

PLAN VIEW

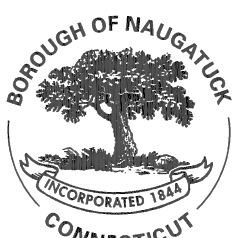

TREE PLANTING

**BOROUGH OF NAUGATUCK
ENGINEERING DEPARTMENT
STANDARD DETAIL**

229 Church Street, Naugatuck, CT 06770



www.naugatuck-ct.gov

Scale: NTS

Drawing No.

SD-29

Date:10/2011

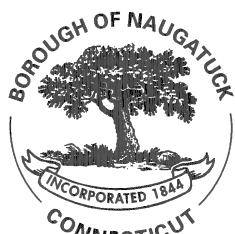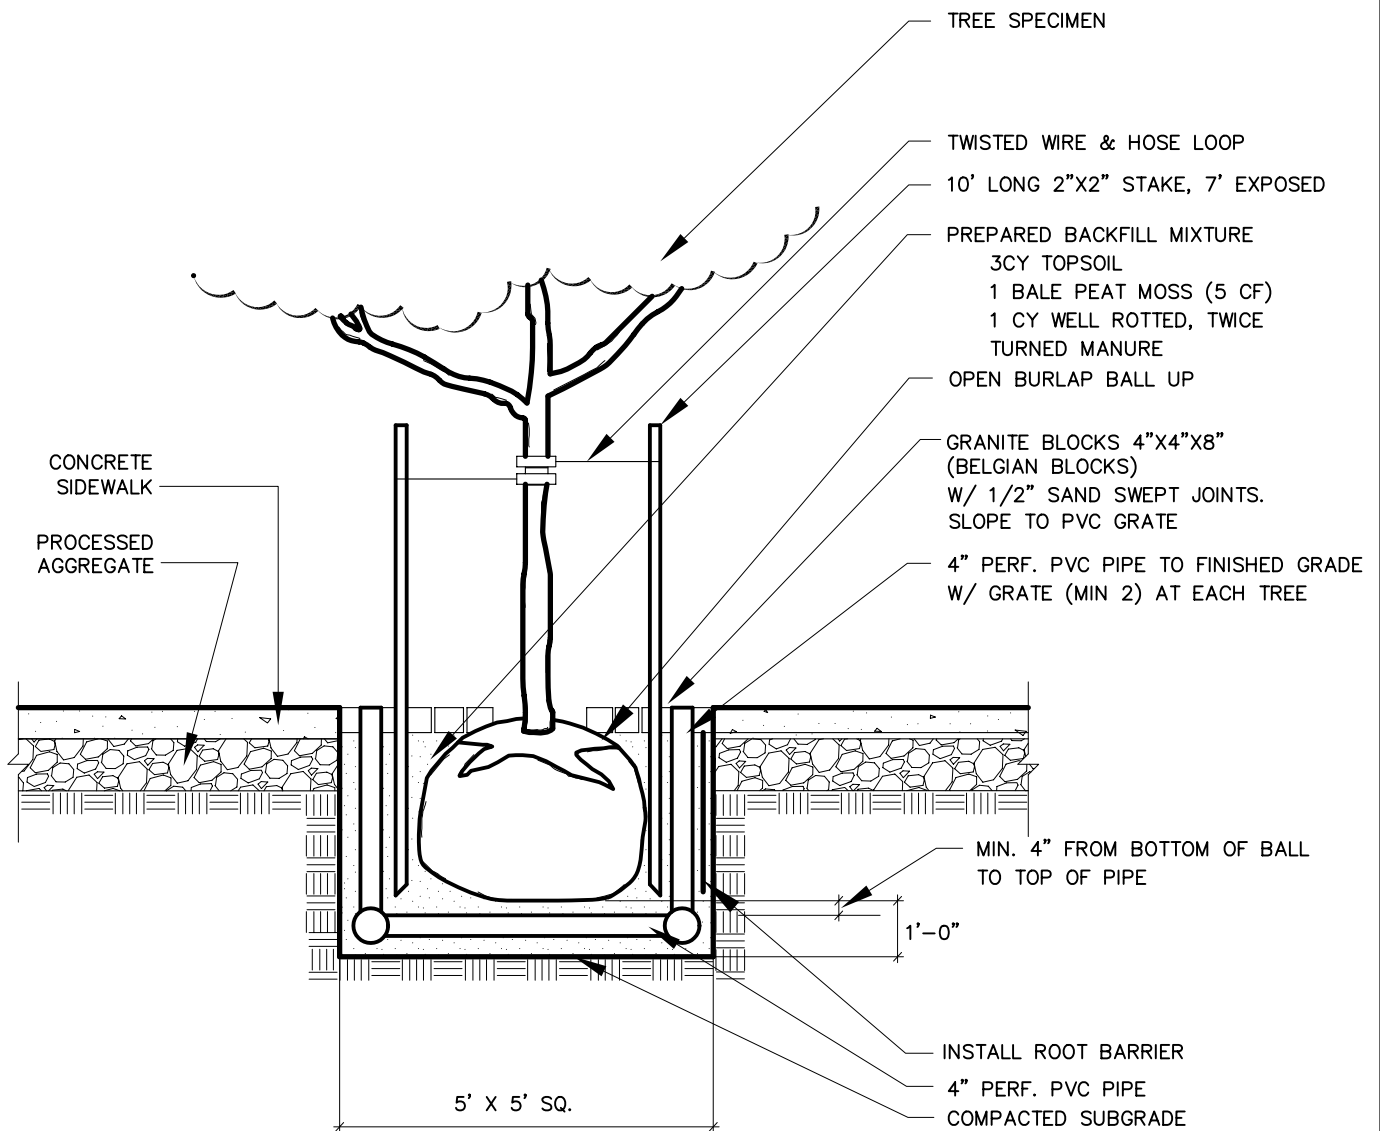

TREE WELL

**BOROUGH OF NAUGATUCK
ENGINEERING DEPARTMENT
STANDARD DETAIL**

229 Church Street, Naugatuck, CT 06770


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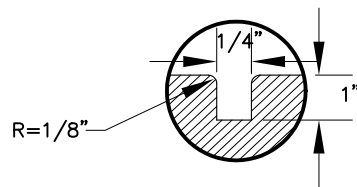
Drawing No.

SD-43


Date: 10/2011




PLAN VIEW

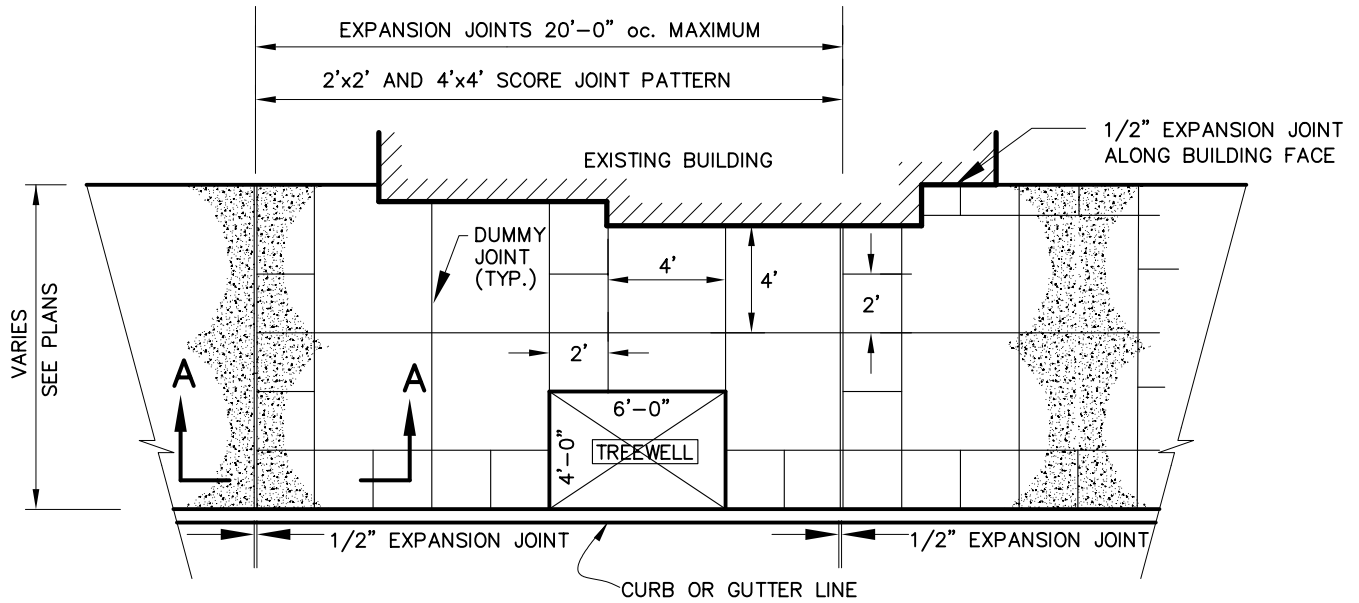

DUMMY JOINT

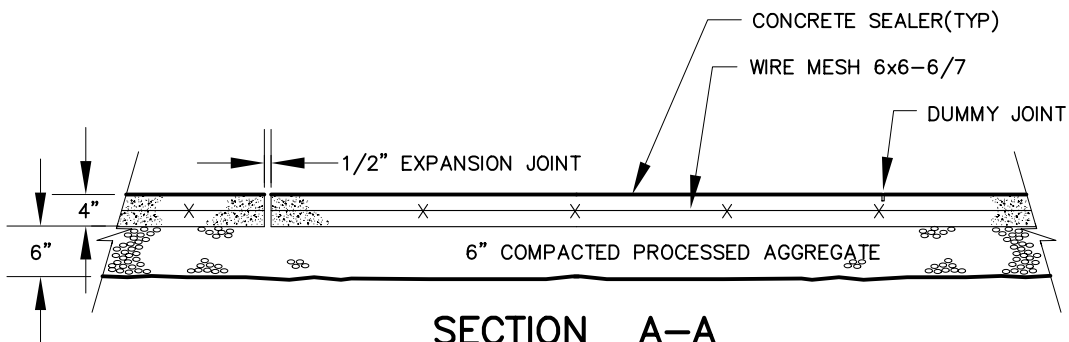

SECTION A-A

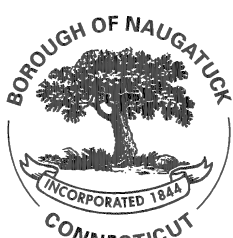

CONCRETE SIDEWALK
WITH TREE WELL

BOROUGH OF NAUGATUCK
ENGINEERING DEPARTMENT
STANDARD DETAIL

229 Church Street, Naugatuck, CT 06770


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
Drawing No.

SD-44


Date:10/2011




NOTE:
WALLS OVER 3' IN HEIGHT REQUIRE DESIGN AND
CERTIFICATION BY A PROFESSIONAL ENGINEER.

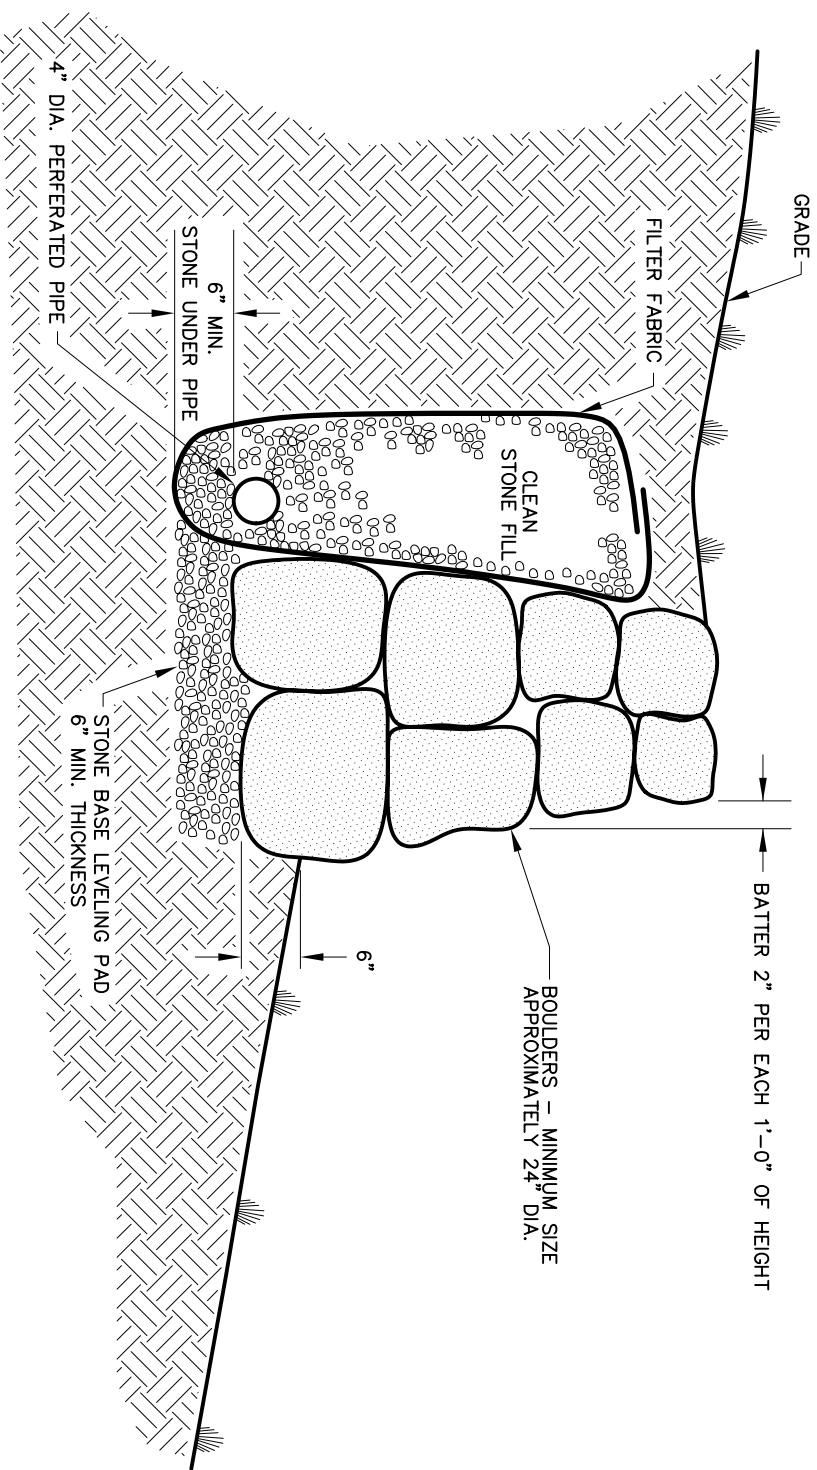	<p>DRY STONE RETAINING WALL</p> <p>BOROUGH OF NAUGATUCK ENGINEERING DEPARTMENT STANDARD DETAIL</p>	<p>Scale: NTS</p> <p>Drawing No.</p> <p>SD-64</p> <p>Date: 10/2011</p>

229 Church Street, Naugatuck, CT 06770 www.naugatuck-ct.gov

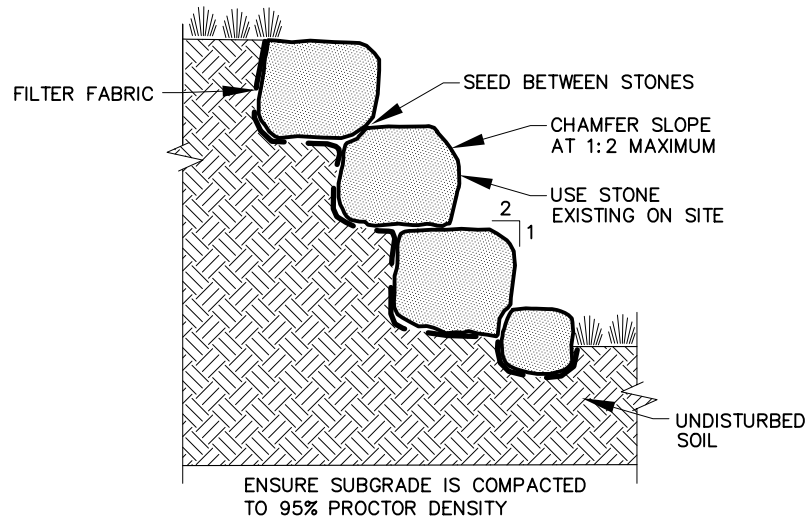

STONE SLOPE

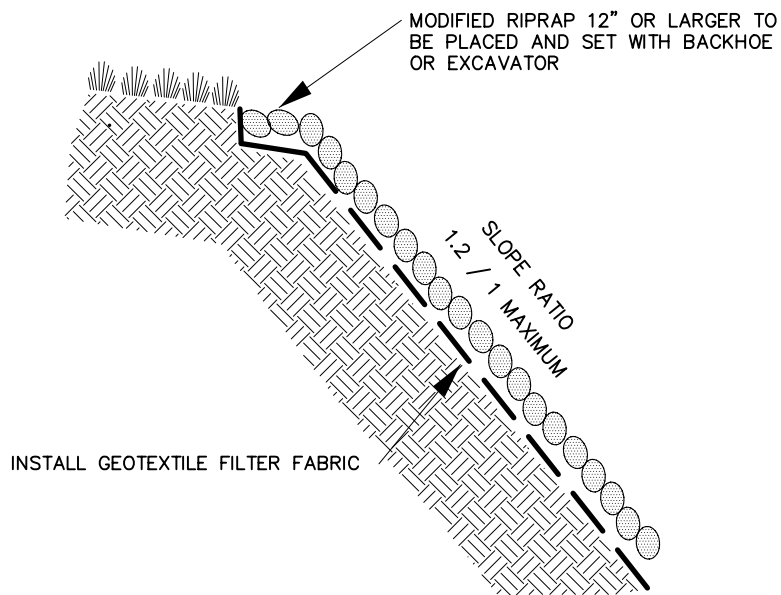

STONE SLOPE PAVING

NOTE:

STONE SLOPES OVER 2:1 GRADE REQUIRE DESIGN AND CERTIFICATION BY A PROFESSIONAL ENGINEER.



STONE SLOPE AND STONE SLOPE PAVING

BOROUGH OF NAUGATUCK ENGINEERING DEPARTMENT STANDARD DETAIL

229 Church Street, Naugatuck, CT 06770


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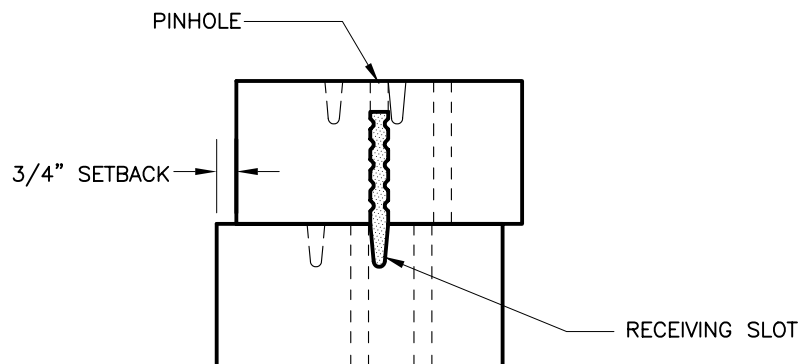
Drawing No.

SD-65

Date: 10/2011



UNREINFORCED SEGMENTAL RETAINING WALL SECTION

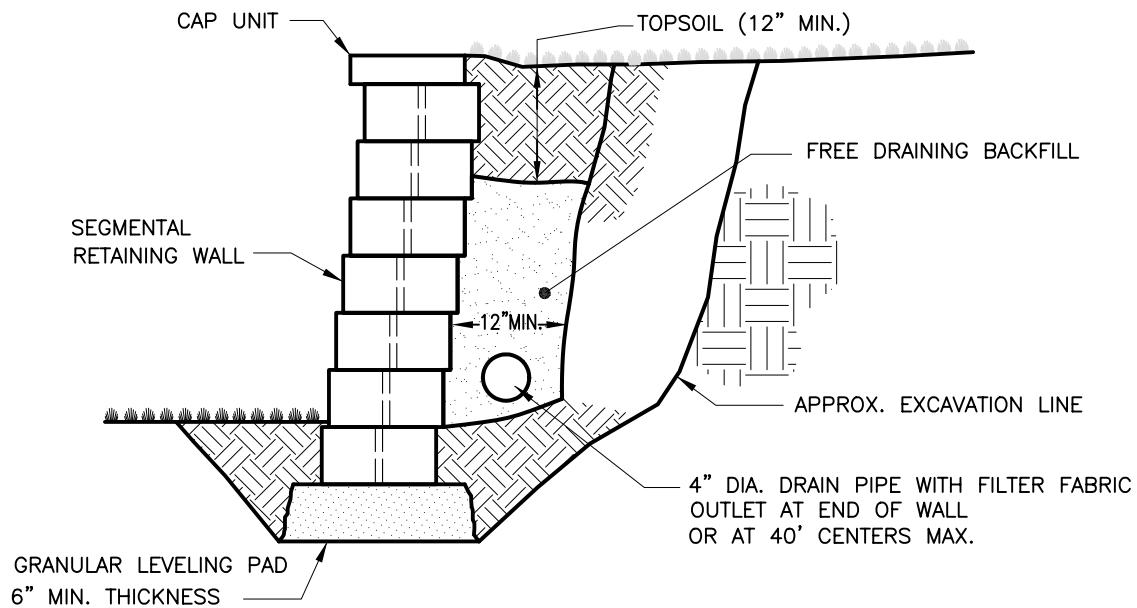

PINNING DETAIL

WALLS OVER 3' IN HEIGHT REQUIRE DESIGN AND CERTIFICATION BY PROFESSIONAL ENGINEER.



**UNREINFORCED SEGMENTAL
RETAINING WALL**

**BOROUGH OF NAUGATUCK
ENGINEERING DEPARTMENT
STANDARD DETAIL**

229 Church Street, Naugatuck, CT 06770



www.naugatuck-ct.gov

Scale: NTS

Drawing No.

SD-66

Date: 10/2011

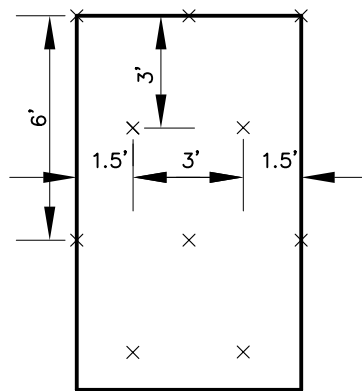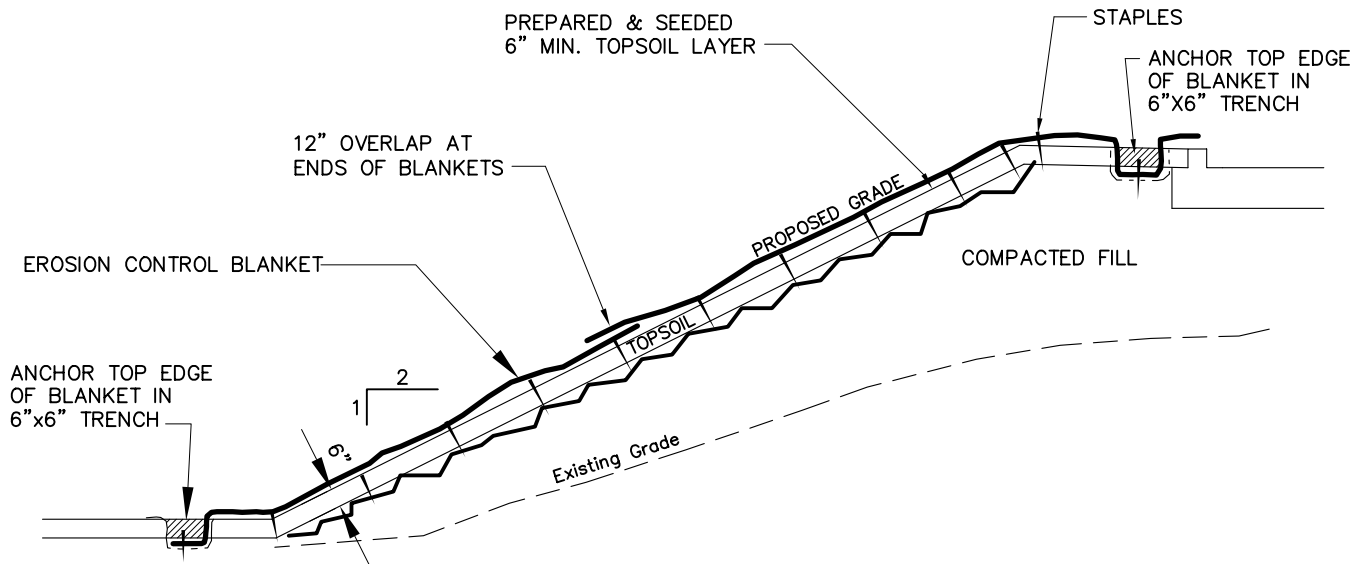

STAPLE PATTERN "C"



EROSION CONTROL BLANKET ON FILL SLOPE

**BOROUGH OF NAUGATUCK
ENGINEERING DEPARTMENT
STANDARD DETAIL**

229 Church Street, Naugatuck, CT 06770


www.naugatuck-ct.gov

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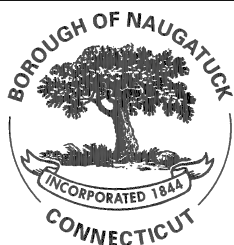
Drawing No.

SD-21

Date:10/2011

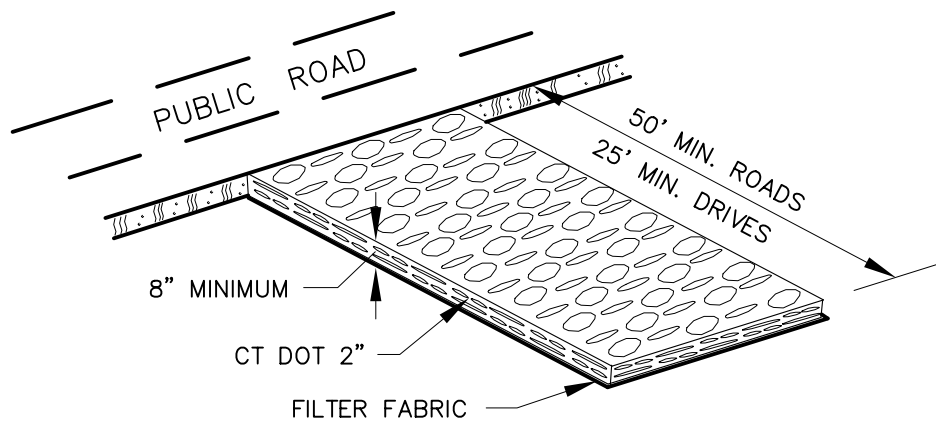

SEE STORMWATER MANUAL FOR SIZING FORMULA.



ANTI-TRACKING PAD

**BOROUGH OF NAUGATUCK
ENGINEERING DEPARTMENT
STANDARD DETAIL**

229 Church Street, Naugatuck, CT 06770


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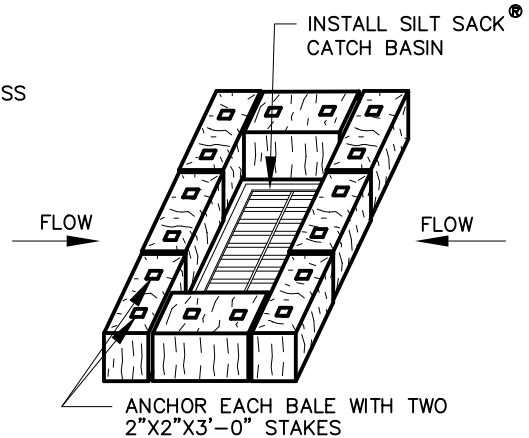
Drawing No.

SD-23

Date: 10/2011




SILT FENCE INSTALLATION AT CATCH BASINS AT LOW POINTS

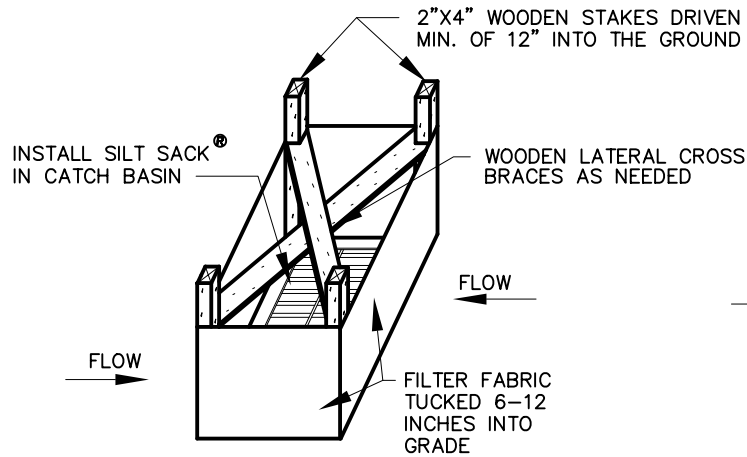

HAY BALE FILTER INSTALLATION AT CATCH BASIN AT LOW POINTS


STORMWATER INLETS WHICH DO NOT DISCHARGE TO SEDIMENT TRAPS OR BASINS, MUST BE PROTECTED UNTIL THE TRIBUTARY AREAS ARE STABILIZED.

SEDIMENT MUST BE REMOVED FROM SILT SACK INLET PROTECTION AFTER EACH STORM EVENT.

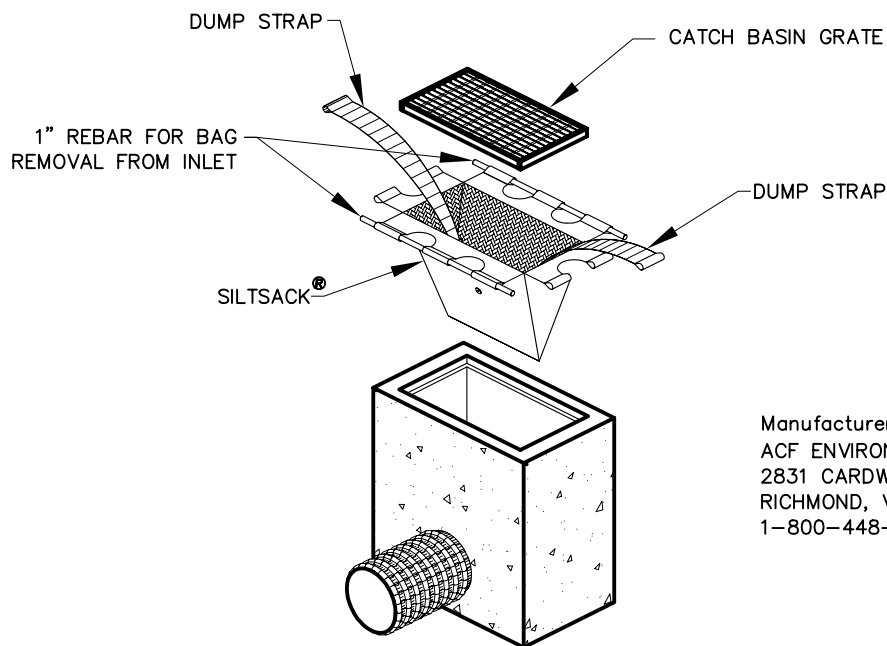

Manufacturer:
ACF ENVIRONMENTAL
2831 CARDWELL ROAD
RICHMOND, VA 23234
1-800-448-3636

SILTSACK SEDIMENT CONTROL DEVICE

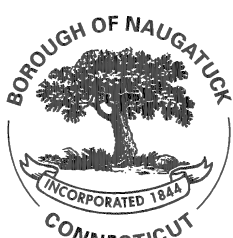

CATCH BASIN EROSION CONTROL

BOROUGH OF NAUGATUCK ENGINEERING DEPARTMENT STANDARD DETAIL

229 Church Street, Naugatuck, CT 06770


www.naugatuck-ct.gov

Scale: NTS

Drawing No.

SD-26

Date: 10/2011

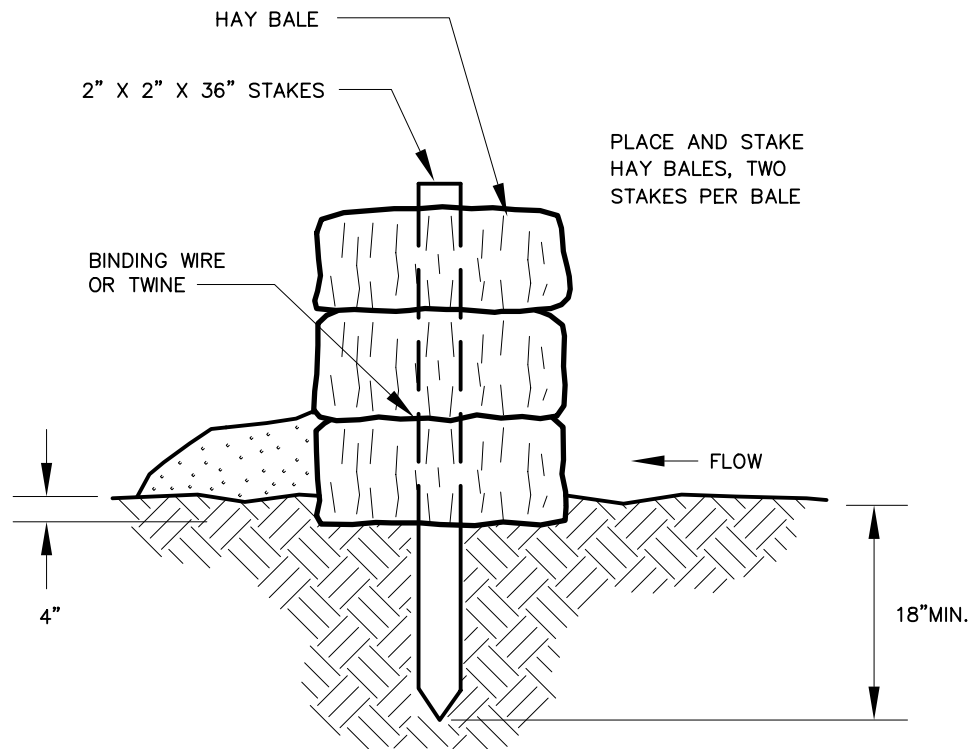

HAY BALE BARRIERS SHOULD NOT BE USED FOR MORE THAN 3 MONTHS.

SEDIMENT MUST BE REMOVED WHEN ACCUMULATIONS REACH $\frac{1}{3}$ THE ABOVE GROUND HEIGHT OF THE BARRIER.

ANY SECTION OF HAY BALE BARRIER WHICH HAS BEEN UNDERMINED OR TOPPED MUST BE IMMEDIATELY REPLACED WITH A ROCK FILTER OUTLET.



HAY BALE BARRIER

**BOROUGH OF NAUGATUCK
ENGINEERING DEPARTMENT
STANDARD DETAIL**

229 Church Street, Naugatuck, CT 06770


www.naugatuck-ct.gov

Scale: NTS

Drawing No.

SD-30

Date: 10/2011

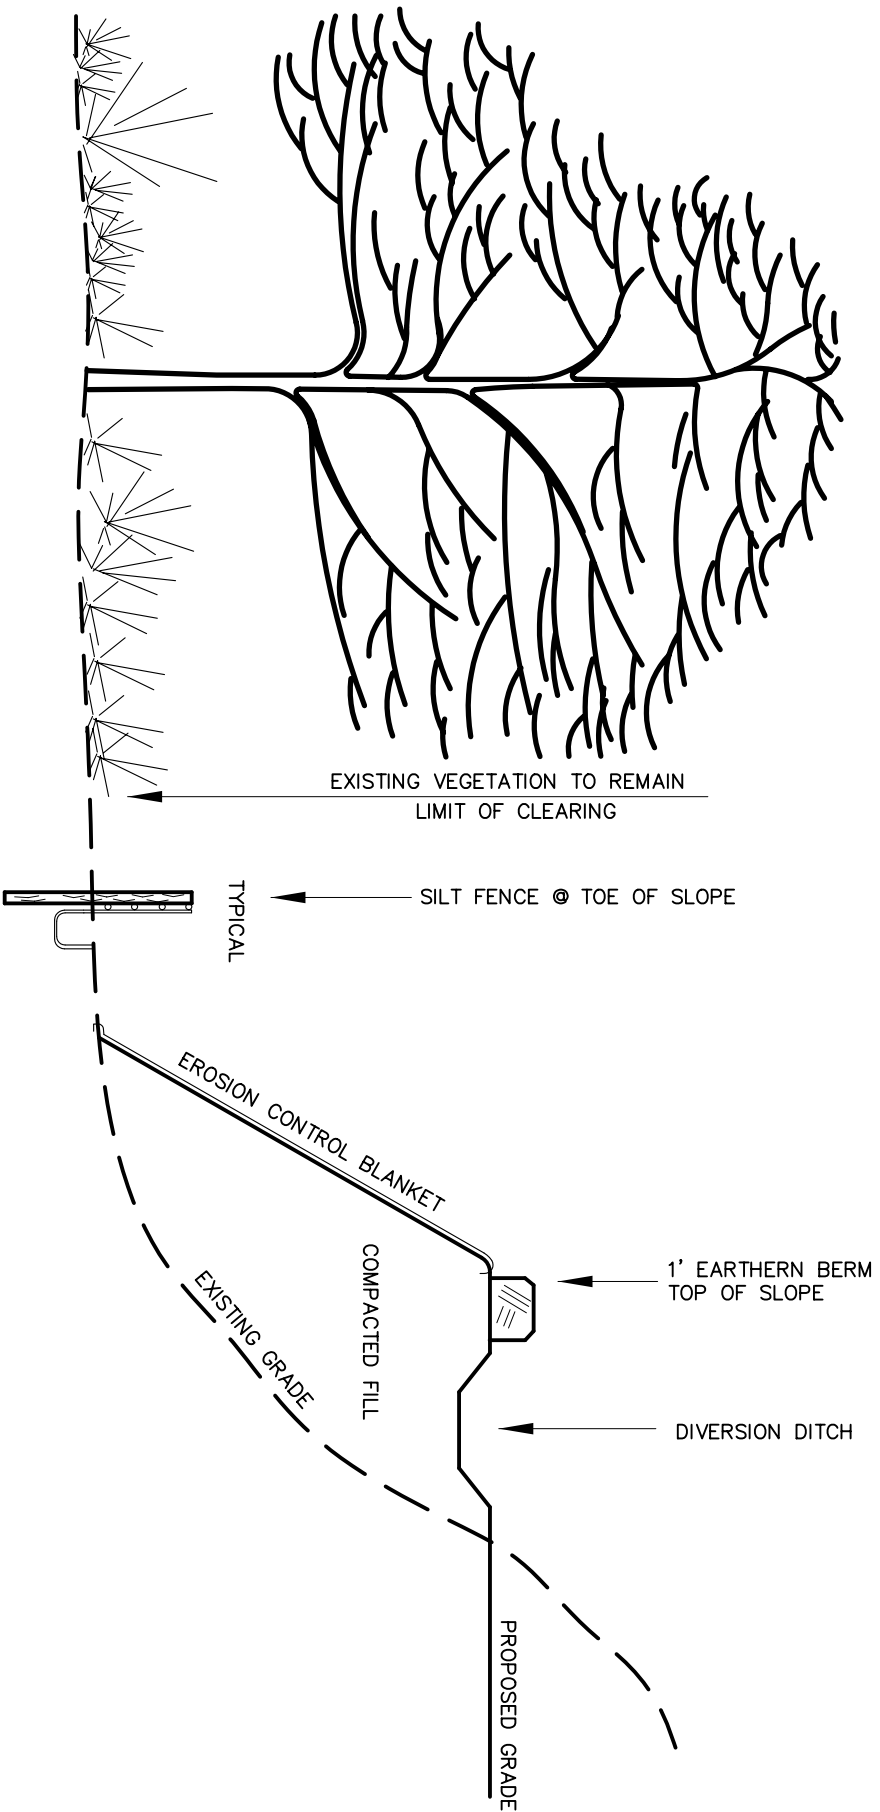

TYPICAL EROSION CONTROL ON SLOPES

**BOROUGH OF NAUGATUCK
ENGINEERING DEPARTMENT
STANDARD DETAIL**

229 Church Street, Naugatuck, CT 06770


www.naugatuck-ct.gov

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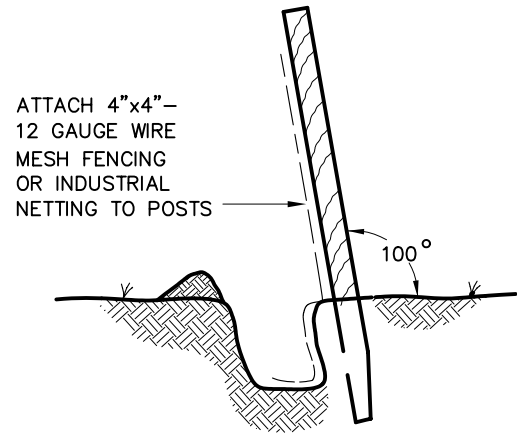
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SD-35


Date: 10/2011




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2

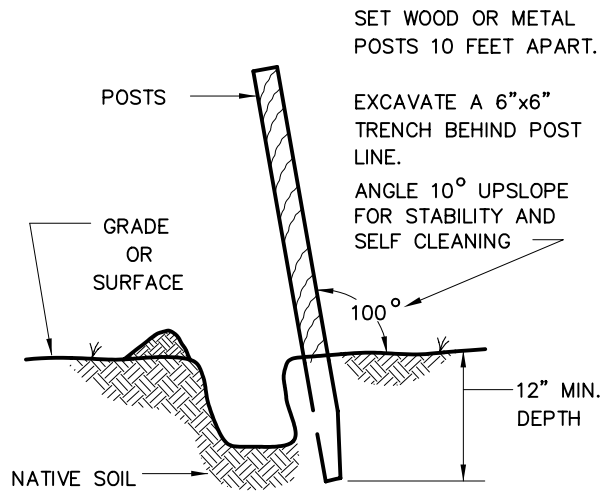


3

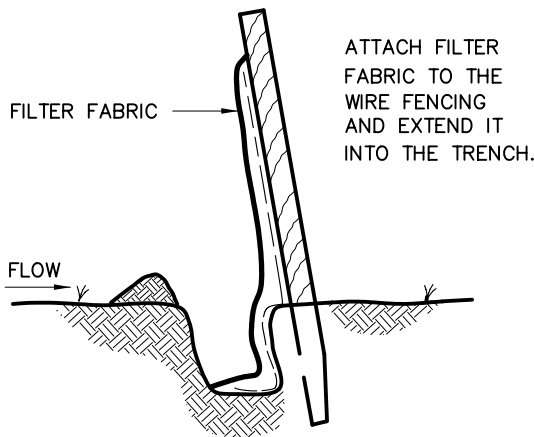

4

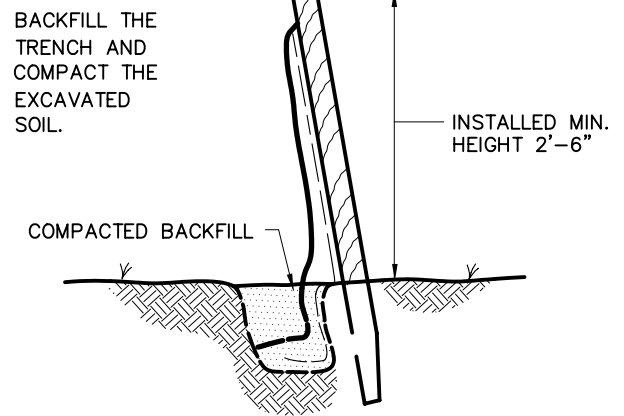NOTE:
FENCE TO BE INSTALLED PRIOR TO CONSTRUCTION.
PREASSEMBLED UNITS ALSO MAY BE USED, INSTALLED
AS INDICATED.

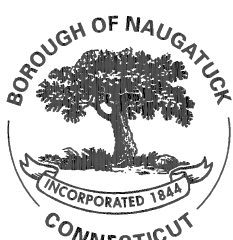

FILTER FABRIC SEDIMENT CONTROL FENCE PLACEMENT AND CONSTRUCTION

BOROUGH OF NAUGATUCK
ENGINEERING DEPARTMENT
STANDARD DETAIL

229 Church Street, Naugatuck, CT 06770


www.naugatuck-ct.gov

Scale: NTS


Drawing No.

SD-41

Date: 10/2011

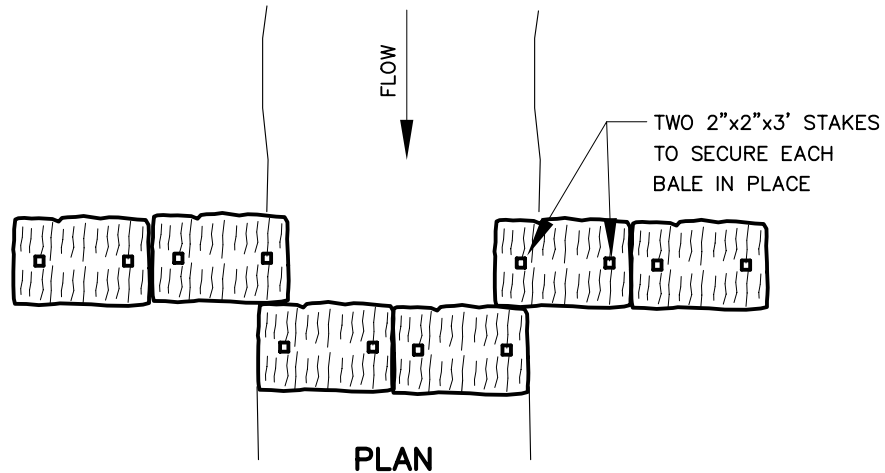

TO BE INSTALLED AT DRAINAGE DITCH OR BROOK CROSSINGS

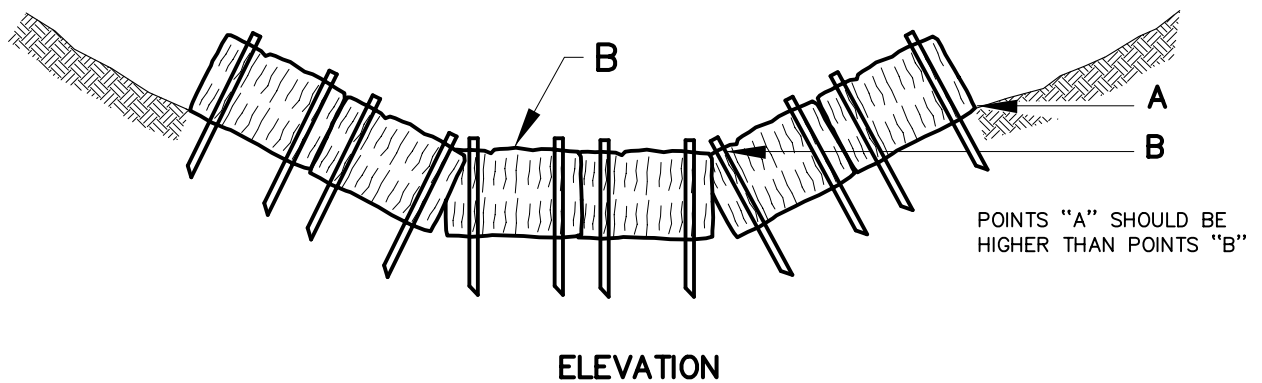

HAY BALE SEDIMENT CHECK DAM

**BOROUGH OF NAUGATUCK
ENGINEERING DEPARTMENT
STANDARD DETAIL**

229 Church Street, Naugatuck, CT 06770



www.naugatuck-ct.gov

Scale: NTS

Drawing No.


SD-42

Date: 10/2011

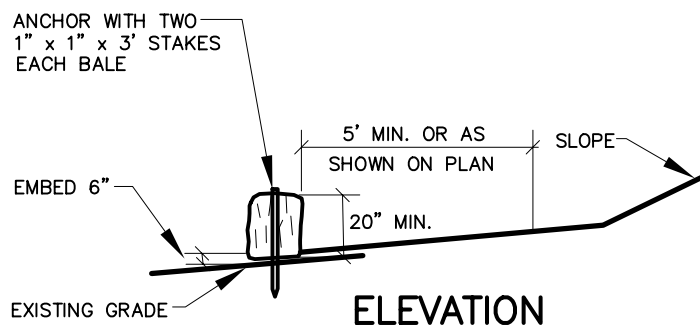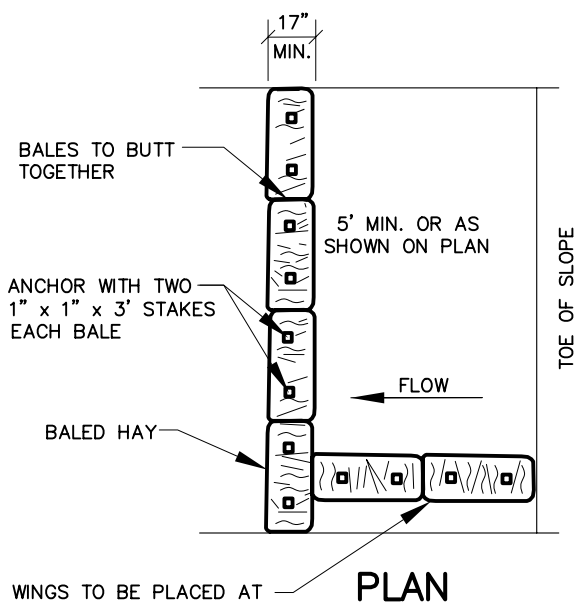


WINGS TO BE PLACED AT 150' INTERVALS ALONG SLOPE LIMIT AND AT TRANSITIONS BETWEEN CUT & FILL SLOPES

HAY BALES

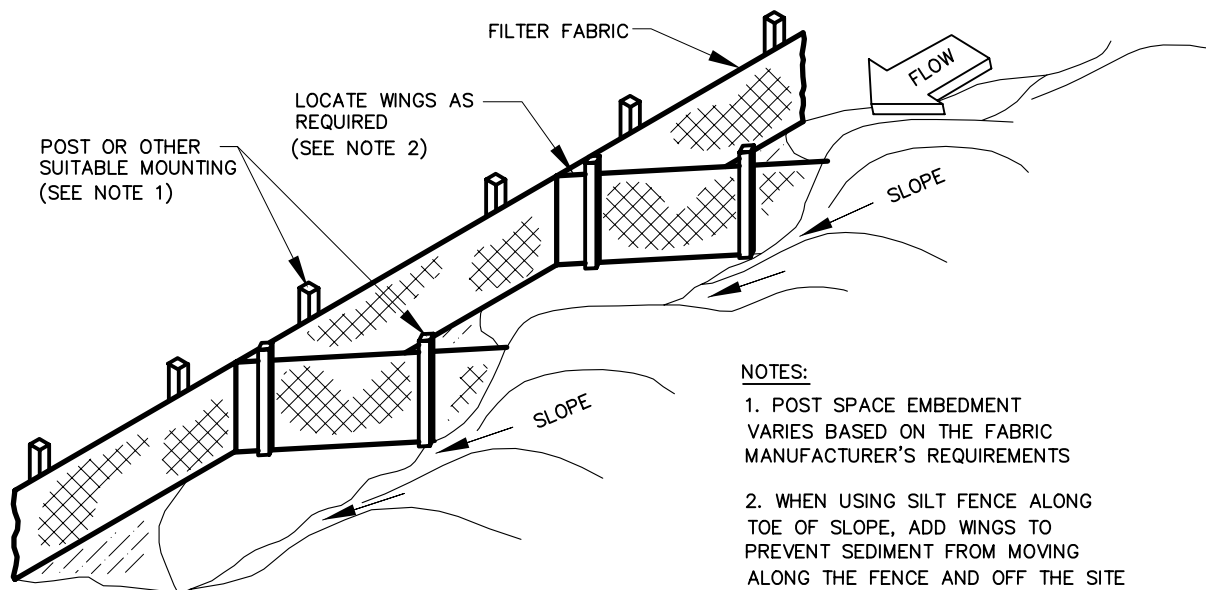

NOTES:

1. POST SPACE EMBEDMENT VARIES BASED ON THE FABRIC MANUFACTURER'S REQUIREMENTS
2. WHEN USING SILT FENCE ALONG TOE OF SLOPE, ADD WINGS TO PREVENT SEDIMENT FROM MOVING ALONG THE FENCE AND OFF THE SITE

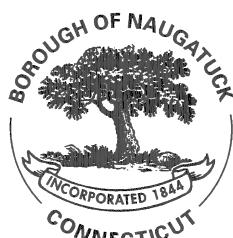

SEDIMENT CONTROL SYSTEMS

BOROUGH OF NAUGATUCK ENGINEERING DEPARTMENT STANDARD DETAIL

229 Church Street, Naugatuck, CT 06770



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Scale: NTS

Drawing No.

SD-68

Date: 10/2011

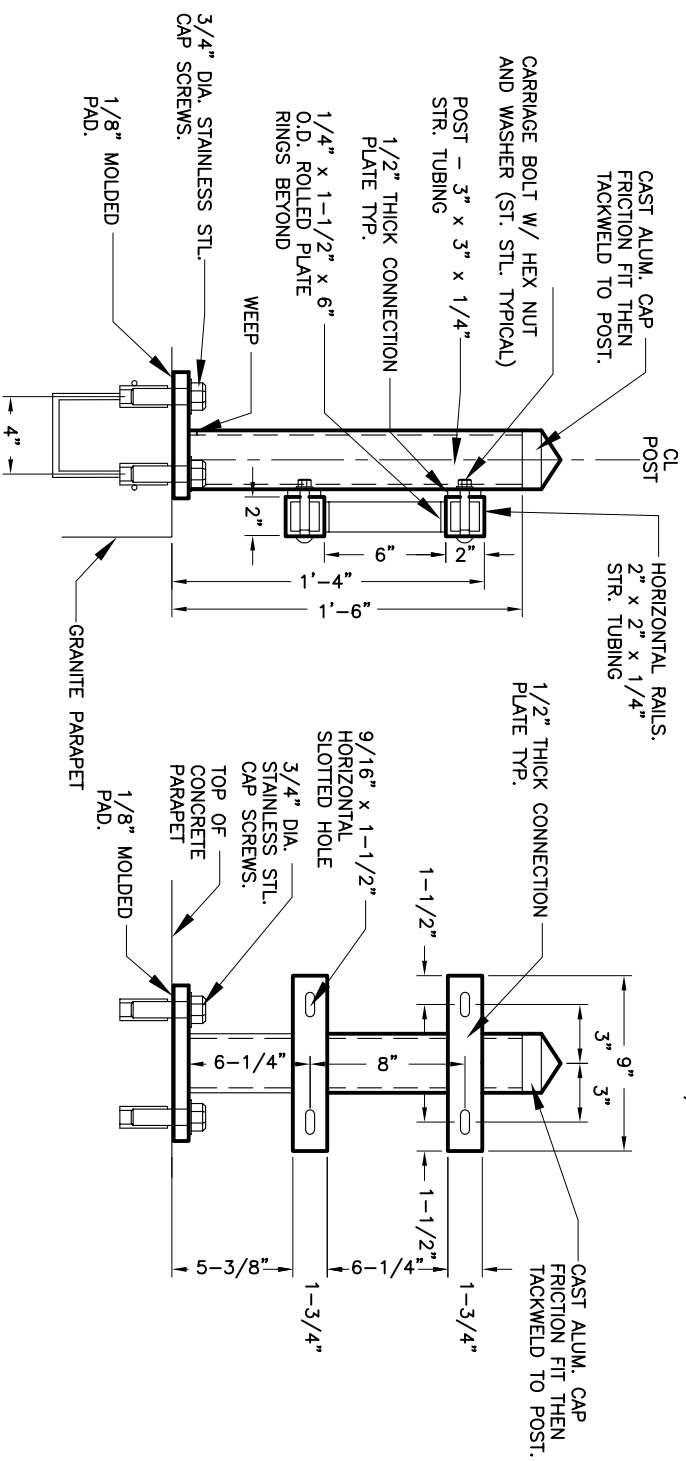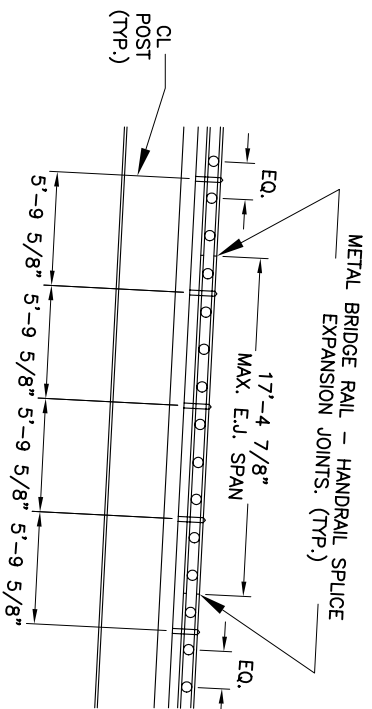

BRIDGE RAIL


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Drawing No.

SD-18

229 Church Street, Naugatuck, CT 06770 www.naugatuck-ct.gov

Date: 10/2011

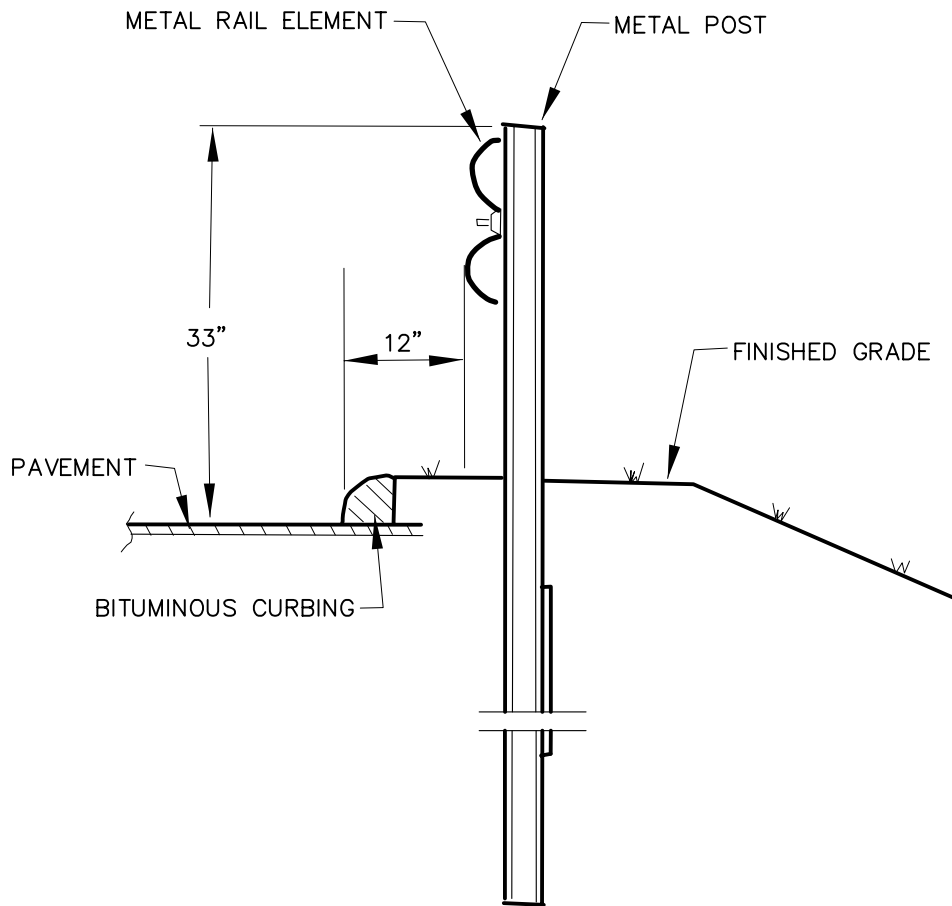

METAL BEAM RAIL

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229 Church Street, Naugatuck, CT 06770


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Scale: NTS

Drawing No.

SD-20

Date: 10/2011

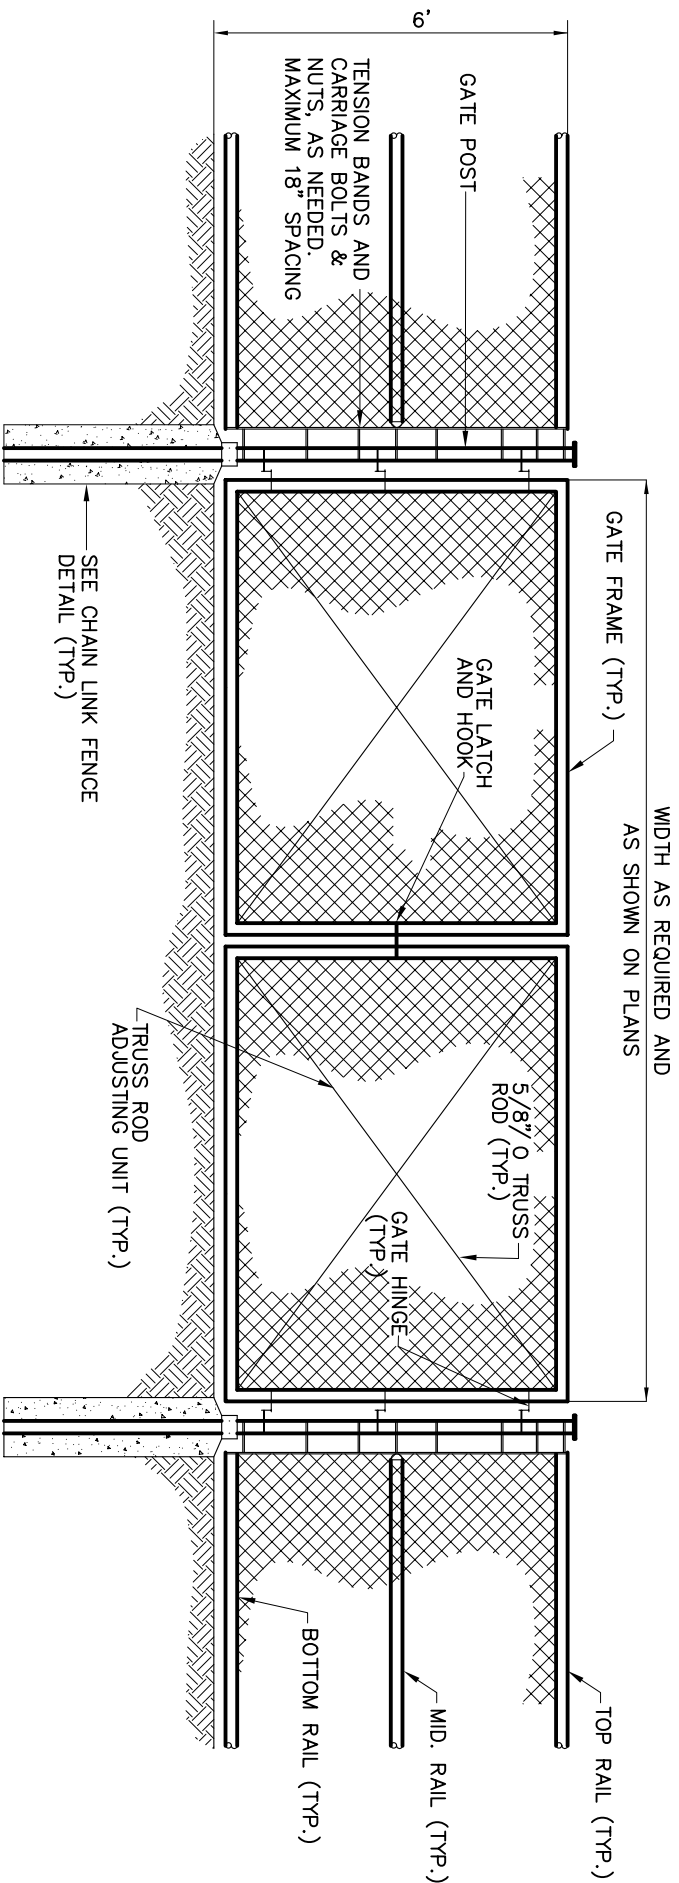

CHAIN LINK DOUBLE SWING GATE

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STANDARD DETAIL**

Scale: NTS
Drawing No.

SD-27


229 Church Street, Naugatuck, CT 06770 www.naugatuck-ct.gov

Date: 10/2011






Date: 10/2011

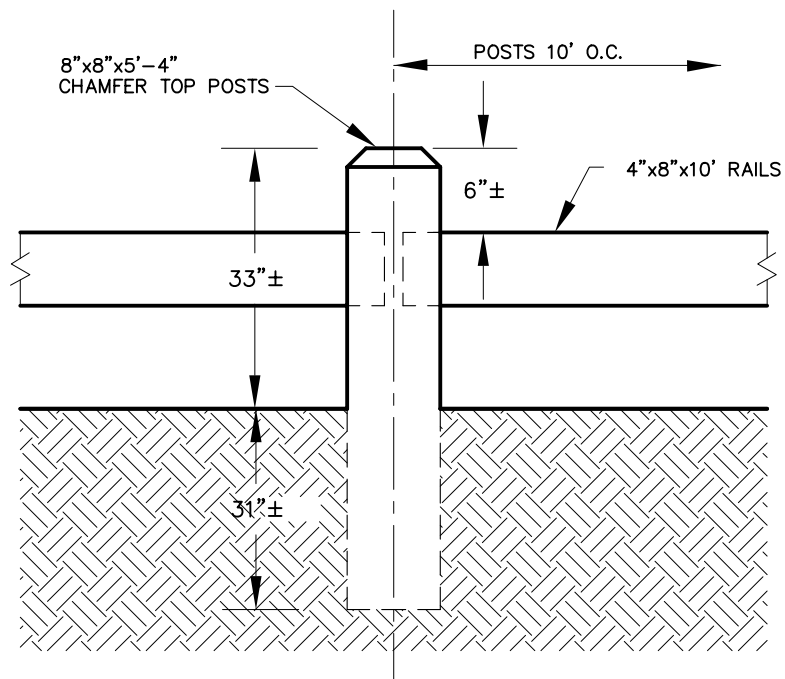

NOTE:
TIMBER TO BE .4 CCA
SOUTHERN YELLOW PINE

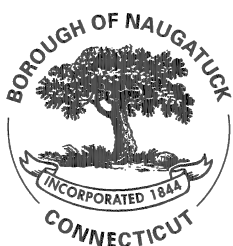

TIMBER GUIDERAIL

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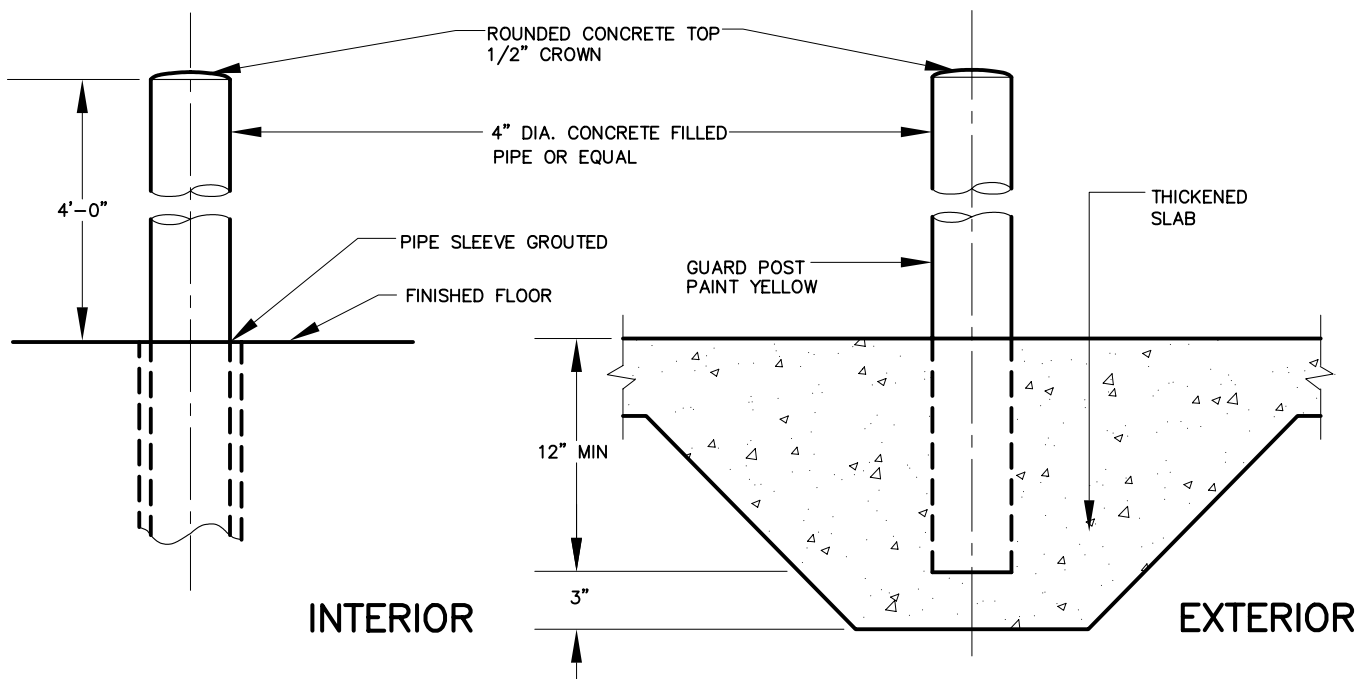
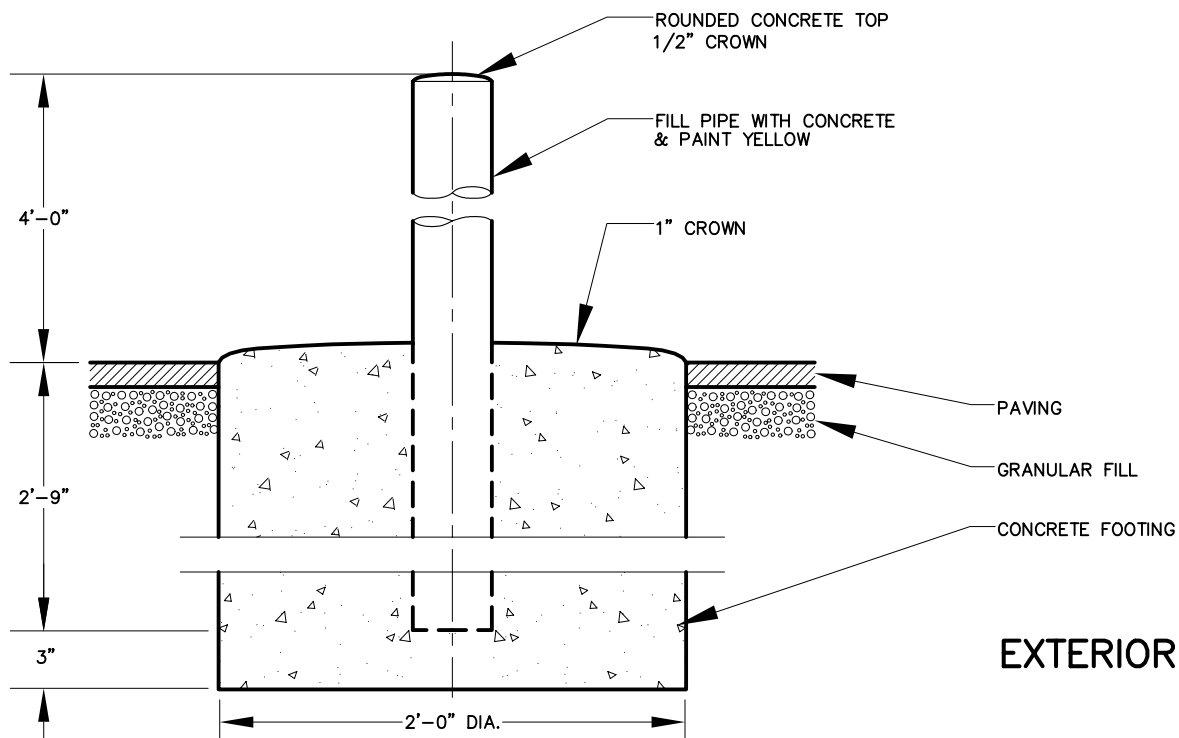
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Drawing No.

SD-63

Date: 10/2011



***NOTES:**

- 1) DIAMETER AND MATERIAL FOR PIPES USED AS BOLLARDS SHOULD BE CHOSEN BASED ON VEHICULAR TRAFFIC IN THE BOLLARD AREA, AND THE LOADS LIKELY TO BE APPLIED.



BOLLARD

**BOROUGH OF NAUGATUCK
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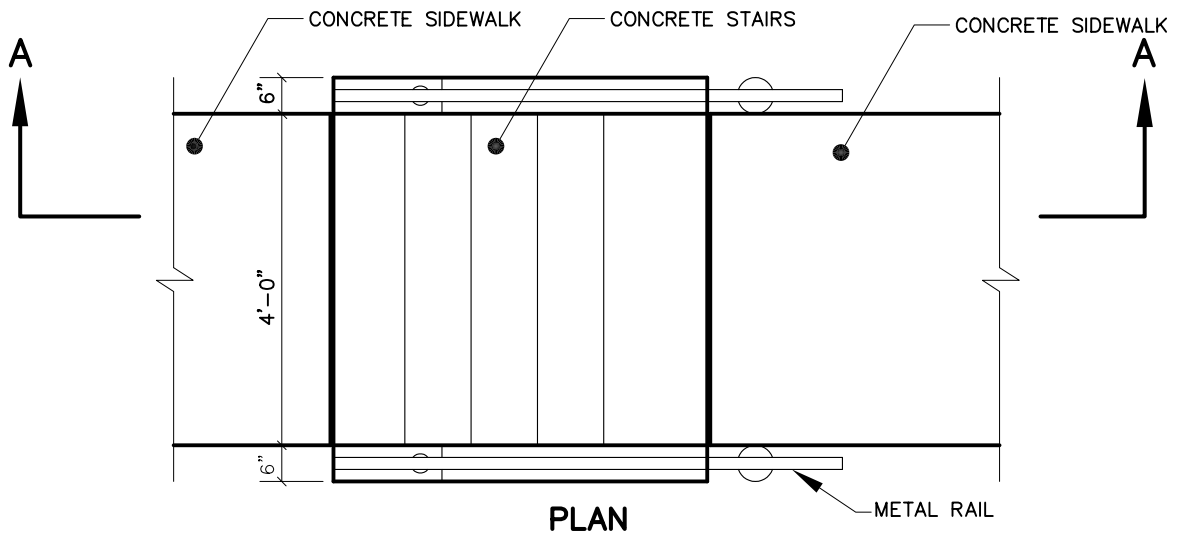
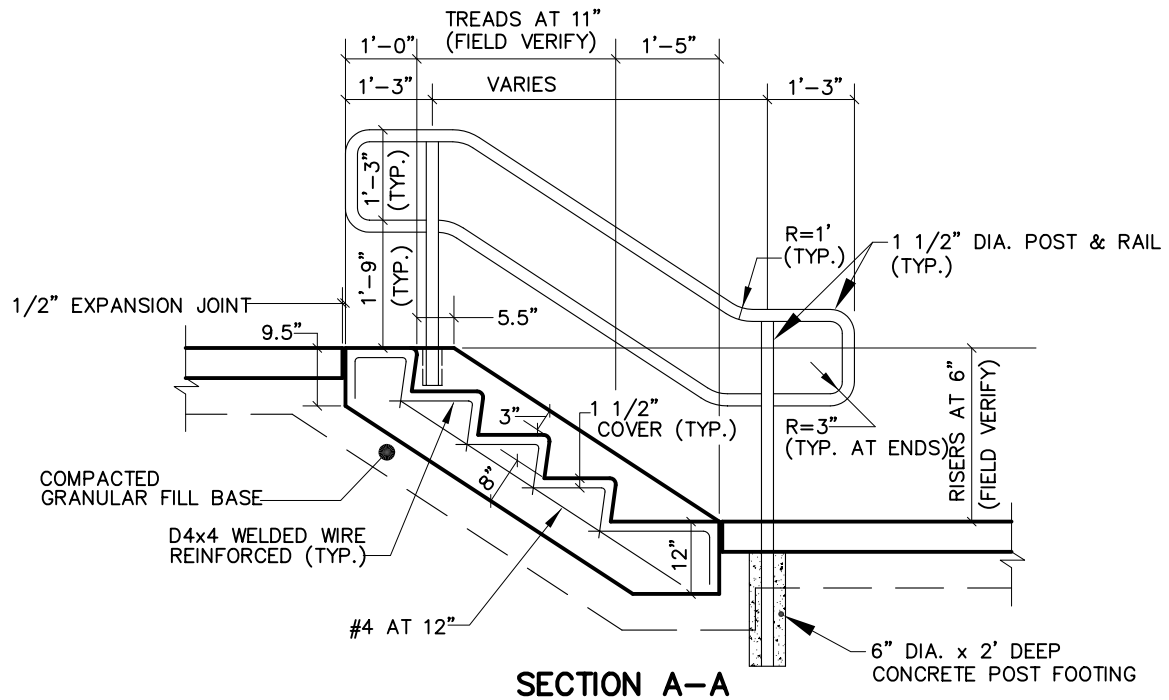
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Drawing No.

SD-67

Date: 10/2011



CONCRETE STAIRS

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Drawing No.

SD-69

Date: 10/2011