


Borough of Naugatuck

District Wide School Upgrades

497 Rubber Ave.
Naugatuck, Connecticut 06770

PROJECT LOCATION MAP

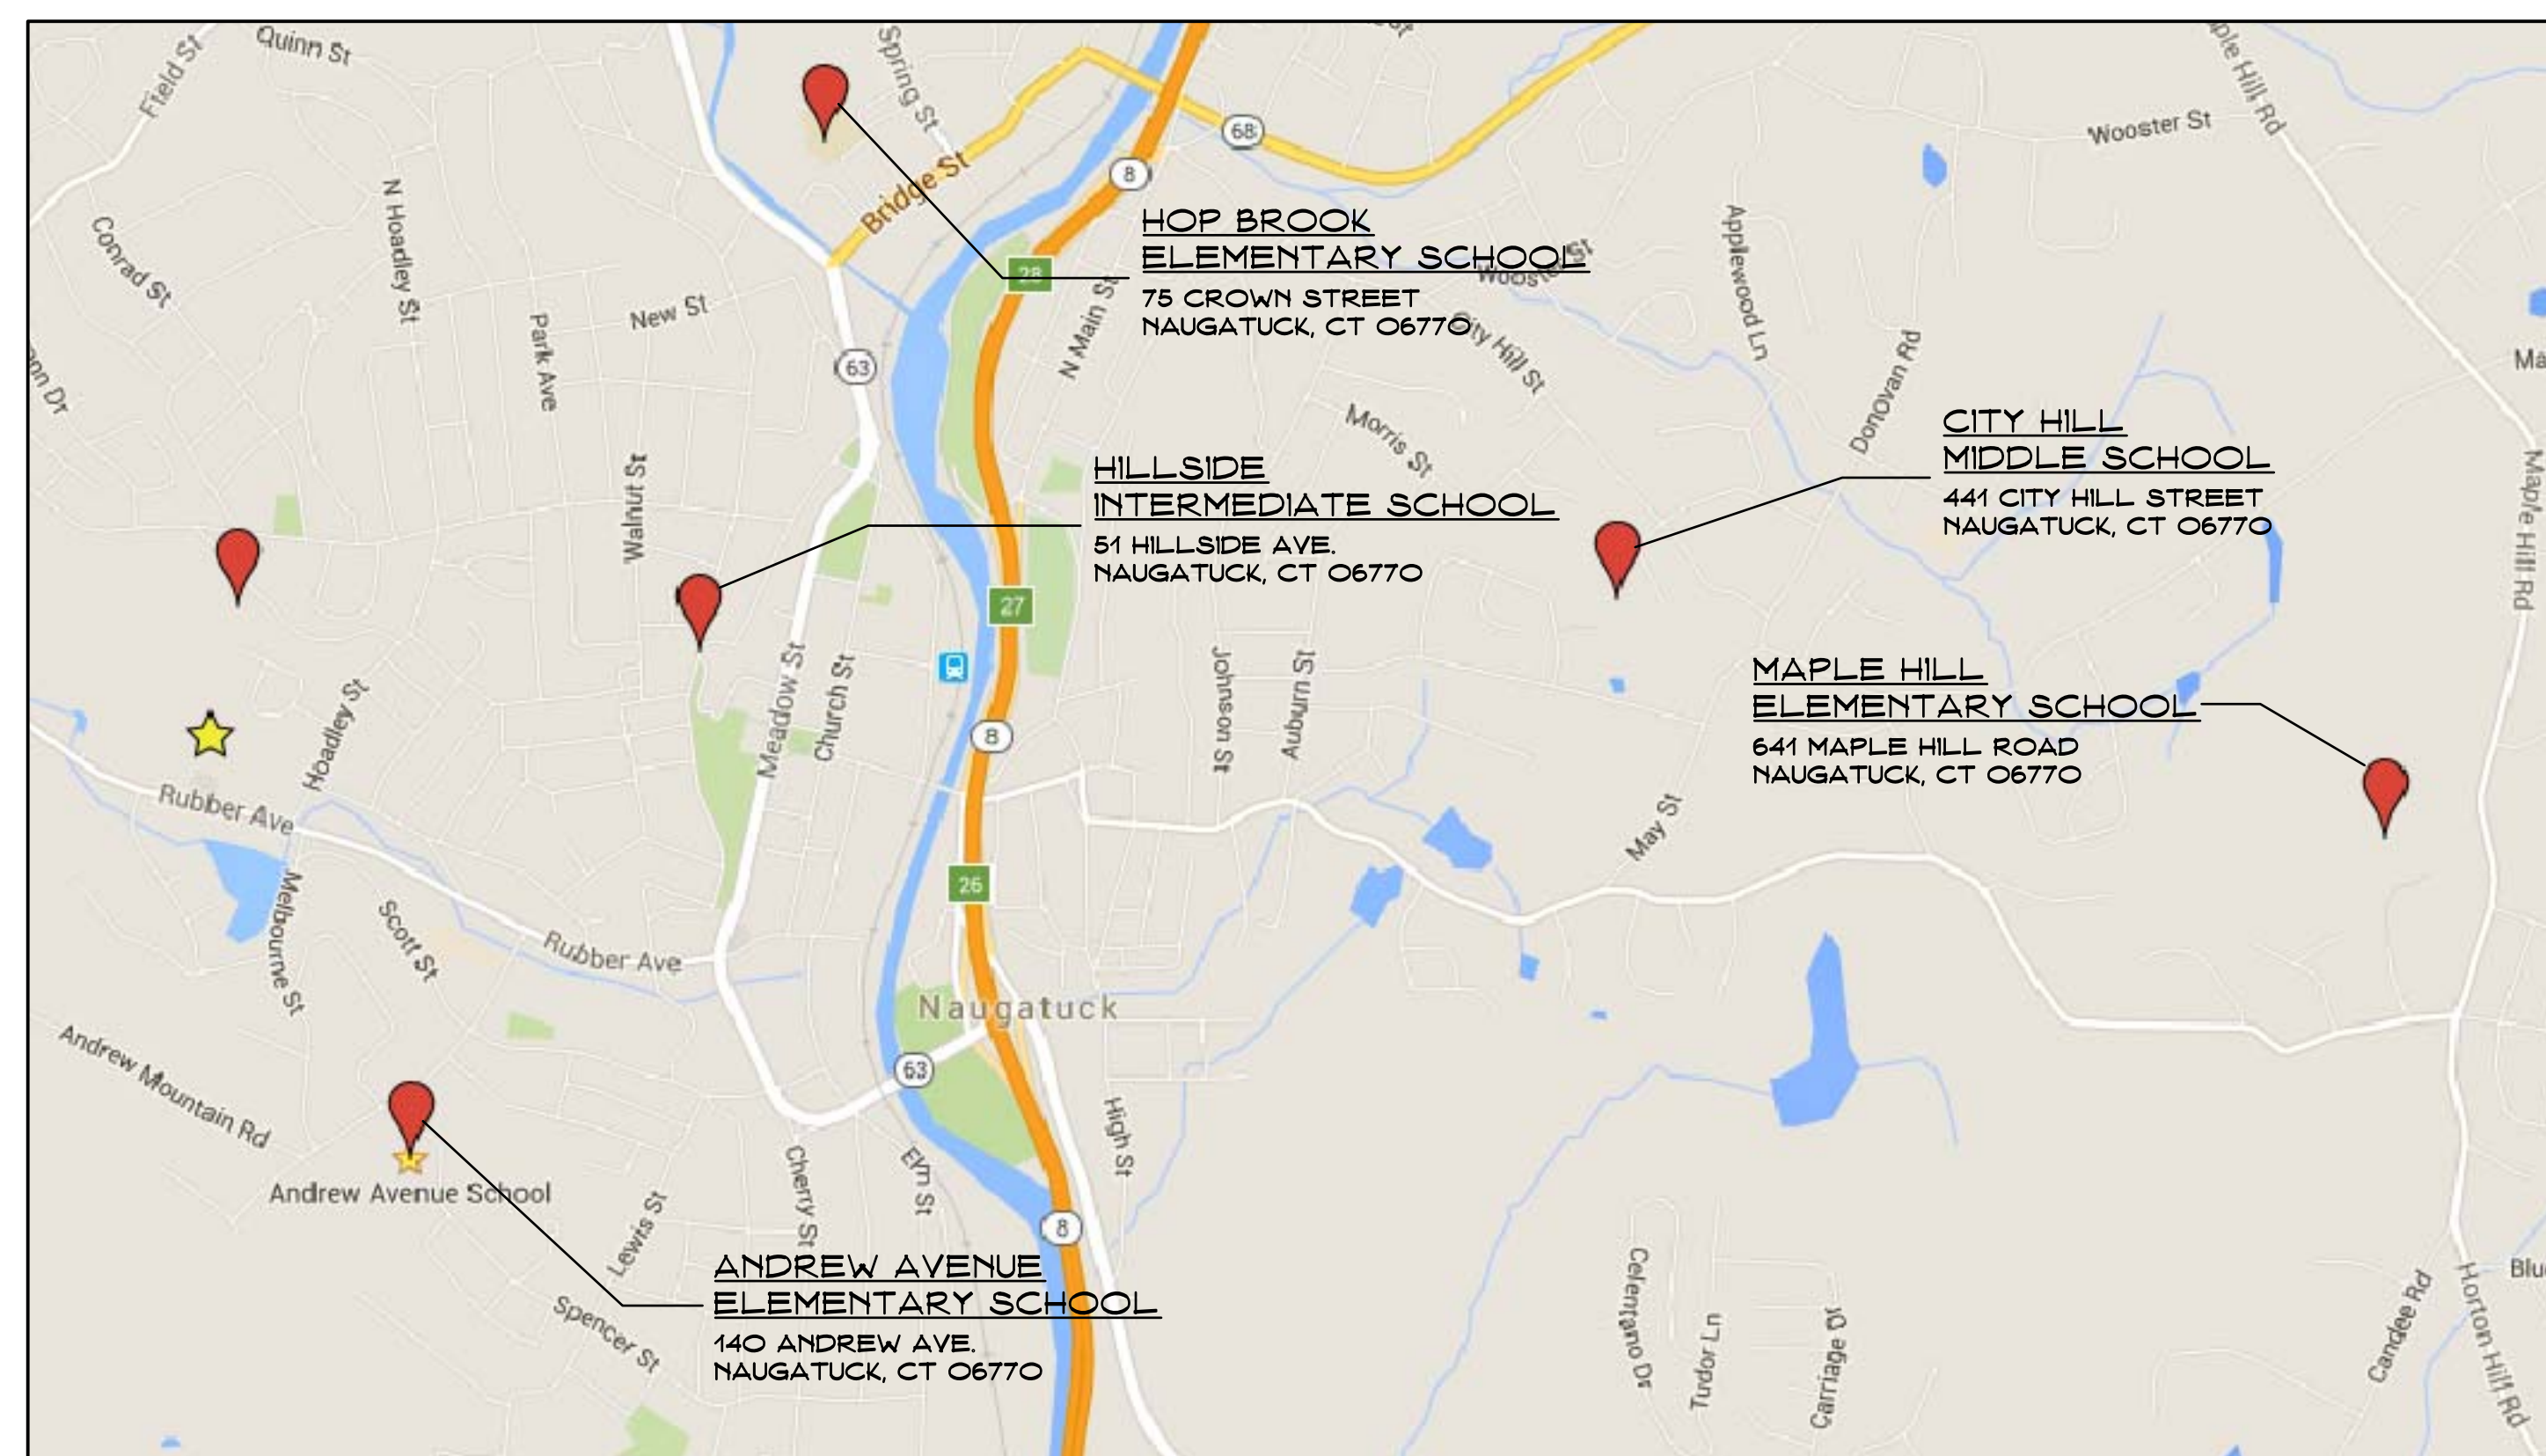

LIST OF DRAWINGS

GENERAL

CS - COVER SHEET
A001 - GENERAL INFORMATION

ANDREW AVENUE SCHOOL:

A101 FLOOR PLANS
A102 ELEVATIONS, SCHEDULES & DETAILS

MAPLE HILL SCHOOL:

A201 LOWER LEVEL FLOOR PLANS
A202 MAIN LEVEL FLOOR PLANS

HOP BROOK SCHOOL:

A301 LOWER & FIRST FLOOR PLANS
A302 SECOND FLOOR PLAN

HILLSIDE SCHOOL:

A401 FIRST FLOOR CEILING PLAN (PARTIAL)
A402 SECOND FLOOR CEILING PLAN
A403 THIRD FLOOR CEILING PLAN
A404 FIRE PROTECTION NOTES & DETAILS

CITY HILL SCHOOL:

A501 CAFETERIA FLOOR PLAN

HAZMAT DRAWINGS:

HM-01 ANDREW AVE. HAZMAT ABATEMENT PLAN
HM-02 HILLSIDE SCHOOL - THIRD FLOOR HAZMAT ABATEMENT PLAN
HM-03 HILLSIDE SCHOOL - SECOND FLOOR HAZMAT ABATEMENT PLAN
HM-04 HILLSIDE SCHOOL - FIRST FLOOR HAZMAT ABATEMENT PLAN

SILVER / PETRUCELLI + ASSOCIATES

Architects / Engineers / Interior Designers

3190 Whitney Avenue, Hamden, CT 06518-2340

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silverpetrucelli.com



June 14, 2016

ISSUED FOR BID

ARCHITECTURAL ABBREVIATION LIST								SYMBOLS LEGEND		HATCH PATTERNS	
ABSEV	ABBREVIATION(S)	DS	DOWNSPOUT	RGWB	IMPACT RESISTANT GYPSUM WALLBOARD	REIN	REINFORCE(D)(ING)		ELEVATION / BULLET		CONCRETE MASONRY UNIT
ABV	ABOVE	DSG	DOWNSPOUT SCUPPER	JAN	JANITOR	REV	REVISED(D)(ON)		KEY NOTE TAG		CONCRETE
ACMU	ACOUSTICAL C.M.U.	DWG	DRAWING(S)	EA	EACH	RES	RESILIENT		WALL / PARTITION TYPE IDENTIFICATION		BRICK
ACP	ACOUSTICAL CEILING PANEL	EF	EXHAUST FAN	LBL	LABEL	REQ. REQD	REQUIRED		DOOR IDENTIFICATION TAG		METAL
ACT	ACOUSTICAL CEILING TILE	EJ, EXP JT	EXPANSION JOINT	LAV	LAVATORY	RH	RIGHT HAND		CEILING HEIGHT TAG		GRATING AND/OR RIGID INSULATION
ACP	VINYL LAMINATE ACOUSTICAL CEILING PANEL	ELEC	ELECTRICAL	LL	LIVE LOAD	RO	ROUGH OPENING		TOILET ACCESSORY IDENTIFICATION TAG		SIDING AND/OR STANDING SEAM MTL. ROOF SYSTEM
ACU, A/C	AIR CONDITIONING UNIT	ELEV	ELEVATIONS(S)	LKR	LOCKER(S)	RT	RESILIENT TILE		COLUMN GRID TAG		ROUGH WOOD
ADD	ADDITIONAL	EQ	EQUAL	LLV	LONG LEG VERTICAL	SAN	SANITARY		DETAIL TAG		FINISHED WOOD
A/E	ARCHITECT/ENGINEER	EQUIP	EQUIPMENT	MAINT	MAINTENANCE	SCHED	SCHEDULE		SECTION TAG		PLYWOOD
AF	ABOVE FINISHED FLOOR	EWG	ELECTRIC WATER COOLER	MANUF, MFR	MANUFACTURE(R)(D)	SD	SOAP DISPENSER		INTERIOR ELEVATION TAG		BATT INSULATION
AHU	AIR HANDLING UNIT	EWG-H	ELECTRIC WATER COOLER-HANDICAP ACCESSIBLE	MAT	MATERIAL(S)	SF	SQUARE FEET		REVISION TAG / REVISION CLOUD		GYPSUM BOARD AND/OR GRAVEL SURFACE
ALUM	ALUMINUM	EXP	EXPOSED	MECH	MECHANICAL	SPM	SANITARY FORCE MAIN		OFFICE		POROUS FILL AND/OR GRAVEL
APPROX	APPROXIMATE(LY)	EXIST	EXISTING(S)	MEMB	MEMBRANE	SHT	SHEET		ROOM NAME / NUMBER IDENTIFICATION TAG		UNDISTURBED SURROUNDING EARTH
ARCH	ARCHITECTURE(LURAL)	FD	FLOOR DRAIN	MET, MTL	METAL	SH	SHIM				COMPACTED FILL
ARGWB	ABUSE RESISTANT GYPSUM WALLBOARD	FEG	FIRE EXTINGUISHER CABINET	MDO	MEDIUM DENSITY OVERLAY	SPEC	SPECIFICATION(S)				
ASPH	ASPHALT	FEL	FINISH FLOOR LINE	MIN	MINIMUM, MINUTE	SQ	SQUARE				
AUTO	AUTOMATIC	FF	FINISH FLOOR	MIR	MIRROR	SS	STAINLESS STEEL				
BD	BOARD	FH	FIRE HYDRANT	MISC	MISCELLANEOUS	STD	STUD				
BIT	BITUMINOUS	FN	FINISH	MO	MASONRY OPENING	STL	STEEL				
BLDG	BUILDING	FRT	FIXTURE(S)	MTD	MOUNTED	STOR	STORAGE				
BLK, BLKS	BLOCK(ING)	FLOR	FLUORESCENT	MWP	METAL WALL PANEL	STR, STRUCT	STRUCTURE(AL)				
BM	BENCH MARK	FURR	FURRING	N/A	NOT APPLICABLE	SUSP	SUSPENDED				
BO	BOTTOM OF	FLEX	FLEXIBLE	NC	NOT IN CONTRACT	SYM	SYMMETRY(CAL)				
BOT	BOTTOM	FLR	FLOOR	NO, #	NUMBER	SYS	SYSTEM				
CAB	CABINET	FEE	FINISH FLOOR ELEVATION	NOM	NOMINAL	T&G, T&G	TONGUE AND GROOVE				
CB	CATCH BASIN	FFE	FURNITURE, FIXTURES & EQUIPMENT	NRC	NOISE REDUCTION COEFFICIENT	TB	TOWEL BAR				
CAC	COMMON ACCESS CARD	FT, FTG	FOOT(ING), FEET	NTS	NOT TO SCALE	TEL	TELEPHONE				
CBU	CEMENTITIOUS BACKER UNIT	FRP	FIBERGLASS REINFORCED PLASTIC	O.C.	ON CENTER	THK	THICKNESS				
CR	CIRCLE	GA	GAGE, GAUGE	OD	OUTSIDE DIAMETER	T.O	TOP OF				
CER	CERAMIC	GALV	GALVANIZED	OH	OVERHEAD	TOS	TOP OF STEEL				
OP	CAST IN PLACE	GL	GLASS, GLAZE(D)(ING)	OPER	OPERATOR	TPD	TOILET PAPER DISPENSER				
CHEM	CHEMICAL	GB	GRAB BAR	OPH	OPPOSITE HAND	TS	TUBE STEEL				
CJ	CONTROL / CONSTRUCTION JOINT	GBS	GYPSUM WALL BOARD	OPP	OPPOSITE	TYP	TYPICAL				
CL	CLOSET	GWB	GYPSUM WALL BOARD	OS	OVERFLOW SCUPPER	UG	UNDERGROUND				
CL	CENTERLINE	GYP	GYPSUM	PB	PRE-ENGINEERED BUILDING	UL	UNDERWRITERS LABORATORIES				
CLG	CEILING	HDP	HIGH DENSITY POLYETHYLENE	PED	PEDESTAL	UNF	UNFINISHED				
CLR	CLEAR	HDW	HARDWARE	PEJ	PREFORMED EXPANSION JOINT	UON	UNLESS OTHERWISE NOTED				
CMU	CONCRETE MASONRY UNIT	HGT, HT	HEIGHT	PL	PLATE	VCT	VINYL COMPOSITION TILE				
COL	COLUMN	HORZ	HORIZONTAL	PLAM	PLASTIC LAMINATE	VERT	VERTICAL				
CONC	CONCRETE	H.P.	HIGH POINT	PLYWD	PLYWOOD	VEST	VESTIBULE				
CONT	CONTINUE(OUS)	HOUR	HOUR	POL	PETROLEUM, OIL & LUBRICATION	V.F	VERIFY IN FIELD				
CORR	CORRIDOR	HVAC	HEATING, VENTILATION & AIR CONDITIONING	PRT	PORCELAIN TILE	VWF	VEHICLE MAINTENANCE FACILITY				
CPT	CARPET	D	INSIDE DIAMETER	PRET	PRESSURE TREATED	WVC	VINYL WALL COVERING				
CT	CERAMIC TILE	INFO	INFORMATION	PT	PRESSURE TREATED	W/	WITH				
DEMO	DEMOLISH, DEMOLITION	INFIL	INFILTRATION	PREFAB	PREFABRICATED	WD	WOOD				
DET, DTL	DETAIL	INSUL	INSULATE(D)(ON)	PREFN	PREFINISHED	WH, WHS	WAREHOUSE				
DIA	DIAMETER	INT	INTERIOR	PTD	PAINT/PAINTED	WN	WINDOW				
DIAG	DIAGONAL	IAW	IN ACCORDANCE WITH	RA	RETURN AIR	W/O	WITHOUT				
DM/DIMS	DIMENSION(S)	INV	INVERT	RAD	RADIUS	WPT	WORK POINT				
DSP	DISPENSER	R	IMPACT RESISTANT	RD	ROOF DRAIN	WRGWB	WATER RESISTANT GYPSUM WALLBOARD				
DN	DOWN			REF	REFERENCE	WWF	WELDED WIRE FABRIC				

GENERAL NOTES

1. PERFORM CONSTRUCTION WORK PER DIVISION 1 REQUIREMENTS.

2. DO NOT SCALE OR MEASURE ANY DRAWING. REFER TO DIMENSIONS AND NOTES ON DRAWINGS TO LOCATE WALLS AND CONSTRUCTION ITEMS. VERIFY THE FIGURES AND DIMENSIONS SHOWN ON THE DRAWINGS BEFORE STARTING ANY LAYOUT OF THE WORK.

3. REPORT ANY ERRORS, INACCURACIES, MISSING DIMENSIONAL REQUIREMENTS, OR CONFLICTS TO THE ARCHITECT IMMEDIATELY AND IN WRITING BEFORE BEGINNING ANY WORK.

4. WORK SHALL COMPLY WITH ALL APPLICABLE STATE AND LOCAL CODES, LAWS, AND STATUTES AS REQUIRED. STRICTLY ADHERE TO MANUFACTURERS' PRINTED INSTRUCTIONS.

5. REFER TO PLANS AND FLOOR/CEILING ASSEMBLIES FOR PARTITIONS REQUIRED TO HAVE FIRE RESISTANT RATINGS.

6. REFER TO FURNITURE/EQUIPMENT PLANS FOR EQUIPMENT, FURNITURE, AND FURNITURE ACCESSORY LOCATIONS. FURNITURE TO BE FURNISHED & INSTALLED BY OWNER UNLESS SPECIFIED OTHERWISE IN THE PROJECT MANUAL & IS NOT A PART OF THIS CONTRACT.

7. LOCATION OF STAGING AREAS, VEHICULAR AND PEDESTRIAN ACCESS TO THE SITE, AND GC PARKING SHALL BE FINALIZED DURING THE PRECONSTRUCTION MEETING. BUILDING AND SITE CHECK-IN PROCEDURES FOR CONSTRUCTION PERSONNEL WILL BE ADDRESSED AT THAT TIME.

8. PROVIDE ALL NECESSARY BARRIERS AND STRUCTURES REQUIRED TO KEEP THE CONSTRUCTION AREA FREE FROM UNAUTHORIZED VISITORS.

9. VERIFY THE LOCATIONS OF ALL EXISTING CONSTRUCTION INCLUDING EXISTING UTILITIES, BUILDINGS, SITE IMPROVEMENTS, TREES, ETC., AT THE JOB SITE. NOTIFY THE ARCHITECT IMMEDIATELY FOR CLARIFICATION IF ANY EXISTING CONDITIONS CONFLICT WITH THE DESIGN INTENT SHOWN ON THESE DRAWINGS.

10. DISPOSE OF ALL UNWANTED MATERIALS AND OTHER DEBRIS OFF SITE AS REQUIRED IN A LEGAL MANNER.

11. VERIFY IN WRITING, AND RECEIVE WRITTEN AUTHORIZATION FROM THE ARCHITECT PRIOR TO COMMENCEMENT OF ANY CHANGES TO THE WORK.

12. DIMENSIONS SHOWN ON ARCHITECTURAL FLOOR PLANS AND ENLARGED PLAN DETAILS ARE TO FACE OF FINISH FACE OF MASONRY, FACE OF CONCRETE, OR TO THE CENTERLINE OF COLUMN UNLESS NOTED OTHERWISE.

13. INSTALL ADDITIONAL NONCOMBUSTIBLE, CONCEALED, HORIZONTAL AND/OR VERTICAL BLOCKING AND STRAPPING AS REQUIRED WITHIN STUD AND JOIST SPACES FOR THE SECURE ANCHORAGE OF ALL ITEMS TO BE MOUNTED ON FLOOR, WALL, AND CEILING SURFACES. COORDINATE THE REQUIRED BLOCKING WITH THE ACTUAL ITEMS SELECTED. REFER TO ARCHITECTURAL MILLWORK, FURNITURE/EQUIPMENT, M.E.P./F.P. DRAWINGS FOR ALL ITEMS TO BE WALL/CEILING/FLOOR MOUNTED. ALL WOOD BLOCKING, FRAMING MEMBERS, STUDS, PLYWOOD SHEATHING, ETC., SHALL BE FIRE RETARDANT TREATED PER 2003 IBC/2003 CT, SECTION 603.1.
14. COORDINATE THE DIMENSIONS FOR FRAMED OPENINGS FOR ALL BUILT-IN ITEMS, INCLUDING EQUIPMENT AND FIXTURES, CASEWORK, AND ACCESSORIES, ETC., BASED ON THE ACTUAL ITEMS SELECTED BEFORE INSTALLATION.

15. SECTIONS, DETAILS, NOTES, DIMENSIONS, AND CONDITIONS ARE APPLICABLE AT OTHER LOCATIONS WHERE CONDITIONS AND DETAILS ARE SIMILAR BUT NOT SPECIFICALLY NOTED AS SUCH OR ARE NOT SHOWN.

16. PRESTOPPING MUST CONSIST OF APPROVED NONCOMBUSTIBLE MATERIALS SECURELY FASTENED IN PLACE.

17. LOCATIONS FOR REQUIRED PRESTOPPINGS WILL INCLUDE, BUT NOT BE LIMITED TO, THE FOLLOWING AREAS:

17.1. IN CONCEALED SPACES OF STUD WALLS AND PARTITIONS, AT THE CEILING AND FLOOR OR ROOF LEVELS.

17.2. AT CONCEALED SPACES BETWEEN STAIRWAY STRINGERS AT THE TOP AND BOTTOM OF THE RUN.

17.3. AT OPENINGS AROUND ELEMENTS PENETRATING FIRE RESISTIVE CONSTRUCTION.

17.4. IN THE SPACES BEHIND COMBUSTIBLE TRIM AND FINISH AND ALL OTHER HOLLOW SPACES WHERE PERMITTED IN FIRE RESISTANCE RATED CONSTRUCTION AT TEN FOOT INTERVALS, OR THE SPACE SHALL BE SOLIDLY FILLED WITH NONCOMBUSTIBLE MATERIALS.

18. WHERE DIFFERENT FLOOR TYPES MEET AND NO SADDLE IS INDICATED, LOCATE THE TRANSITION DIRECTLY BELOW THE CENTER OF THE DOOR.

19. ALL MATERIALS & EQUIPMENT ARE NEW UNLESS OTHERWISE NOTED AS "EXISTING".

20. ALL EXISTING UTILITIES & EQUIPMENT LOCATIONS ARE APPROXIMATE - CONTRACTOR SHALL FIELD VERIFY EXACT LOCATIONS IN FIELD.

21. CONTRACTOR IS RESPONSIBLE FOR REPLACING ANY DAMAGED ITEMS & EQUIPMENT DURING CONSTRUCTION AT NO ADDITIONAL COST TO THE OWNER.








22. ALL RATED DOORS & DOORS FRONTING A CORRIDOR SHALL HAVE POSITIVE LATCHING LOCKSETS UNLESS OTHERWISE INDICATED ON DOOR SCHEDULE.

23. PROVIDE TACTILE WARNING AT ALL DOORS LEADING TO HAZARDOUS AREAS.

24. PROVIDE PANIC EXIT DEVICES AT ALL DOORS WITH AN EXIT CAPACITY OF 100 PERSONS OR MORE.

25. PROVIDE ADA ACCESSIBLE DOOR HARDWARE AT ALL ACCESSIBLE MEANS OF EGRESS TO COMPLY WITH UNIFORM FEDERAL ACCESSIBILITY STANDARDS.



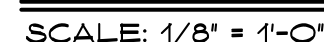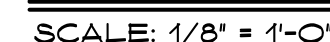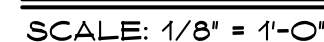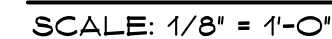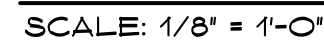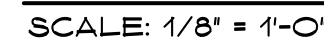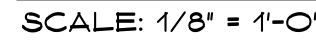

Revision:	Description:	Date:	Revised By:

Drawing Title:

Andrew Ave ES Casework Upgrades

Date:
JUNE 14, 2016

Scale:
AS NOTED

Drawn By:
RH

Project Number:
16.041

Drawing Number:

A101

GENERAL NOTES

1. TEMPORARILY REMOVE & REINSTALL EXISTING BUILT-IN COMPONENTS (INCLUDING, BUT NOT LIMITED TO SHELVING, STORAGE CUBBIES, LOCKERS, WARDROBES, STORAGE CABINETS, ETC.) AS REQUIRED TO PROVIDE THE WORK. PROTECT ANY REMOVED ITEM/ASSEMBLY AND REPAIR DAMAGE CAUSED DURING CONSTRUCTION & REINSTALL TO MATCH EXISTING. CONTRACTOR TO FIELD VERIFY EXISTING CONDITIONS AT EACH AREA OF WORK. AS CONDITIONS MAY VARY BY ROOM/LOCATION.
2. DIMENSIONS & LAYOUTS SHOWN ON THE DRAWINGS ARE APPROXIMATE BASED ON EXISTING AS-BUILT DRAWINGS PROVIDED BY THE OWNER AND MAY NOT REFLECT ACTUAL FIELD CONDITIONS - CONTRACTOR IS RESPONSIBLE FOR FIELD VERIFYING ALL DIMENSIONS AND CONDITIONS, INCLUDING FIELD-VERIFIED DIMENSIONS, CONFIGURATIONS AND FINISHES. NOTIFY THE ARCHITECT IMMEDIATELY UPON DISCOVERY OF ANY DISCREPANCIES.
3. CONTRACTOR IS REQUIRED TO VISIT THE SITE AND BECOME FULLY FAMILIAR WITH THE EXISTING CONDITIONS AND THE SCOPE OF WORK PRIOR TO SUBMITTING A BID.
4. HAZARDOUS MATERIALS ARE PRESENT ADJACENT TO THE WORK AREA OF THIS PROJECT - EXERCISE CARE TO AVOID DISRUPTING EXISTING GYPSUM BOARD CEILING INSIDE EXISTING CLOSET SPACES. REFER TO HAZMAT REPORT FOR MORE INFORMATION.
5. COORDINATE ALL WORK ACTIVITIES WITH HAZMAT REPORT, HAZMAT DRAWINGS & HAZMAT SPECIFICATIONS.

DEMOLITION NOTES

1. REMOVE (2) PAIRS OF EXISTING PIVOTING & (2) SWING CLOSET DOORS, INCLUDING HARDWARE.
2. REMOVE EXISTING WALL MOUNTED SHELVING & COAT HOOK ASSEMBLY & PORTION OF EXISTING TEACHER STORAGE SHELVING - PROTECT EXISTING PORTION TO REMAIN.
3. REMOVE EXISTING WALL & BASE CABINET ASSEMBLY (INCLUDING COUNTERTOP, SHELVING, BACKSPLASH & PLUMBING FIXTURES, ETC) BACK TO EXISTING WALL SUBSTRATE. REFER TO PLUMBING NOTES FOR MORE INFORMATION. PREP EXISTING SUBSTRATES TO RECEIVE NEW CASEWORK & FINISHES. NOTE: NO WALL CABINETS PRESENT AT CLASSROOMS 01 & 02.
4. REMOVE PORTION OF EXISTING RESILIENT FLOORING TILES TO A POINT TWO FULL TILES BEYOND THE FACE OF THE EXISTING CASEWORK (COORDINATE WITH HAZMAT). REMOVE PORTION OF EXISTING RUBBER WALL BASE AT WORK AREA.

CONSTRUCTION NOTES

1. PROVIDE BASE & WALL CABINET ASSEMBLY WITH SOLID SURFACE COUNTERTOP & BACKSPLASH AND SINK - REFER TO CASEWORK DETAILS & PLUMBING NOTES.
2. PROVIDE DOOR & FRAME ASSEMBLY, FABRICATE WOOD FRAME TO MATCH & INTEGRATE WITH EXISTING HARDWOOD TRIM @ CLOSET AREA.
3. PREP EXISTING TRANSPARENT FINISH ON HARDWOOD TRIM @ PERIMETER OF OPENING TO RECESSED CLOSET AREA AS REQ'D TO PROVIDE PAINTED FINISH. PAINT WOOD TRIM, INCLUDING PORTION ATTACHED TO CLOSET CELING, (DASHED LINE INDICATES EXIST. FRAMED OPENING & TRIM/CASING ABOVE)
4. PROVIDE CUSTOM FABRICATED TWO-TIER STORAGE CUBBY CASEWORK ASSEMBLY W/ (24) CUBBIES. PROVIDE EACH CUBBY WITH (3) COAT HOOKS. REFER TO CASEWORK DETAILS FOR MORE INFORMATION.
5. PATCH, REPAIR, & REPOINT EXPOSED PORTIONS OF EXISTING CMU WALLS WITHIN CLOSET & CASEWORK AREA (N.I.F.).
6. PROVIDE RESILIENT TILE FLOORING FINISH AT AREA OF REMOVED TILES - MATCH EXISTING ADJACENT TILES TO REMAIN. PROVIDE RUBBER WALL BASE TO MATCH EXISTING.
7. PREP, PRIME & PAINT EXISTING CMU & GWB WALLS AND GWB CEILING AT CLOSET.

PLUMBING NOTES

GENERAL NOTES:
REFER TO ARCHITECTURAL DRAWINGS FOR EXACT EXTENT OF
PROPOSED WORK. EXISTING SYSTEMS TAKEN FROM LIMITED RECORD
DRAWINGS AND VERIFICATION OF READILY VISIBLE FIELD
CONDITIONS. CONTRACTOR SHALL VERIFY IN FIELD ALL EXISTING
SYSTEMS AND ADJUST FINAL DEMOLITION AND NEW WORK TO
COORDINATE WITH SAME.

DISCONNECT AND REROUTE ANY EXISTING PLUMBING PIPING WHICH MUST REMAIN IN SERVICE AND WHICH IS PRESENTLY ROUTED IN WALLS, CEILINGS, ETC. IN AREAS TO BE DEMOLISHED.


REMOVE AND LEGALLY DISPOSE OF EXISTING FIXTURES COMPLETE WITH FAUCETS, ACCESSIBLE SUPPLIES, TRAPS, DRAINS, WASTE AND VENT PIPING, AND ALL OTHER RELATED TRIM.

NOTE: PROVIDE TRUEBRO MODEL 103 (WHITE), ANTI-MICROBIAL HAND LAV-GUARDS INSTALLATION KIT FOR ADA LAVATORY SINKS AT WATER SUPPLY & WASTE LINES.

PLUMBING KEY NOTES

- ① CONTRACTOR SHALL FURNISH AND INSTALL CLASSROOM SINK AND FAUCET AS PER THE SPECIFICATIONS. CONNECT TO EXISTING SINK UTILITIES (DOMESTIC COLD & HOT WATER, SANITARY, VENT). FURNISH AND INSTALL NEW DOMESTIC WATER STOP VALVES, SANITARY DRAINS AND TRAPS, INSULATION, SPECIALTIES, ETC., AS REQUIRED FOR A COMPLETE AND FULLY-FUNCTIONING FIXTURE INSTALLATION.
- ② CONTRACTOR SHALL FURNISH AND INSTALL CLASSROOM SINK, FAUCET AND DRINKING FOUNTAIN BUBBLER AS PER THE SPECIFICATIONS. CONNECT TO EXISTING SINK UTILITIES (DOMESTIC COLD & HOT WATER, SANITARY, VENT). FURNISH AND INSTALL NEW DOMESTIC WATER STOP VALVES, SANITARY DRAINS AND TRAPS, INSULATION, SPECIALTIES, ETC., AS REQUIRED FOR A COMPLETE AND FULLY-FUNCTIONING FIXTURE INSTALLATION.

Project Title:
Borough of Naugatuck
District Wide S
497 Rubber Ave
Naugatuck, Connecticut 06770

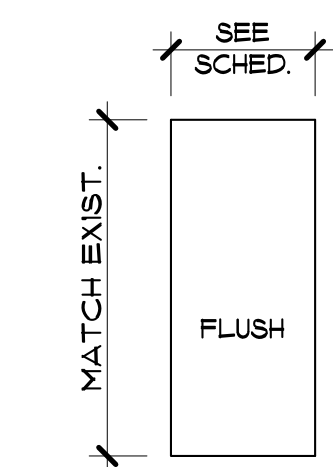


TYPE 1

DOOR TYPES

SCALE: 1/4" = 1'-0"

8
A102

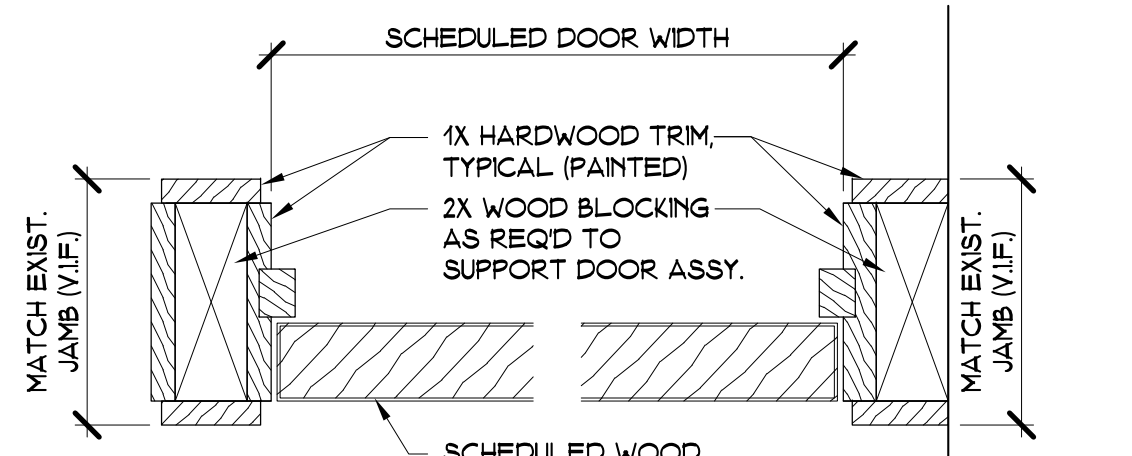


NOTE: ALIGN WOOD JAMB FRAMING & TRIM WITH EXISTING WOOD HEAD & JAMB FRAMING TO REMAIN AT EXISTING CLOSET AREA

DOOR JAMB DETAIL (TYP)

SCALE: 3" = 1'-0"

9
A102

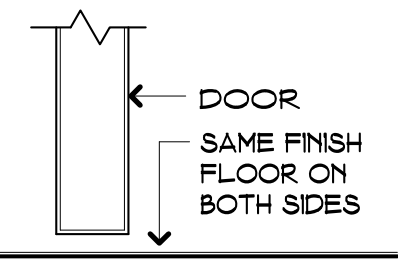

TYPE A

SADDLE DETAIL

SCALE: 3" = 1'-0"

10
A102

DOOR SCHEDULE

DOOR NUMBER	ROOM NUMBER	ROOM NAME	DOOR		FRAME		FIRE RATING	HARDWARE - SEE PROJECT MANUAL		REMARKS
			SIZE	DOOR TYPE - SEE 8/A102	NATURAL	HEAD DETAIL		FIRE CODE	ACCESSIBILITY REQ'S	
03	03	CLASSROOM	DOUBLE LEAF DOOR	1	WD	WD	9	9	10	
04	04	CLASSROOM	CASED OPENING	1	WD	WD	9	9	10	
05	05	CLASSROOM	1	WD	WD	WD	9	9	10	
06	06	CLASSROOM	1	WD	WD	WD	9	9	10	
07	07	CLASSROOM	1	WD	WD	WD	9	9	10	
08	08	CLASSROOM	1	WD	WD	WD	9	9	10	
09	09	CLASSROOM	1	WD	WD	WD	9	9	10	
10	10	CLASSROOM	1	WD	WD	WD	9	9	10	
11	11	CLASSROOM	1	WD	WD	WD	9	9	10	
12	12	CLASSROOM	1	WD	WD	WD	9	9	10	
13	13	CLASSROOM	1	WD	WD	WD	9	9	10	
14	14	CLASSROOM	1	WD	WD	WD	9	9	10	

GENERAL DOOR NOTES

- CONTRACTOR SHALL FIELD VERIFY ALL CONDITIONS & DIMENSIONS AND NOTIFY ARCHITECT IMMEDIATELY OF ANY DISCREPANCIES.
- PROVIDE FIELD FABRICATED WOOD FRAMES/JAMBS & UTILIZE EXISTING WOOD HEAD TRIM & CLOSET OPENING.
- REFER TO PROJECT MANUAL FOR ADDITIONAL DOOR HARDWARE REQUIREMENTS.


ROOM FINISH SCHEDULE

NO.	ROOM NAME	FLOOR		BASE	WALL FINISH				CEILING		NOTES
		SUBSTRATE (EX - V.I.F.)	FLR. FIN.		NORTH	SOUTH	EAST	WEST	MAT'L.	FINISH	
01	CLASSROOM	CONC.	VCT	RB	E.T.R.	E.T.R.	E.T.R.	E.T.R.	E.T.R.	E.T.R.	
02	CLASSROOM	CONC.	VCT	RB	E.T.R.	E.T.R.	E.T.R.	E.T.R.	E.T.R.	E.T.R.	
03	CLASSROOM	CONC.	VCT	RB	E.T.R.	E.T.R.	E.T.R.	E.T.R.	E.T.R.	E.T.R.	
04	CLASSROOM	CONC.	VCT	RB	E.T.R.	E.T.R.	E.T.R.	E.T.R.	E.T.R.	E.T.R.	
05	CLASSROOM	CONC.	VCT	RB	E.T.R.	E.T.R.	E.T.R.	E.T.R.	E.T.R.	E.T.R.	
06	CLASSROOM	CONC.	VCT	RB	E.T.R.	E.T.R.	E.T.R.	E.T.R.	E.T.R.	E.T.R.	
07	CLASSROOM	CONC.	VCT	RB	E.T.R.	E.T.R.	E.T.R.	E.T.R.	E.T.R.	E.T.R.	
08	CLASSROOM	CONC.	VCT	RB	E.T.R.	E.T.R.	E.T.R.	E.T.R.	E.T.R.	E.T.R.	
09	CLASSROOM	CONC.	VCT	RB	E.T.R.	E.T.R.	E.T.R.	E.T.R.	E.T.R.	E.T.R.	
10	CLASSROOM	CONC.	VCT	RB	E.T.R.	E.T.R.	E.T.R.	E.T.R.	E.T.R.	E.T.R.	
11	CLASSROOM	CONC.	VCT	RB	E.T.R.	E.T.R.	E.T.R.	E.T.R.	E.T.R.	E.T.R.	
12	CLASSROOM	CONC.	VCT	RB	E.T.R.	E.T.R.	E.T.R.	E.T.R.	E.T.R.	E.T.R.	
13	CLASSROOM	CONC.	VCT	RB	E.T.R.	E.T.R.	E.T.R.	E.T.R.	E.T.R.	E.T.R.	
14	CLASSROOM	CONC.	VCT	RB	E.T.R.	E.T.R.	E.T.R.	E.T.R.	E.T.R.	E.T.R.	

GENERAL FINISH NOTES

- SCHEDULED FLOOR & BASE FINISHES APPLY TO CLOSET, CASEWORK & PARTIAL CLASSROOM AREA OF WORK WHERE EXIST. FINISHES ARE TO BE REMOVED.
- PROVIDE PAINTED FINISH AT ALL EXISTING CMU & GWB SUBSTRATES WITHIN WORK AREA, INCLUDING CLOSET CEILINGS.
- PATCH/REPAIR, PREP & PAINT ANY EXISTING FINISHED SURFACE DAMAGED DURING CONSTRUCTION ACTIVITIES - MATCH EXISTING FINISHES (V.I.F.)


FINISH SCHEDULE LEGEND	
ACT	ACCOUSTICAL CEILING TILE
PT	PAINTED GYP BOARD
RB	RUBBER BASE
E.T.R.	EXISTING TO REMAIN
CT	CERAMIC WALL TILE
CPT	CERAMIC FLOOR TILE
CWB	CERAMIC WALL BASE
VCT	VINYL COMPOSITION TILE
GWB	OTHER WALLBOARD
CONC.	CONCRETE FLOOR/CEILING

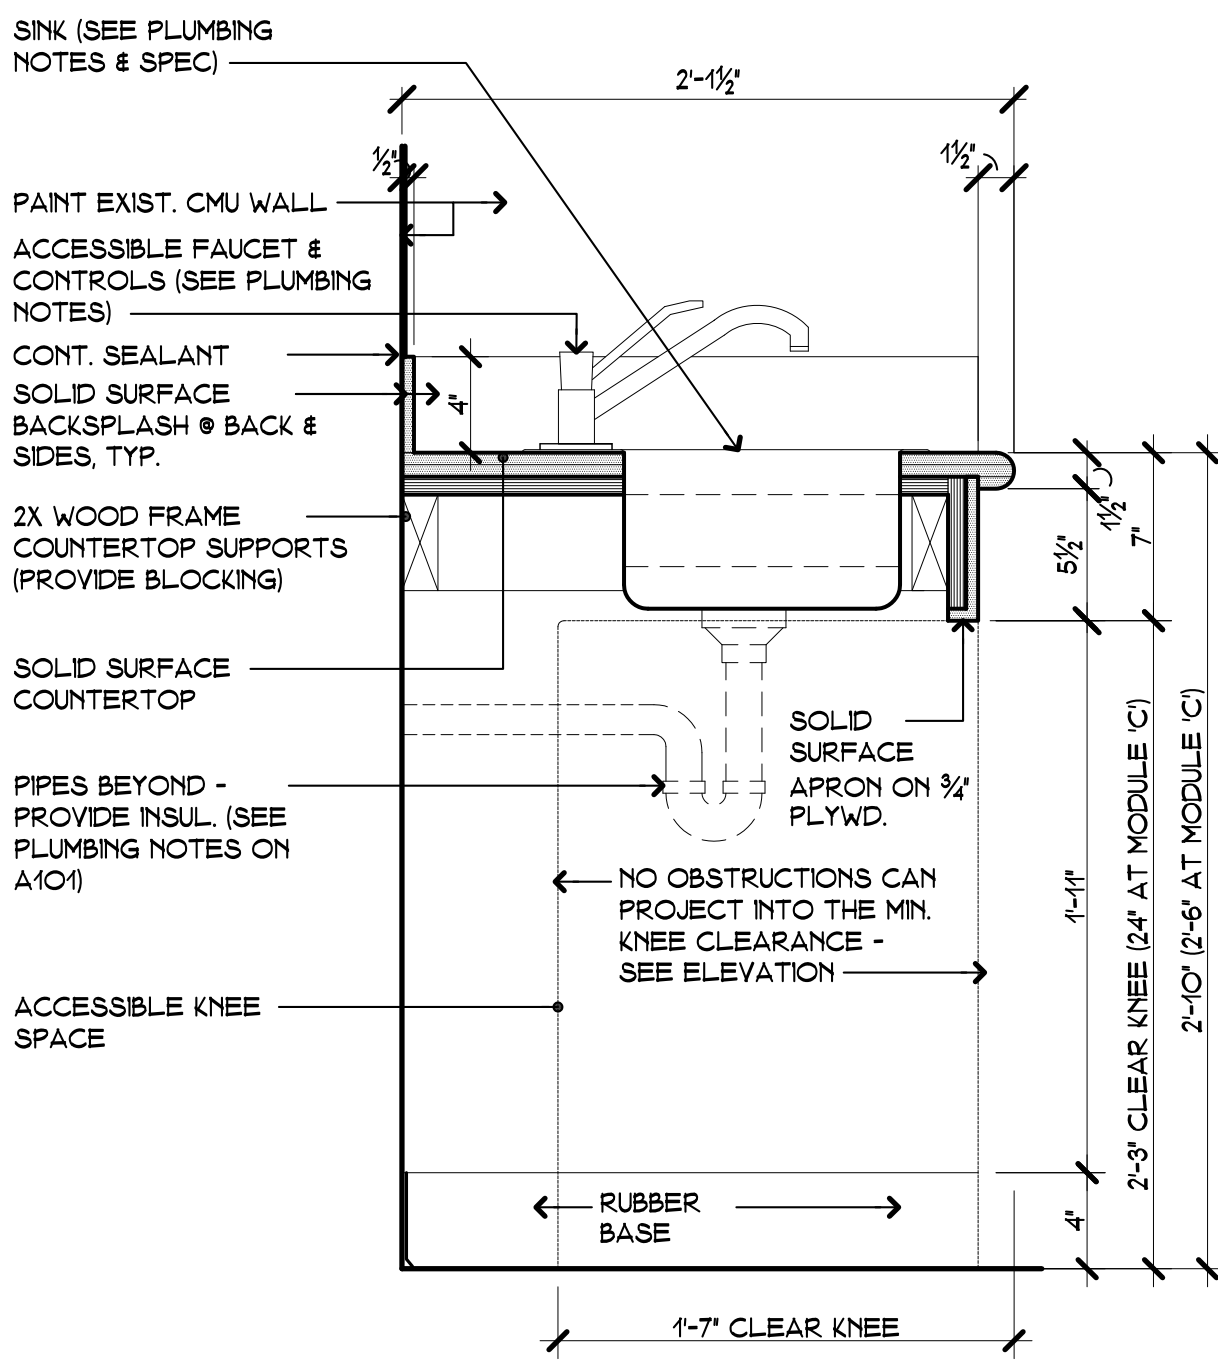

ACCESSIBLE SINK DETAIL

SCALE: 1/2" = 1'-0"


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A102

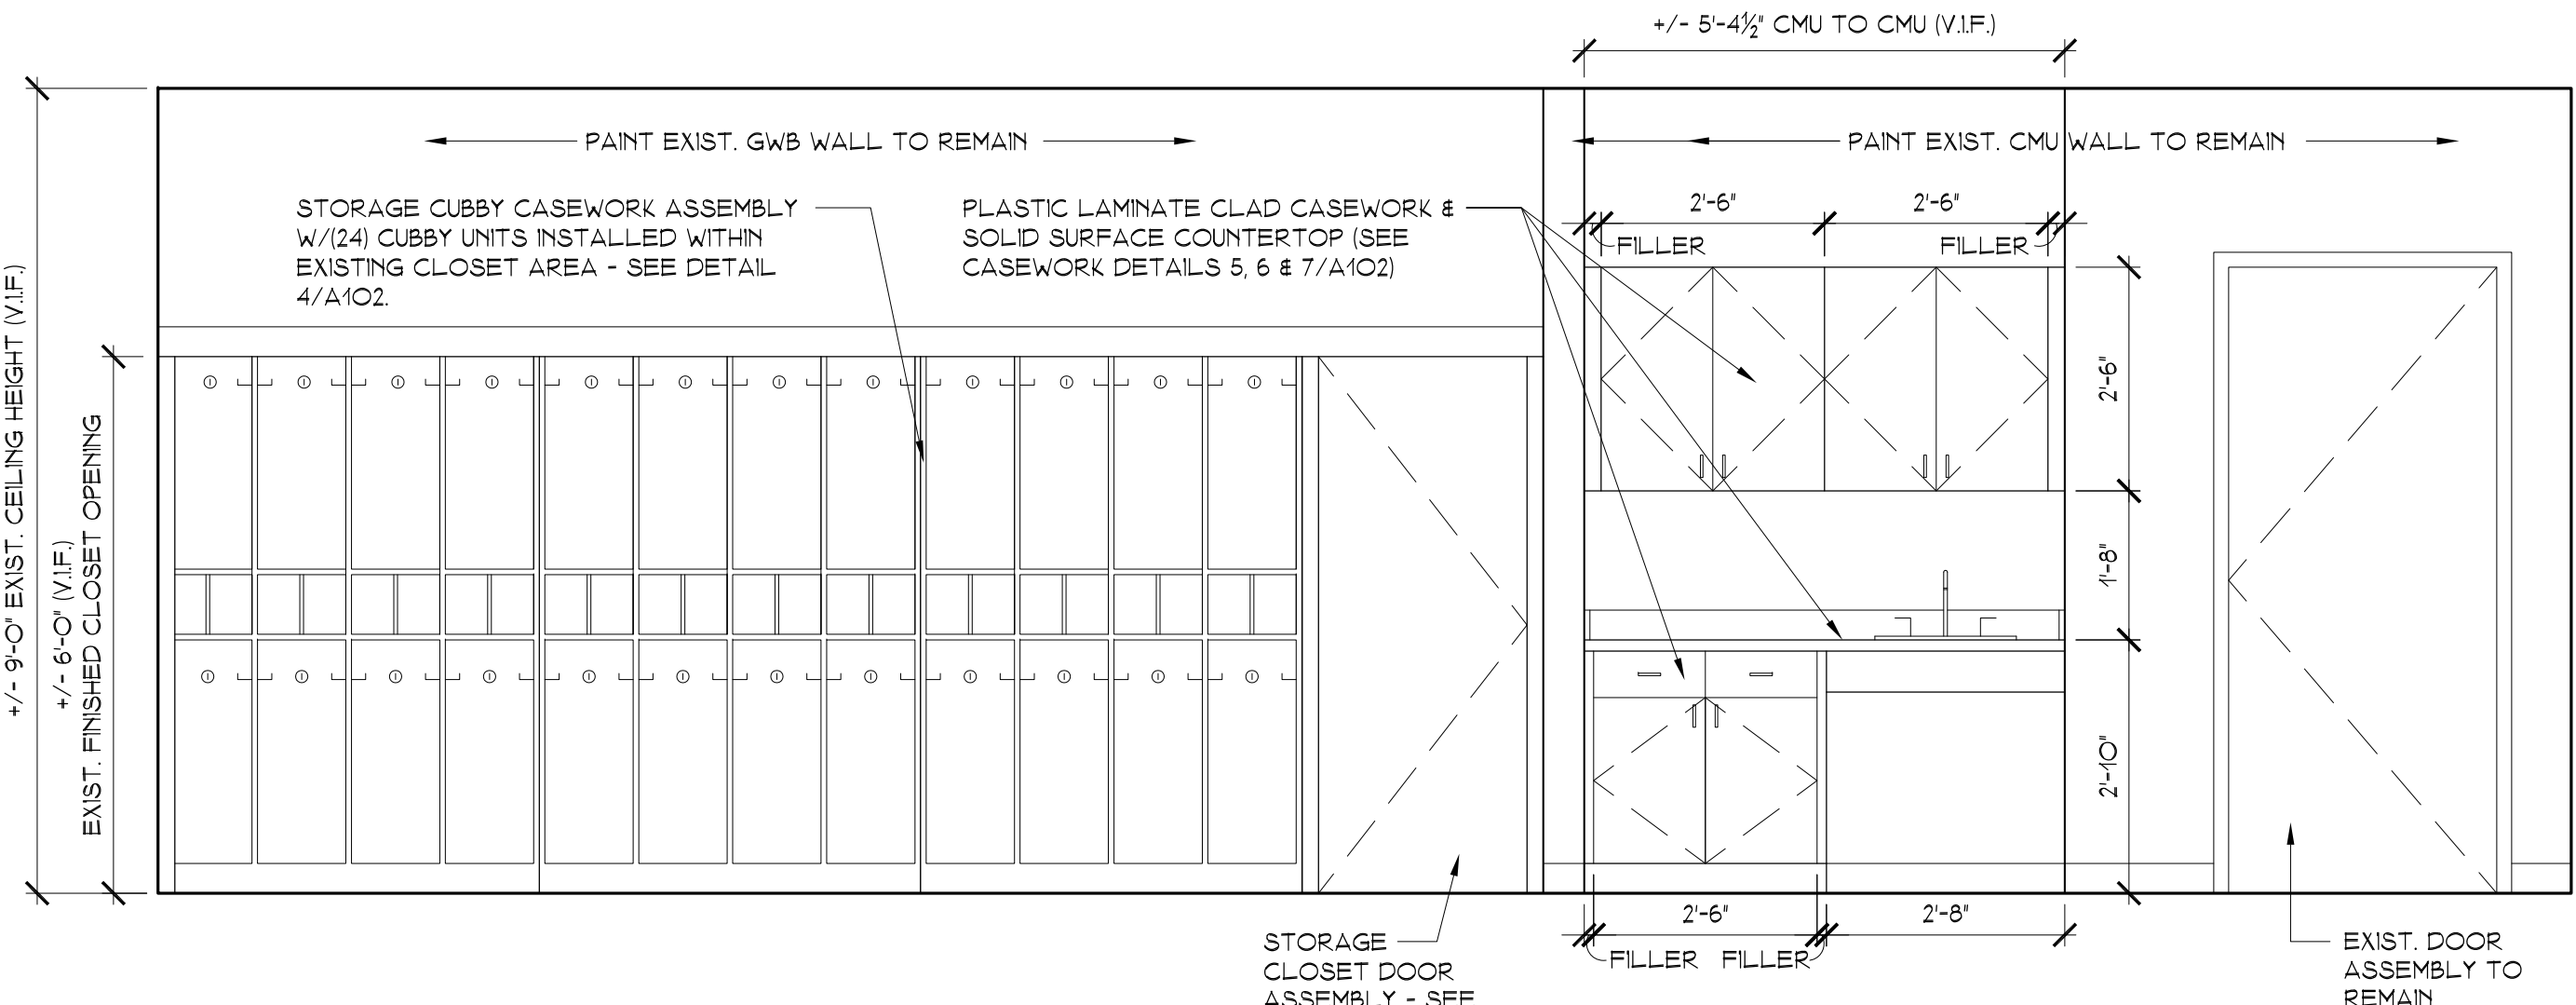

MODULE 'A' INTERIOR ELEVATION

SCALE: 1/2" = 1'-0"


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A102

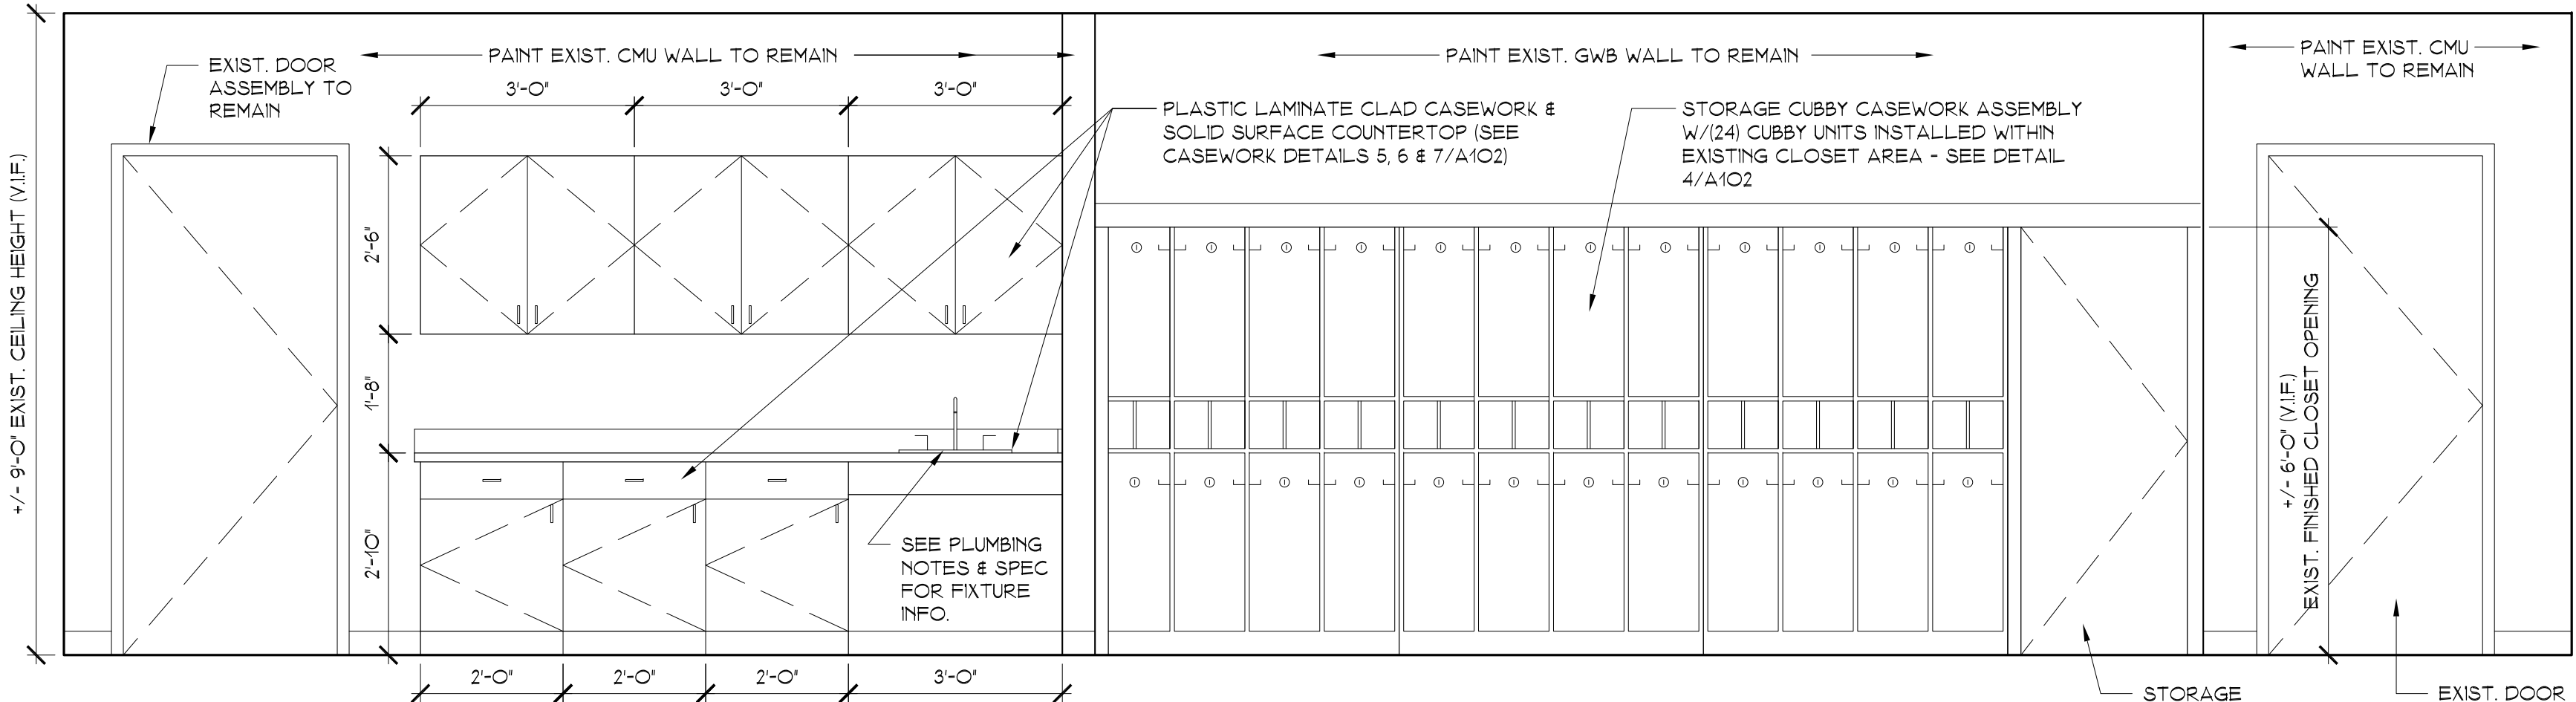

MODULE 'B' INTERIOR ELEVATION

SCALE: 1/2" = 1'-0"


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A102

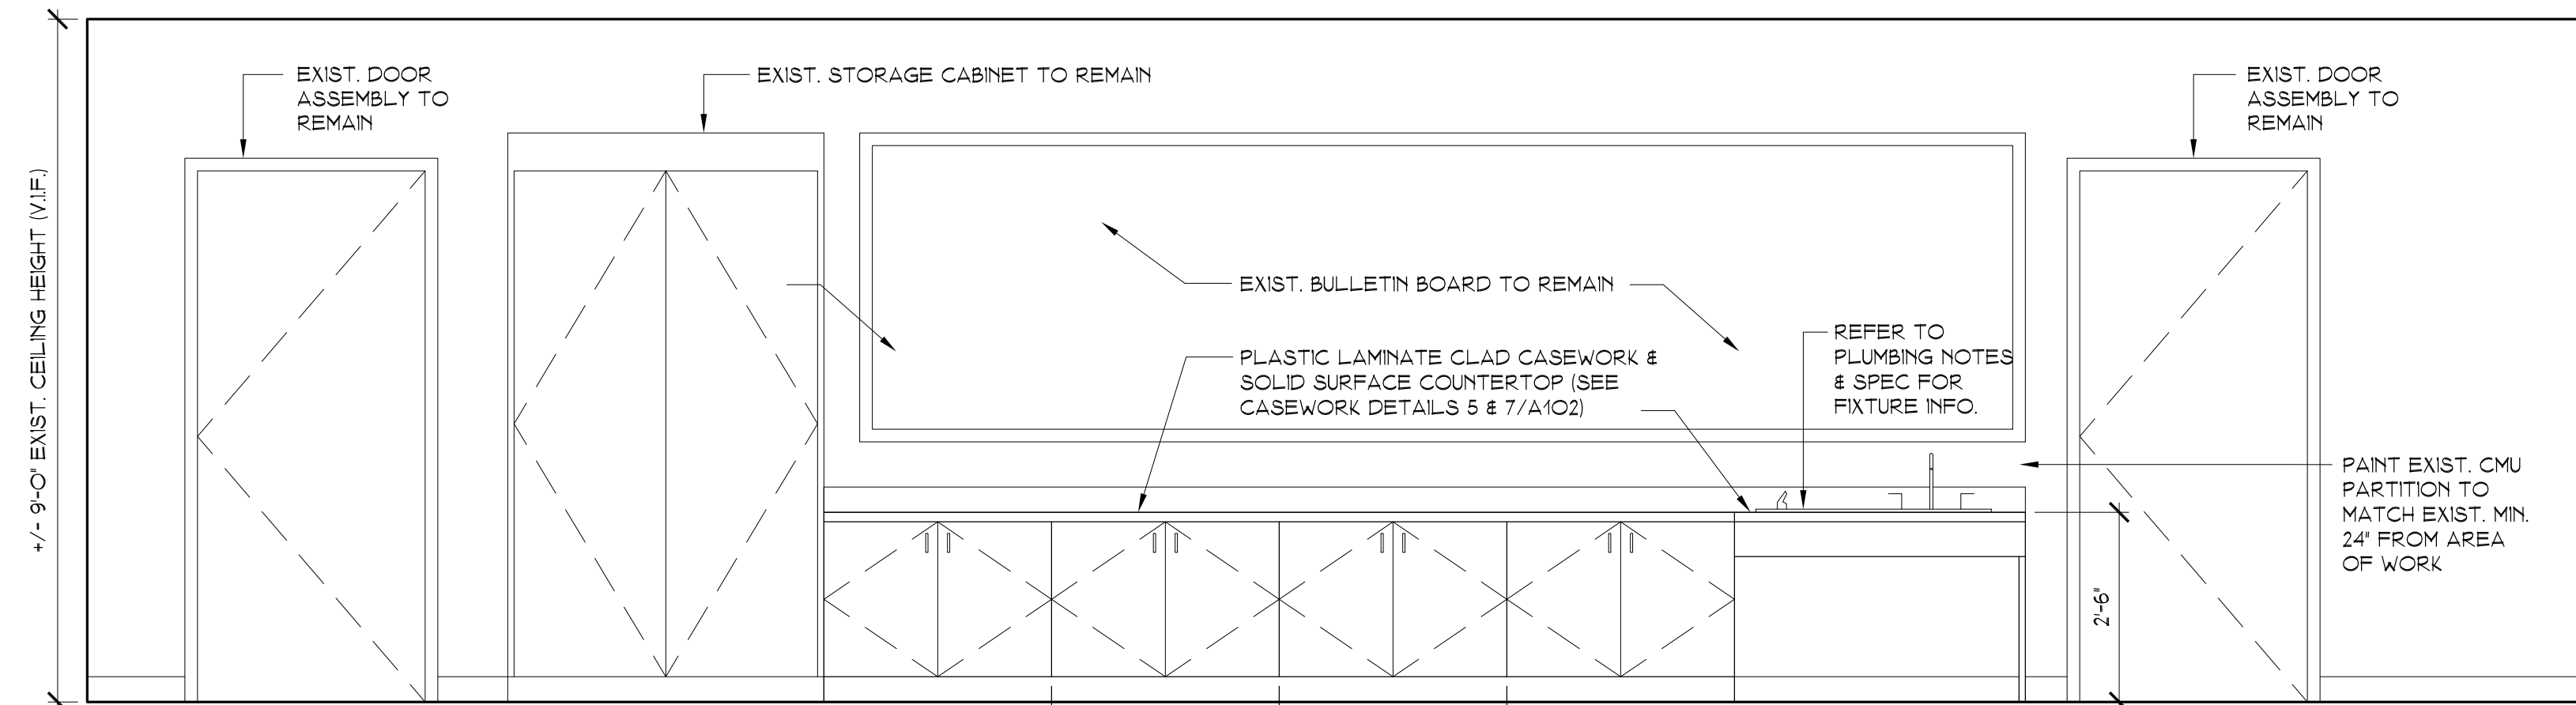


MODULE 'B' INTERIOR ELEVATION

SCALE: 1/2" = 1'-0"

3
A102

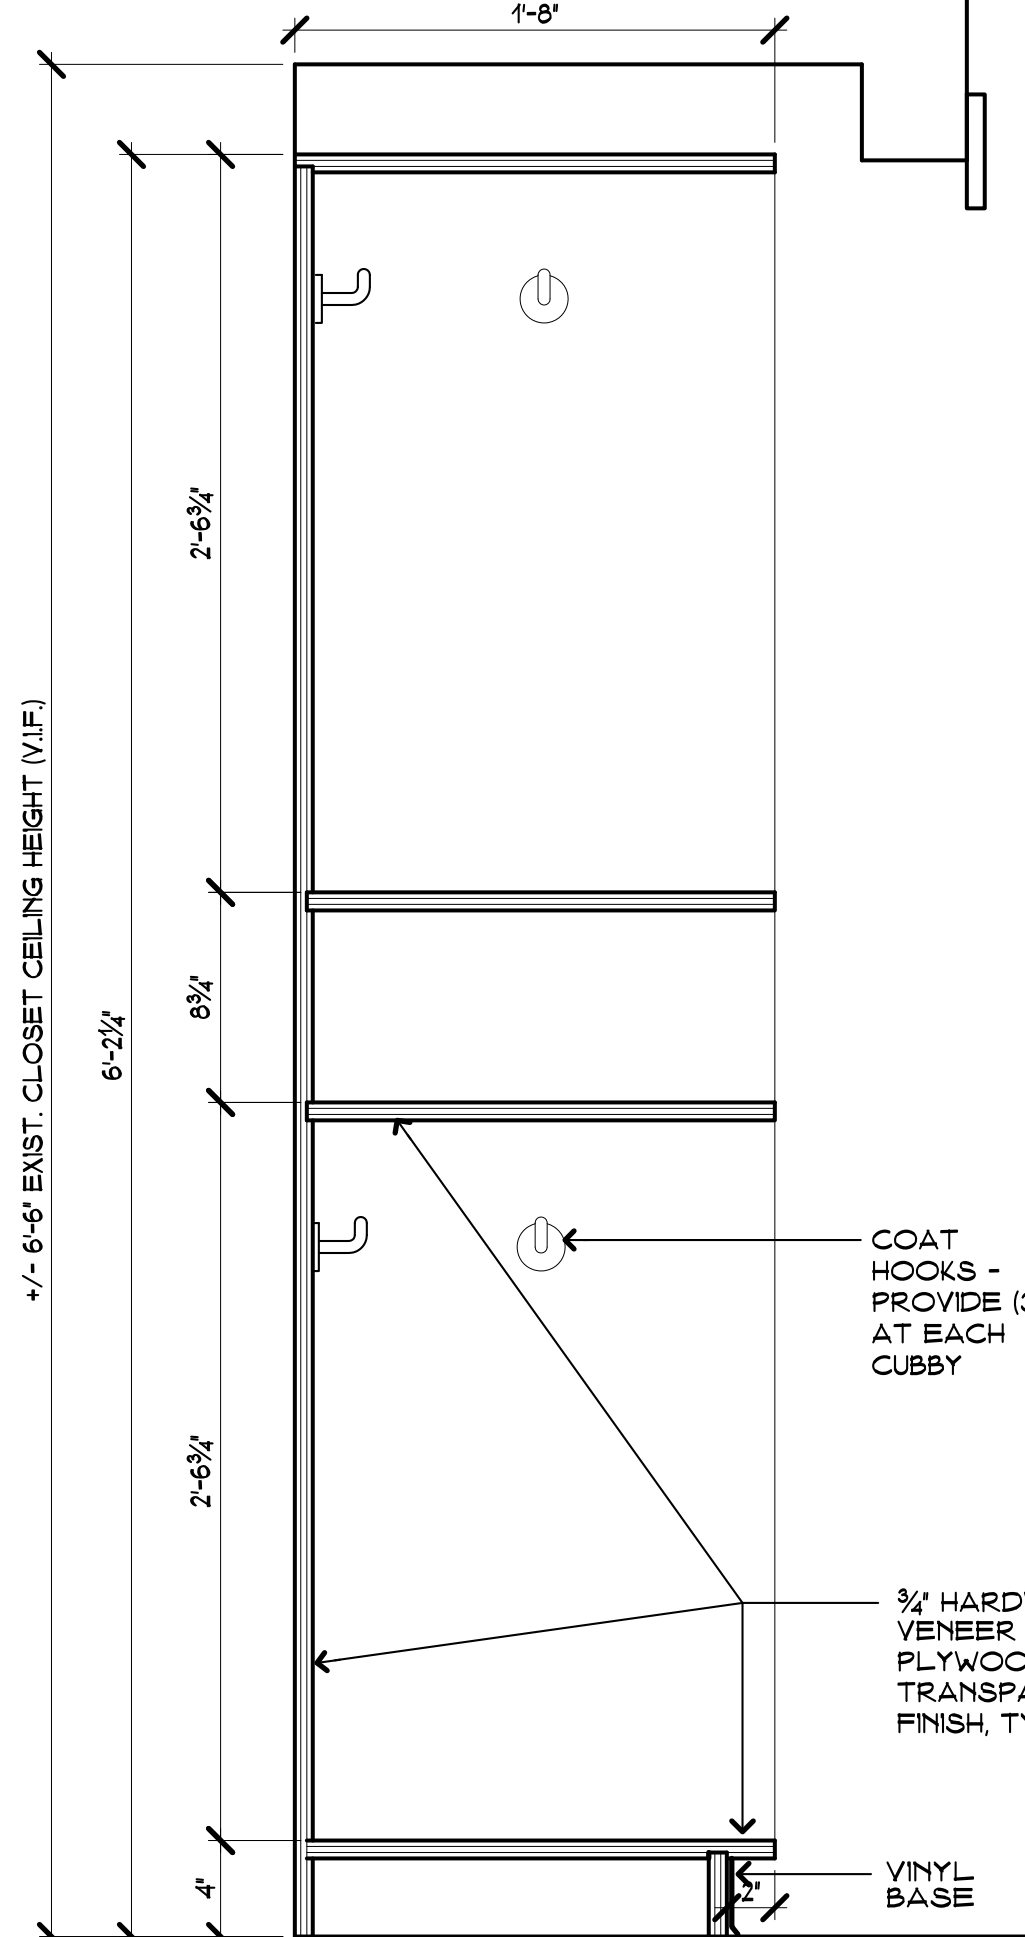

SECTION

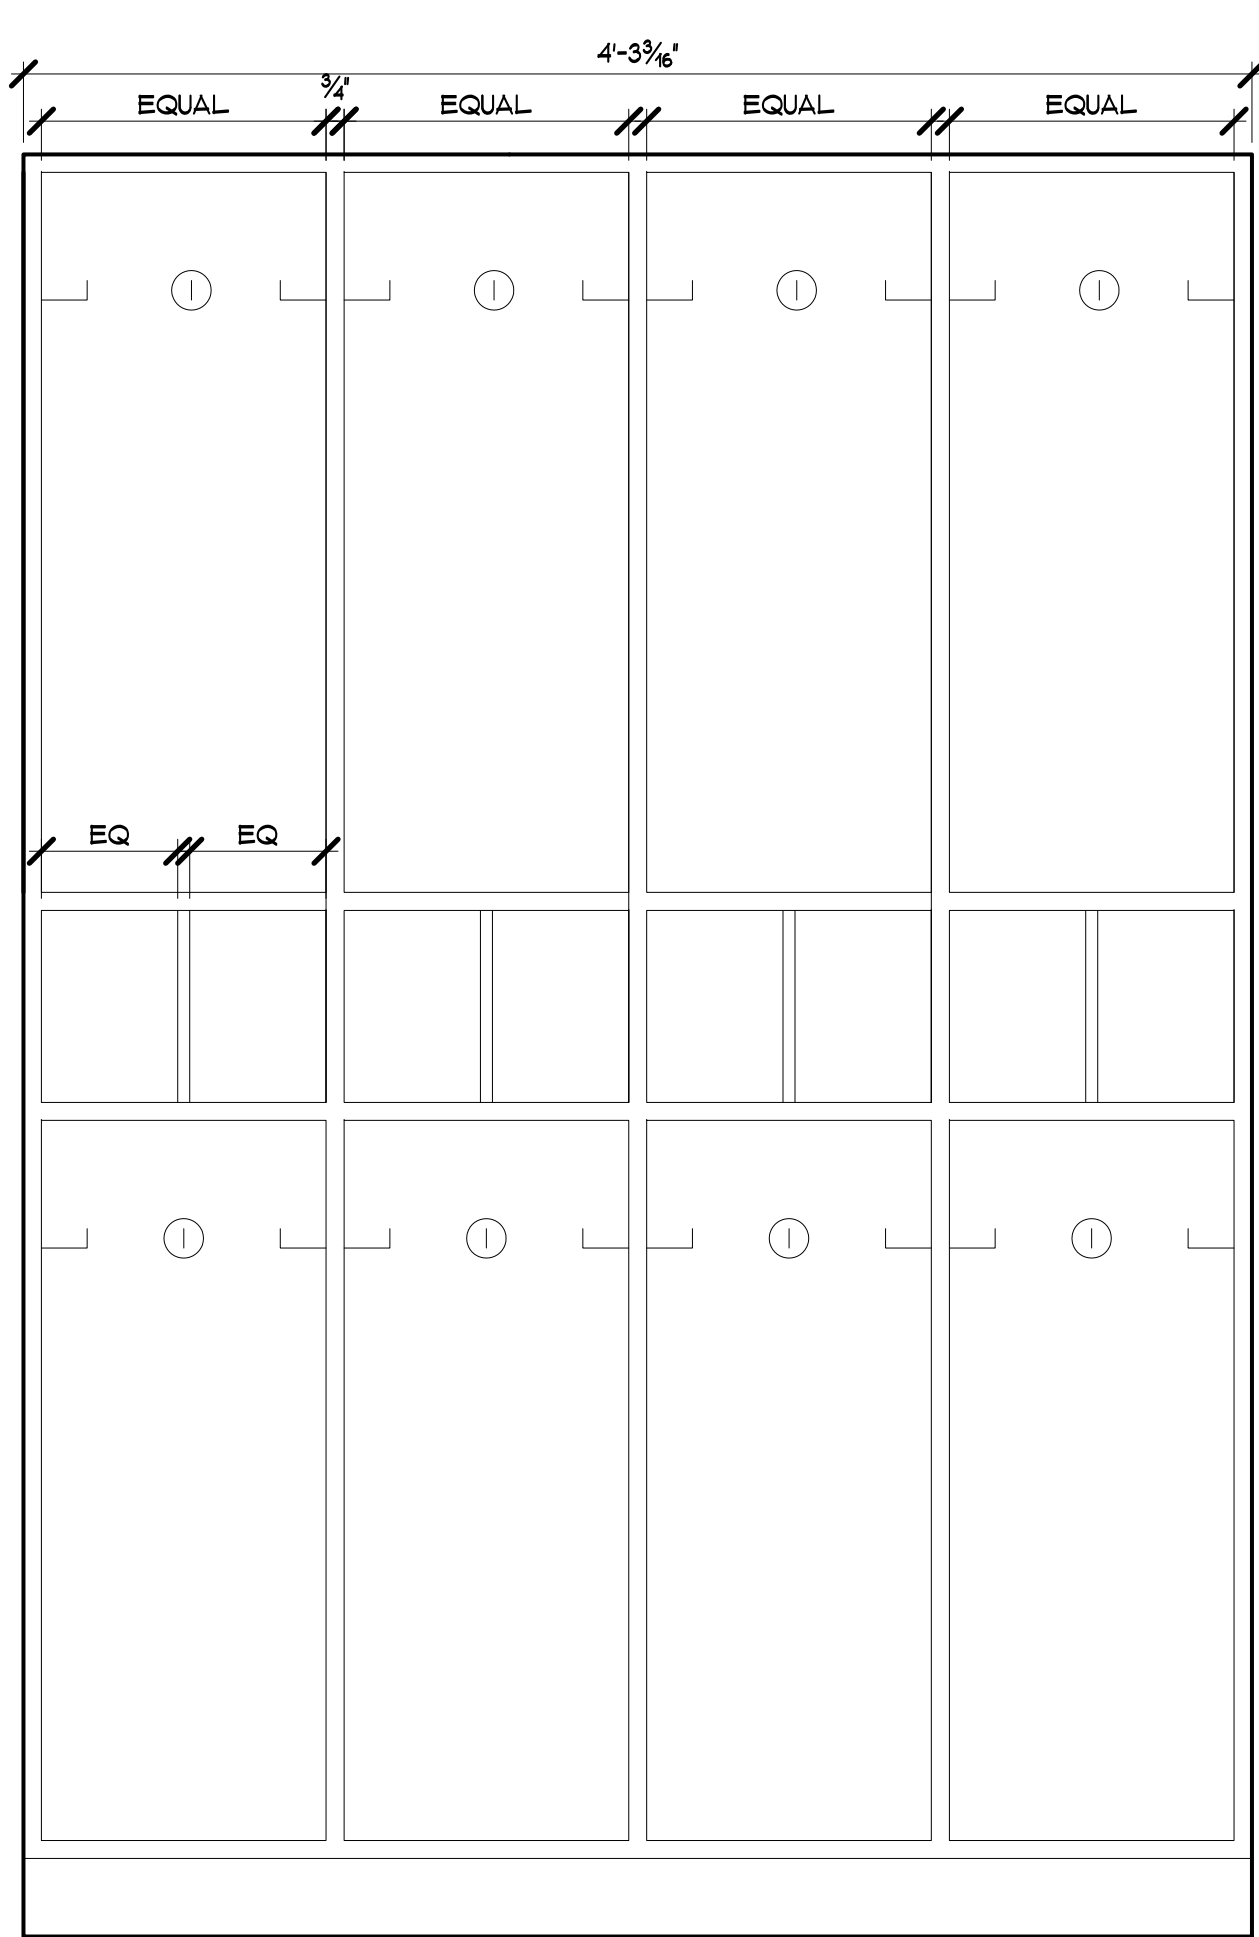


ELEVATION

STORAGE CUBBY DETAIL

SCALE: 1 1/2" = 1'-0"


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A102

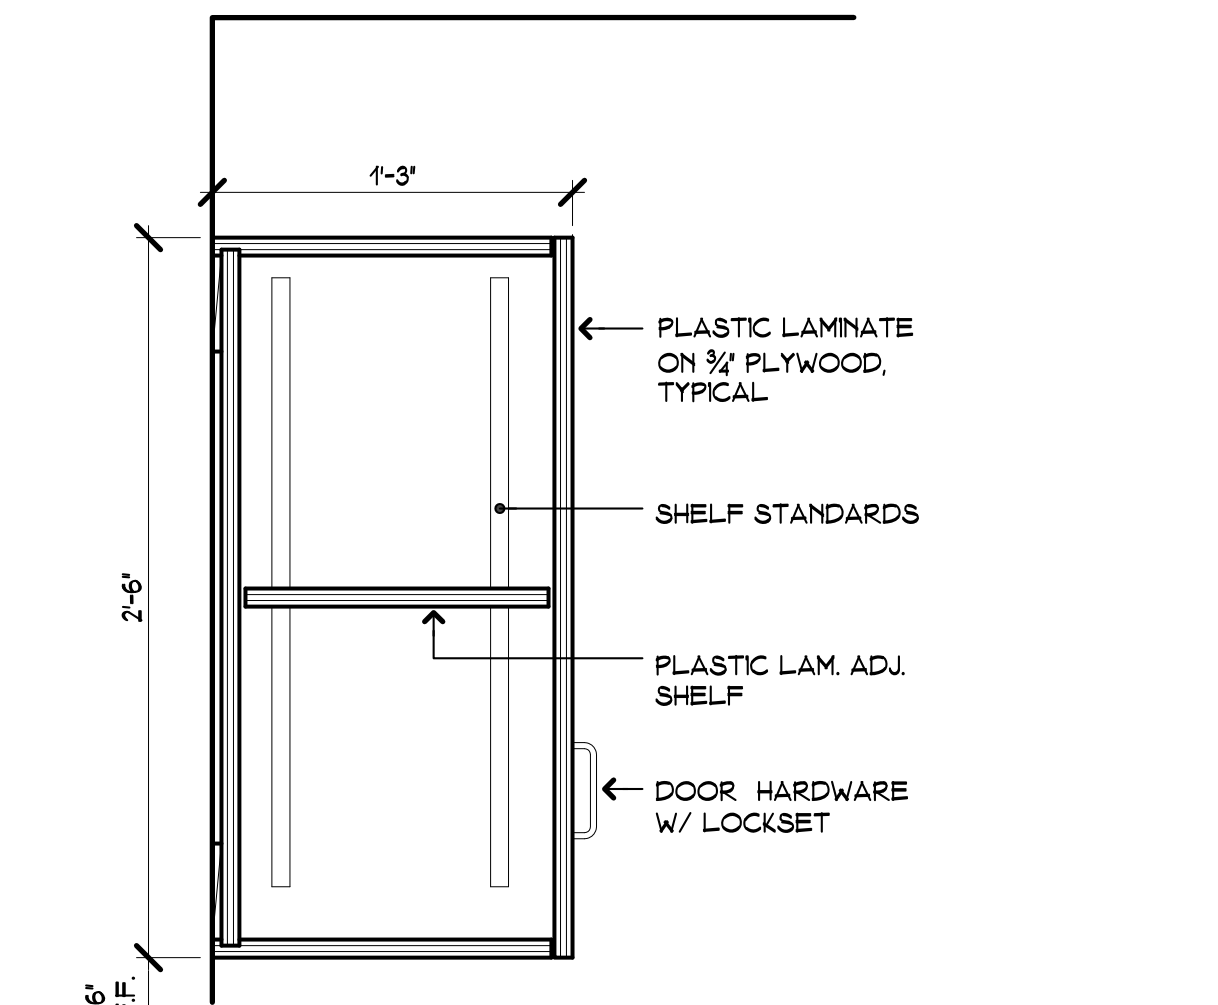

UPPER CABINET DETAIL

SCALE: 1 1/2" = 1'-0"

6
A102

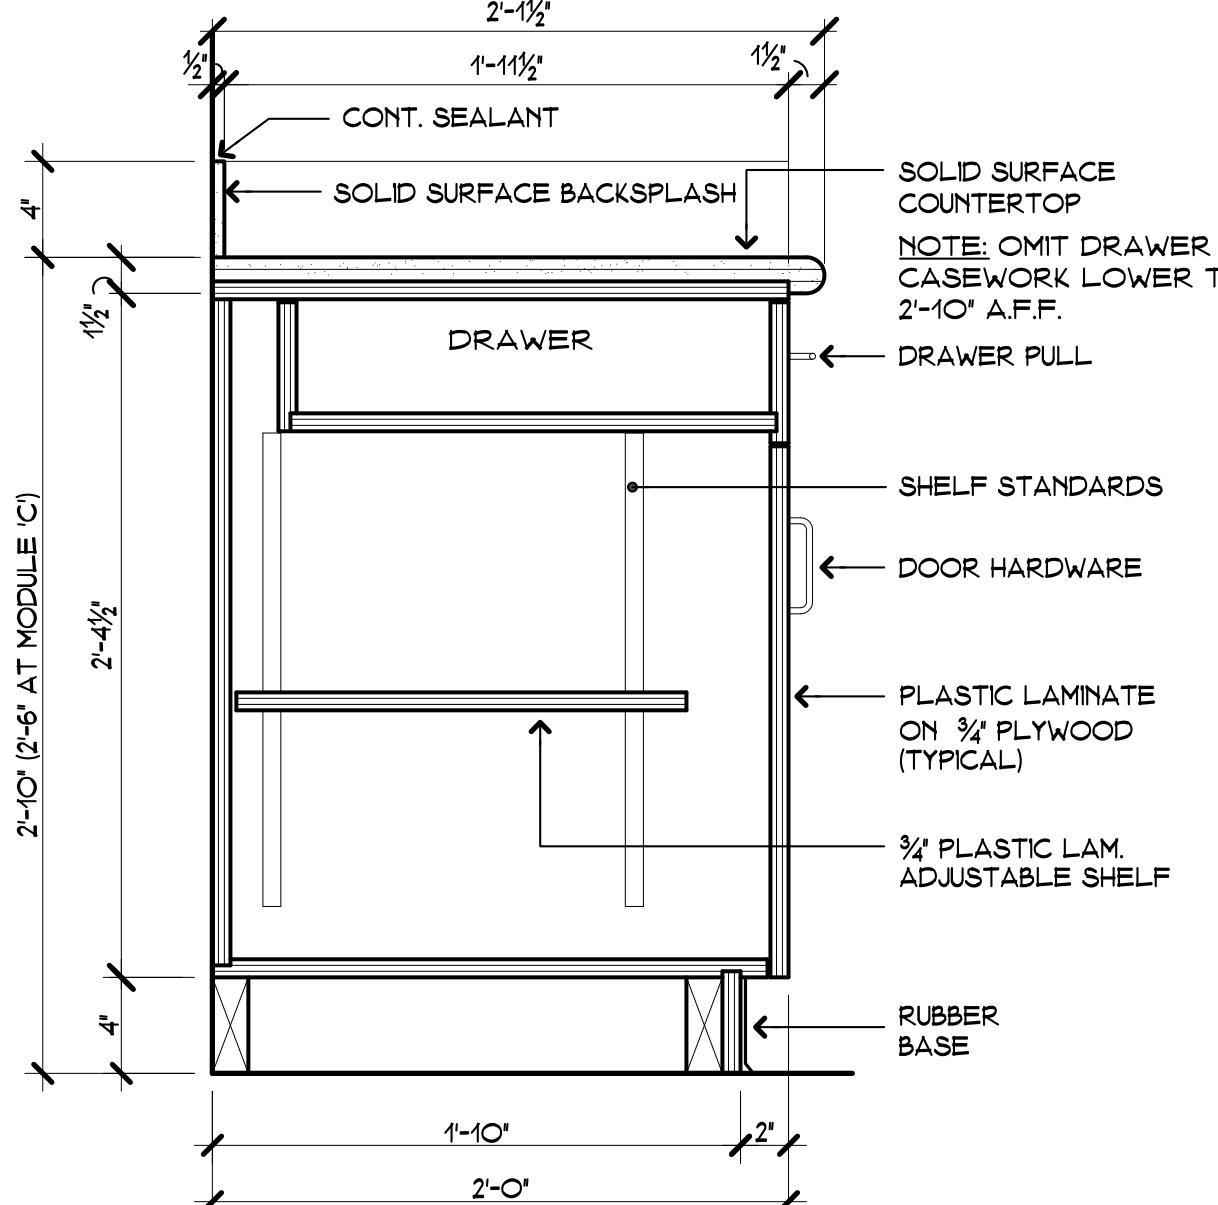

LOWER CABINET DETAIL

SCALE: 1 1/2" = 1'-0"

7
A102



GENERAL NOTES

- TEMPORARILY REMOVE & REINSTALL EXISTING BUILT-IN COMPONENTS (INCLUDING, BUT NOT LIMITED TO, SHELVING, STORAGE CABINETS, LOCKERS, WARDROBES, STORAGE CABINETS, ETC.) AS REQUIRED TO COMPLETELY REMOVE EXISTING FLOORING AND TO PROVIDE SCHEDULED FLOORING. PROTECT ANY REMOVED ITEM/ASSEMBLY AND REPAIR DAMAGE CAUSED DURING CONSTRUCTION. CONTRACTOR TO FIELD VERIFY EXISTING CONDITIONS AT EACH AREA OF WORK, AS CONDITIONS MAY VARY BY ROOM/LOCATION.
- DIMENSIONS & LAYOUTS SHOWN ON THE DRAWINGS ARE APPROXIMATE BASED ON EXISTING AS-BUILT DRAWINGS PROVIDED BY THE OWNER AND MAY NOT REFLECT ACTUAL FIELD CONDITIONS - CONTRACTOR IS RESPONSIBLE FOR FIELD VERIFYING ALL EXISTING CONDITIONS, INCLUDING FIELD-VERIFIED DIMENSIONS, CONFIGURATIONS AND FINISHES. NOTIFY THE ARCHITECT IMMEDIATELY UPON DISCOVERY OF ANY DISCREPANCIES.
- CONTRACTOR IS REQUIRED TO VISIT THE SITE AND BECOME FULLY FAMILIAR WITH THE EXISTING CONDITIONS AND THE SCOPE OF WORK PRIOR TO SUBMITTING A BID.

DEMOLITION NOTES

- REMOVE EXISTING RESILIENT RUBBER FLOORING, WALL BASE & TRANSITION STRIPS AT CLASSROOM, INCLUDING STORAGE ALCOVE, SINK AREA & TOILET ROOM PASSAGE. PREP SUBSTRATE TO RECEIVE SCHEDULED FINISH. AT DOORWAY TO CORRIDOR, CUT AND REMOVE RUBBER FLOORING TO A POINT IN-LINE WITH CLASSROOM FACE OF DOOR. SEE TRANSITION STRIP DETAIL FOR MORE INFO.
- REMOVE EXISTING BROADLOOM CARPETING & ALL ASSOCIATED COMPONENTS.
- REMOVE EXISTING VCT FLOORING & WALL BASE AND PREP EXISTING SUBSTRATE TO RECEIVE SCHEDULED FINISH.
- REMOVE EXISTING FLOOR-MOUNTED CASEWORK ISLAND ASSEMBLY INCLUDING BASE CABINETS, COUNTERTOPS, FULL HEIGHT STORAGE CABINETS AND ALL ASSOCIATED SHELVING, FIXTURES AND FINISHES. PATCH/REPAIR EXISTING SUBSTRATE AS REQ'D TO PROVIDE SCHEDULED FLOORING.
- REMOVE EXISTING RESILIENT RUBBER FLOORING, WALL BASE & TRANSITION STRIPS AT CAFETERIA. AT DOORWAYS TO CORRIDORS & ADJACENT SPACES, CUT AND REMOVE RUBBER FLOORING TO A POINT IN-LINE WITH CAFETERIA FACE OF DOOR. SEE TRANSITION STRIP DETAIL FOR MORE INFO.
- EXISTING FLOOR MOUNTED RADIATOR TO REMAIN (CONTRACTOR TO VERIFY SIZE, LOCATION AND CONFIGURATION IN FIELD). REMOVE, CLEAN & REINSTALL EXISTING COVERS AS REQ'D TO PROVIDE SCHEDULED FINISHES.
- EXISTING DOOR ASSEMBLY & THRESHOLD TO REMAIN - REMOVE & REINSTALL EXISTING THRESHOLD AS REQ'D TO PROVIDE SCHEDULED FINISHES.
- ALTERNATE #2: REMOVE EXISTING BROADLOOM CARPETING & WALL BASE AT MEDIA CENTER & ADJACENT ROOMS. TEMPORARILY REMOVE & RELOCATE EXISTING SHELVING AS REQ'D TO PROVIDE SCHEDULED FINISHES.

CASEWORK ISLAND REMOVAL NOTES:


- CASEWORK ISLAND ASSEMBLY CONFIGURATION VARIES - VERIFY ACTUAL CONFIGURATION AT EACH CLASSROOM IN FIELD.
- REFER TO ELECTRICAL NOTES FOR INFORMATION REGARDING REMOVAL, RELOCATION, AND REPLACEMENT OF EXISTING CASEWORK MOUNTED POWER, LIGHTING & TELE/DATA COMPONENTS. VERIFY LOCATION & CONFIGURATION OF EXISTING ELECTRICAL SCOPE ITEMS IN FIELD.

CONSTRUCTION NOTES

- REPAIR & PREP EXISTING CONCRETE SUBSTRATE AT AREAS OF FLOORING REMOVAL AS REQUIRED TO RECEIVE SCHEDULED RESILIENT FLOORING FINISH. PROVIDE SCHEDULED FINISHES - REFER TO FINISH SCHEDULE FOR MORE INFORMATION.
- REPAIR & PREP EXISTING WALL SUBSTRATE AS REQUIRED TO RECEIVE SCHEDULED WALL BASE - REFER TO FINISH SCHEDULE.
- SEE GENERAL NOTE #1

ELECTRICAL NOTES

- (E1) CONTRACTOR SHALL DISCONNECT, REMOVE & RELOCATE THE FOLLOWING LOW VOLTAGE ITEMS (BATTERY POWERED CLOCK, WALL MOUNTED PHONES, (2) NETWORK OUTLETS AND (1) COAX CABLE TV OUTLET). CONTRACTOR SHALL DISCONNECT, REMOVE AND NOT REINSTALL THE FOLLOWING ITEMS (RECESSED SPEAKER & HOUSING, UNDER-CABINET LIGHT FIXTURE AND DUPLEX RECEPTACLES). BRANCH CIRCUIT(S) SERVICE RECEPTACLES AND LIGHT FIXTURE SHALL BE PULLED BACK TO THE NEAREST ACCESSIBLE JUNCTION BOX AND BE MADE SAFE. ALL LOW VOLTAGE CABLING SHALL BE TEMPORARILY COILED ABOVE THE CEILING TO BE RELOCATED WITH DEVICES LISTED ABOVE.
- (E2) CONTRACTOR SHALL INSTALL A NEW SURFACE MOUNTED SPEAKER AND RELOCATED BATTERY CLOCK ON THIS WALL CLOSE TO THE CORNER 7'-0" A.F.F. TO THE CENTER OF EACH DEVICE. EXTEND EXISTING SPEAKER CABLE TO THE NEW SPEAKER. INSTALL NEW SURFACE MOUNTED RACEWAY (WIREMOLD) FROM CEILING DOWN TO SPEAKER. CONTRACTOR SHALL INSTALL RELOCATED WALL MOUNTED PHONE AT 4'-0" A.F.F. (TO CENTER OF PHONE) BELOW CLOCK & SPEAKER. EXTEND EXISTING PHONE CABLE TO NEW PHONE LOCATION. INSTALL NEW SURFACE MOUNTED RACEWAY (WIREMOLD) FROM CEILING DOWN TO PHONE.
- (E3) CONTRACTOR SHALL INSTALL (2) RELOCATED NETWORK OUTLETS AND (1) RELOCATED CABLE TV OUTLET SURFACE MOUNTED, AS DIRECTED BY OWNER FOR TEACHER'S DESK. EXTEND EXISTING NETWORK CABLE & COAX CABLE (TV) TO NEW LOCATIONS. INSTALL NEW SURFACE MOUNTED RACEWAY (WIREMOLD) FROM CEILING DOWN TO DEVICES.

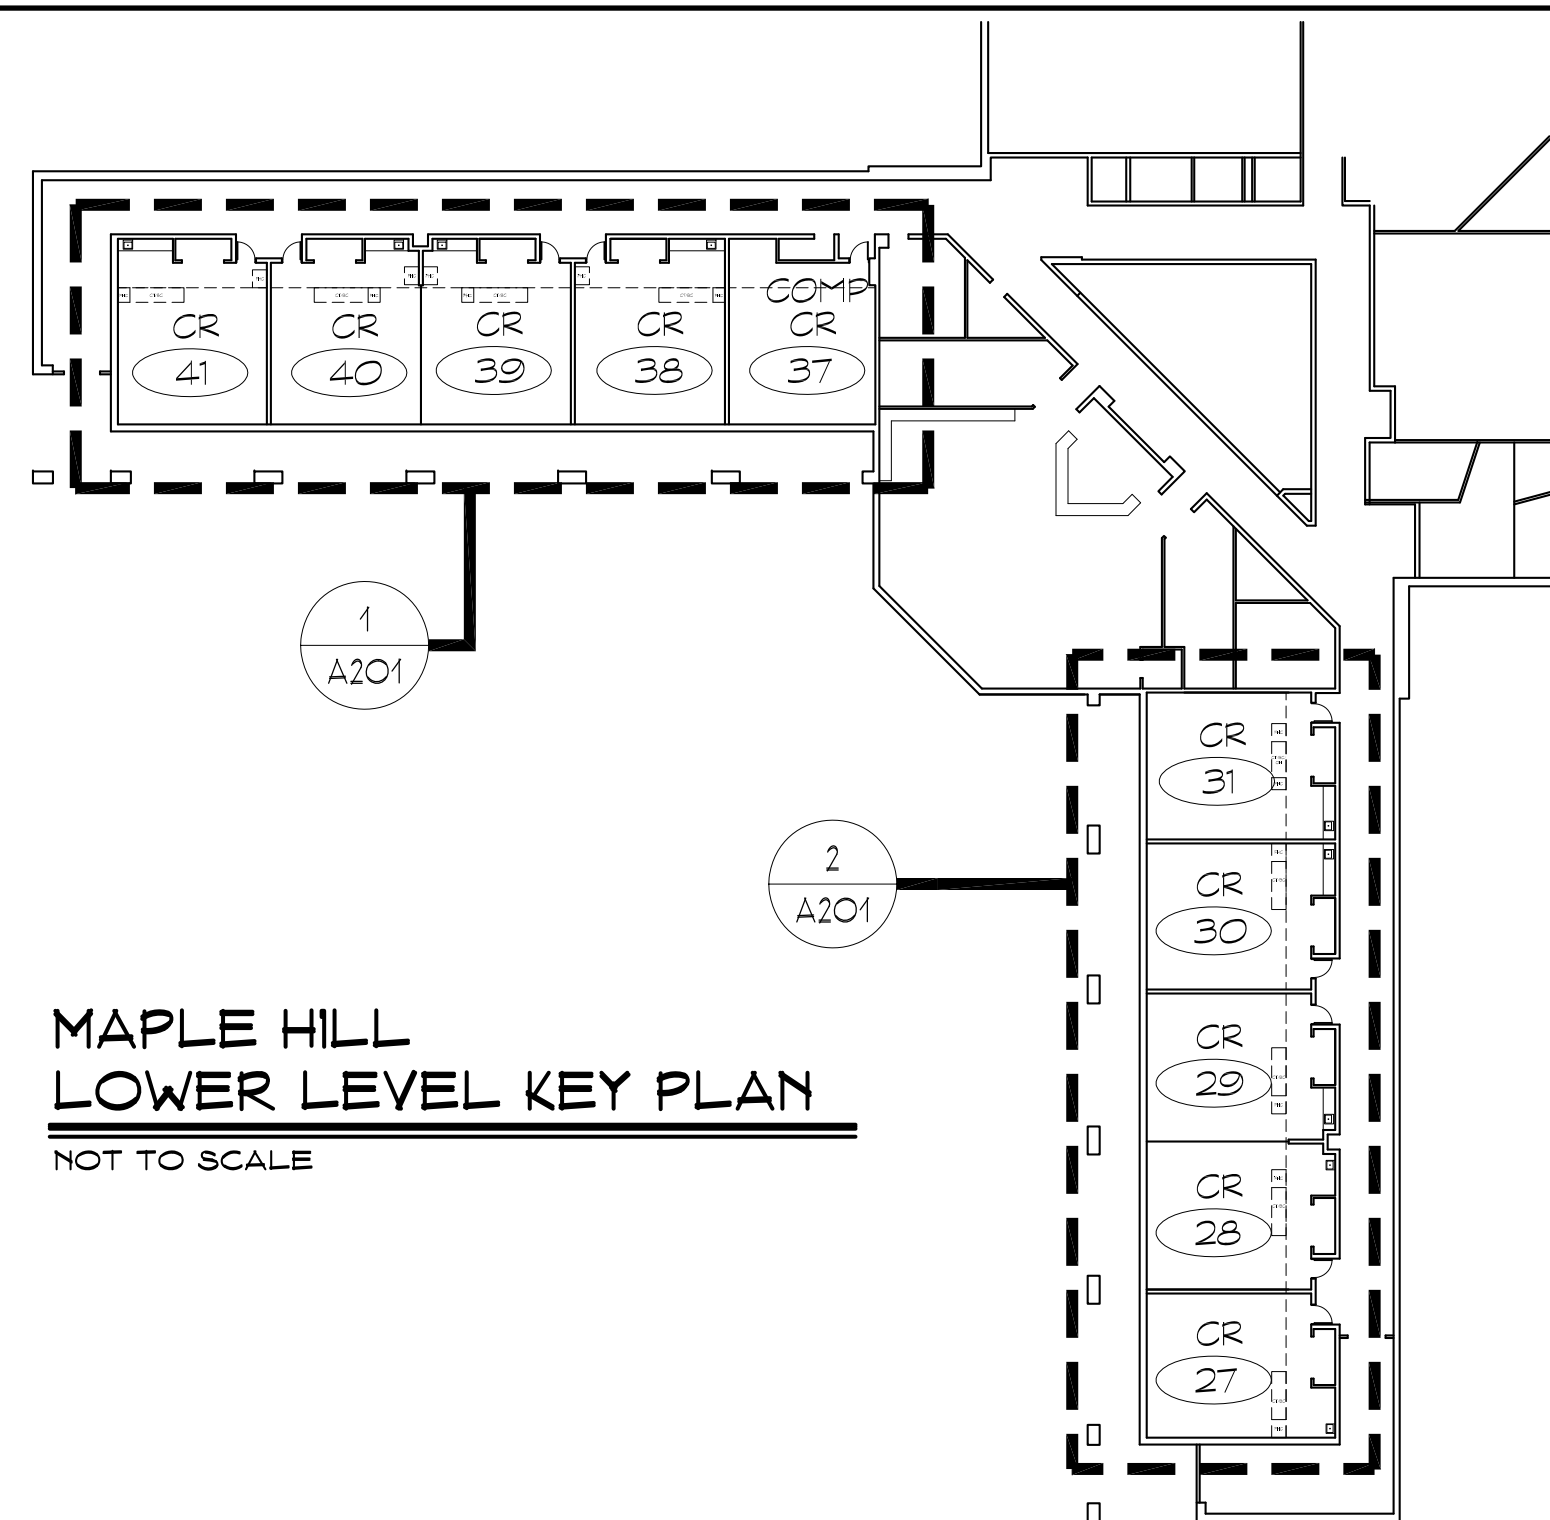

GENERAL FINISH NOTES

- CONTRACTOR SHALL FIELD VERIFY ALL CONDITIONS & DIMENSIONS AND NOTIFY ARCHITECT IMMEDIATELY OF ANY DISCREPANCIES.



FINISH SCHEDULE NOTES


- PATCH/REPAIR, PREP & PAINT ANY EXISTING FINISHED SURFACE DAMAGED DURING CONSTRUCTION ACTIVITIES - MATCH EXISTING FINISHES (V.I.F.).
- AT AREAS OF CEILING-FED TELE/DATA DROP REMOVAL, REMOVE EXISTING DAMAGED, CUT OR ALTERED CEILING TILE AND/OR SUSPENDED CEILING GRID AND PROVIDE NEW FULL-TILE AND SPICED PORTION OF CEILING GRID TO MATCH EXISTING (V.I.F.). COORDINATE AVAILABILITY OF AVAILABLE EXISTING 2x4 ACOUSTIC CEILING TILE ATTIC STOCK WITH OWNER.

EXISTING COND. ABBREVIATIONS:	FINISH SCHEDULE LEGEND:
RHC - FULL HEIGHT CASEWORK	ACT - ACOUSTICAL CEILING TILE
CT - COUNTERTOP W/VT	PT - PAINTED GYP BOARD
CB - BASE CABINET W/VT	RB - RUBBER BASE
OW - OVERHEAD CONNECTOR	ETR - EXISTING TO REMAIN
VCT - VINYL COMPOSITION TILE	CT - CERAMIC WALL TILE
RRT - RUBBER RUBBER TILE	CPT - CERAMIC FLOOR TILE
CPT - CERAMIC FLOOR TILE	CWB - CERAMIC WALL BASE
VCT - VINYL COMPOSITION TILE	VCT - VINYL COMPOSITION TILE
OW - OVERHEAD CONNECTOR	OW - OVERHEAD CONNECTOR
CML - CONCRETE MASONRY UNIT	



ROOM FINISH SCHEDULE

ROOM	FLOOR	BASE	NORTH	SOUTH	EAST	WEST	MAT'L	FINISH	NOTES
05 CLASSROOM	VCT	RB	ETR	ETR	ETR	ETR	ETR	ETR	NOTES 1, 2
06 CLASSROOM	VCT	RB	ETR	ETR	ETR	ETR	ETR	ETR	NOTES 1, 2
07 CLASSROOM	VCT	RB	ETR	ETR	ETR	ETR	ETR	ETR	NOTES 1, 2
08 CLASSROOM	VCT	RB	ETR	ETR	ETR	ETR	ETR	ETR	NOTES 1, 2
09 CLASSROOM	VCT	RB	ETR	ETR	ETR	ETR	ETR	ETR	NOTES 1, 2
10 MEDIA CENTER	VCT	RB	ETR	ETR	ETR	ETR	ETR	ETR	NOTES 1, 2 (ALTERNATE #2)
15 CAFETERIA	VCT	RB	ETR	ETR	ETR	ETR	ETR	ETR	NOTES 1, 2
16 CLASSROOM	VCT	RB	ETR	ETR	ETR	ETR	ETR	ETR	NOTES 1, 2
19 CLASSROOM	VCT	RB	ETR	ETR	ETR	ETR	ETR	ETR	NOTES 1, 2
20 CLASSROOM	VCT	RB	ETR	ETR	ETR	ETR	ETR	ETR	NOTES 1, 2
21 CLASSROOM	VCT	RB	ETR	ETR	ETR	ETR	ETR	ETR	NOTES 1, 2
22 CLASSROOM	VCT	RB	ETR	ETR	ETR	ETR	ETR	ETR	NOTES 1, 2
23 CLASSROOM	VCT	RB	ETR	ETR	ETR	ETR	ETR	ETR	NOTES 1, 2
24 CLASSROOM	VCT	RB	ETR	ETR	ETR	ETR	ETR	ETR	NOTES 1, 2
25 CLASSROOM	VCT	RB	ETR	ETR	ETR	ETR	ETR	ETR	NOTES 1, 2
26 CLASSROOM	VCT	RB	ETR	ETR	ETR	ETR	ETR	ETR	NOTES 1, 2
27 CLASSROOM	VCT	RB	ETR	ETR	ETR	ETR	ETR	ETR	NOTES 1, 2
28 CLASSROOM	VCT	RB	ETR	ETR	ETR	ETR	ETR	ETR	NOTES 1, 2
29 CLASSROOM	VCT	RB	ETR	ETR	ETR	ETR	ETR	ETR	NOTES 1, 2
30 CLASSROOM	VCT	RB	ETR	ETR	ETR	ETR	ETR	ETR	NOTES 1, 2
31 CLASSROOM	VCT	RB	ETR	ETR	ETR	ETR	ETR	ETR	NOTES 1, 2
37 COMPUTER CLASSROOM	VCT	RB	ETR	ETR	ETR	ETR	ETR	ETR	NOTES 1, 2 (ALTERNATE #1)
38 CLASSROOM	VCT	RB	ETR	ETR	ETR	ETR	ETR	ETR	NOTES 1, 2
39 CLASSROOM	VCT	RB	ETR	ETR	ETR	ETR	ETR	ETR	NOTES 1, 2
40 CLASSROOM	VCT	RB	ETR	ETR	ETR	ETR	ETR	ETR	NOTES 1, 2
41 CLASSROOM	VCT	RB	ETR	ETR	ETR	ETR	ETR	ETR	NOTES 1, 2



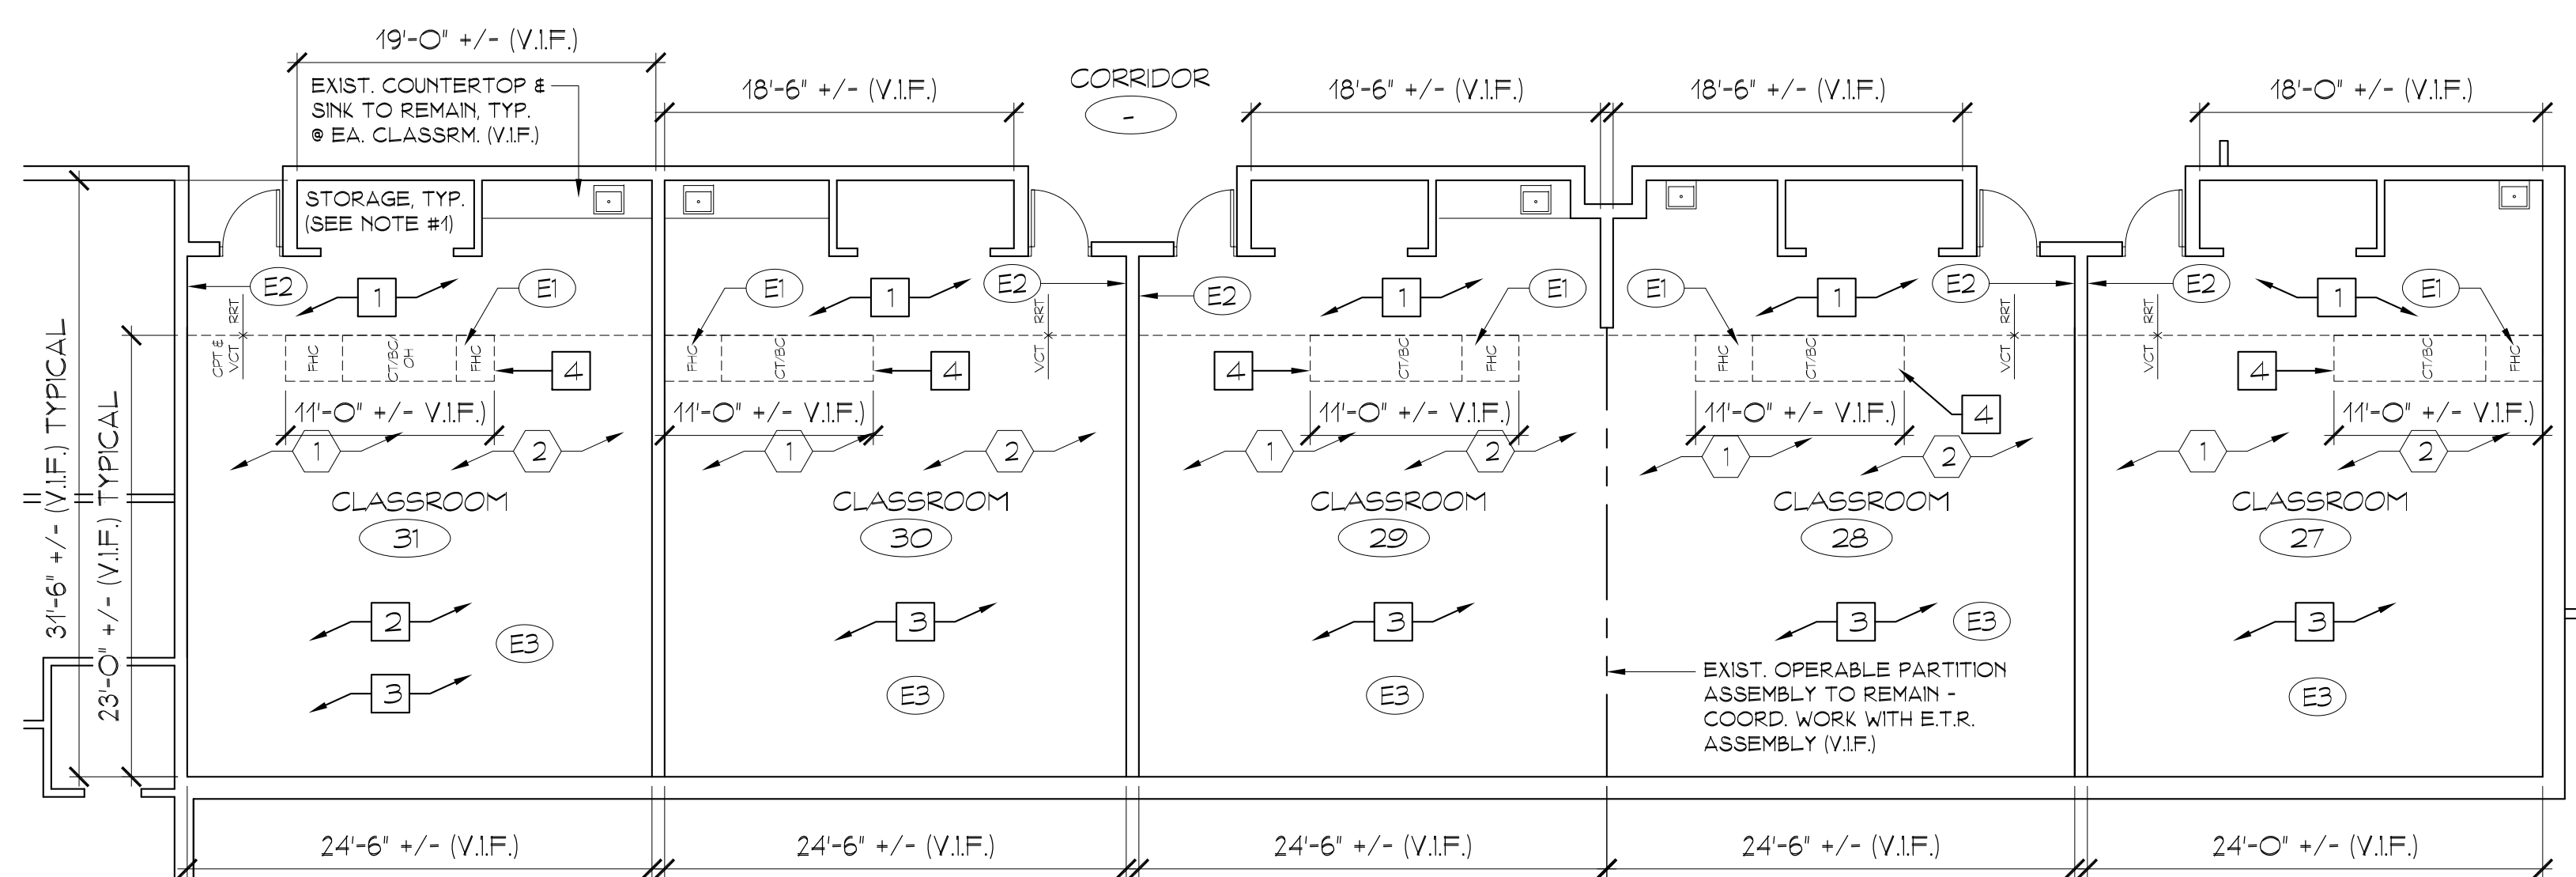
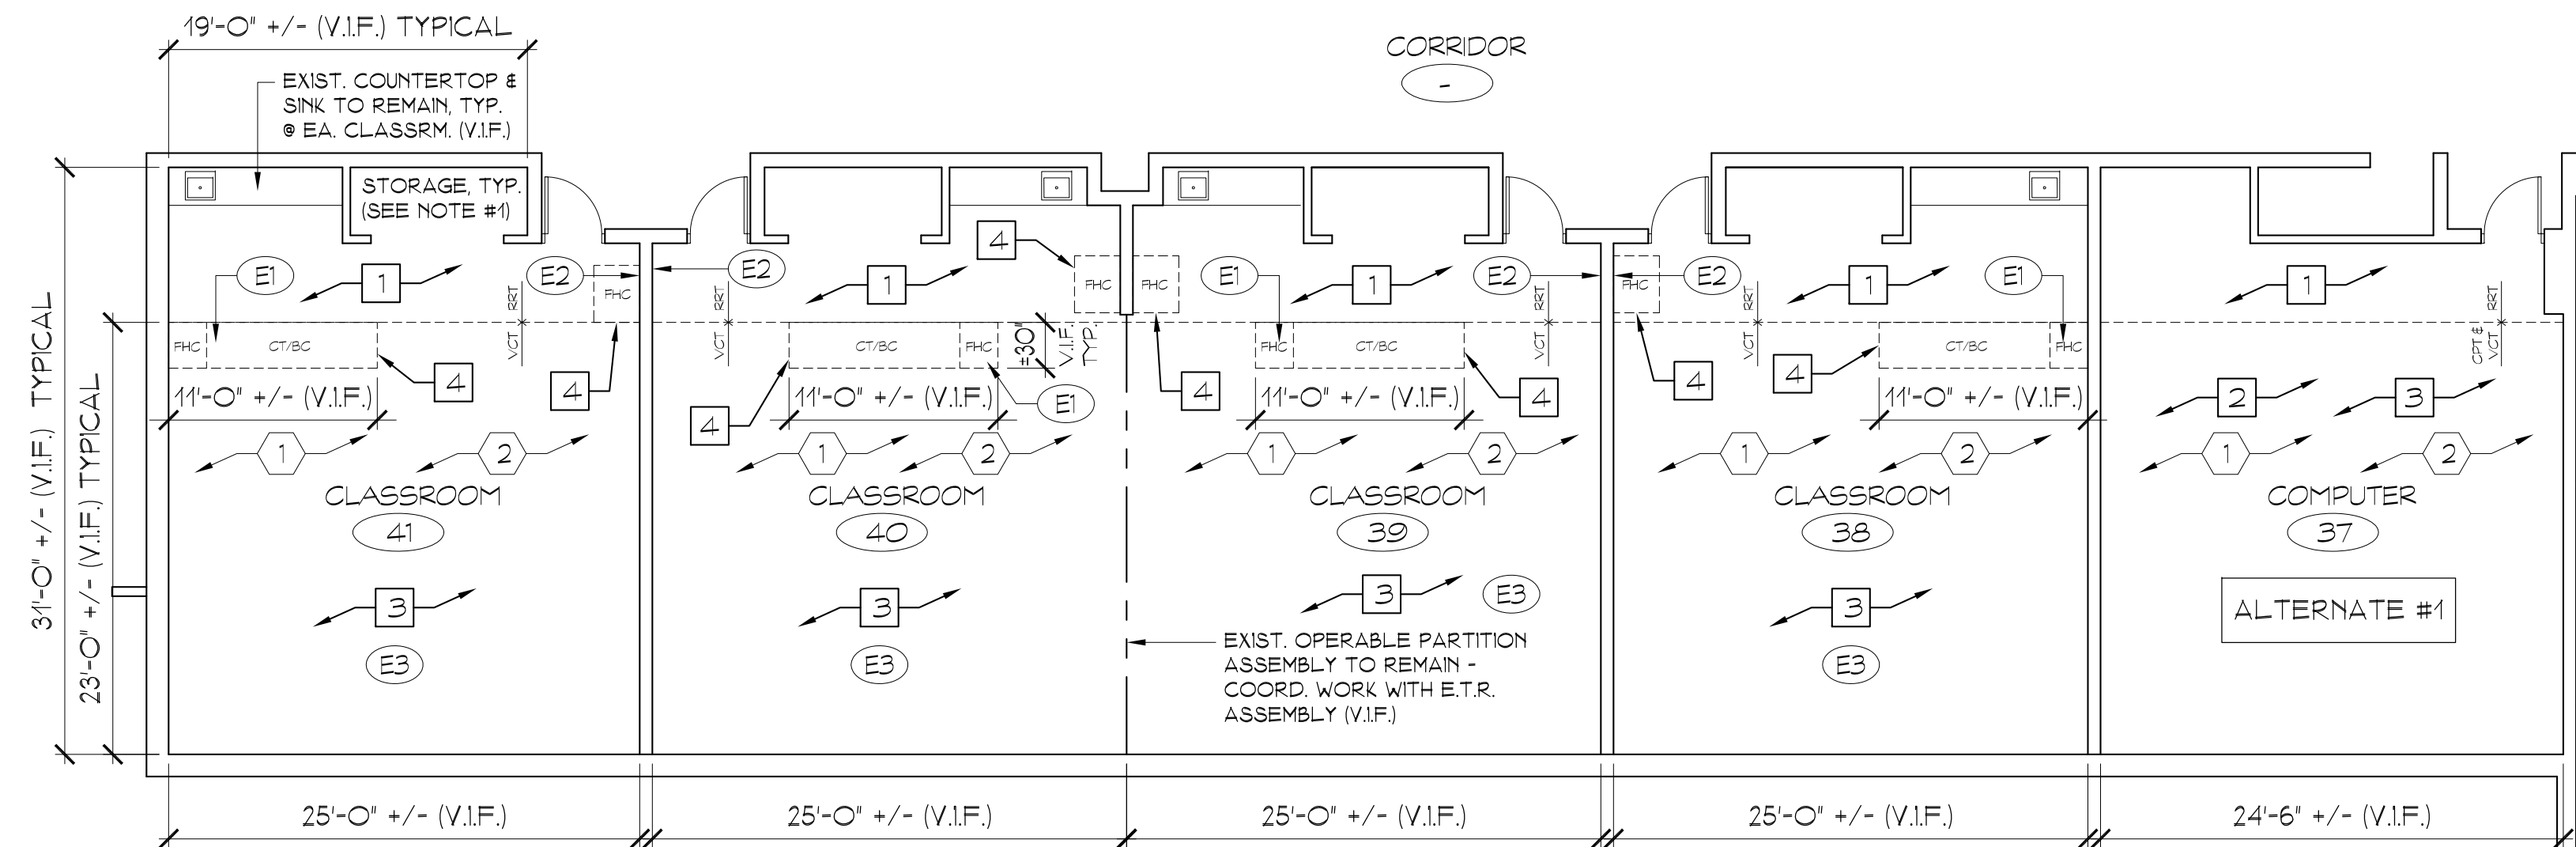


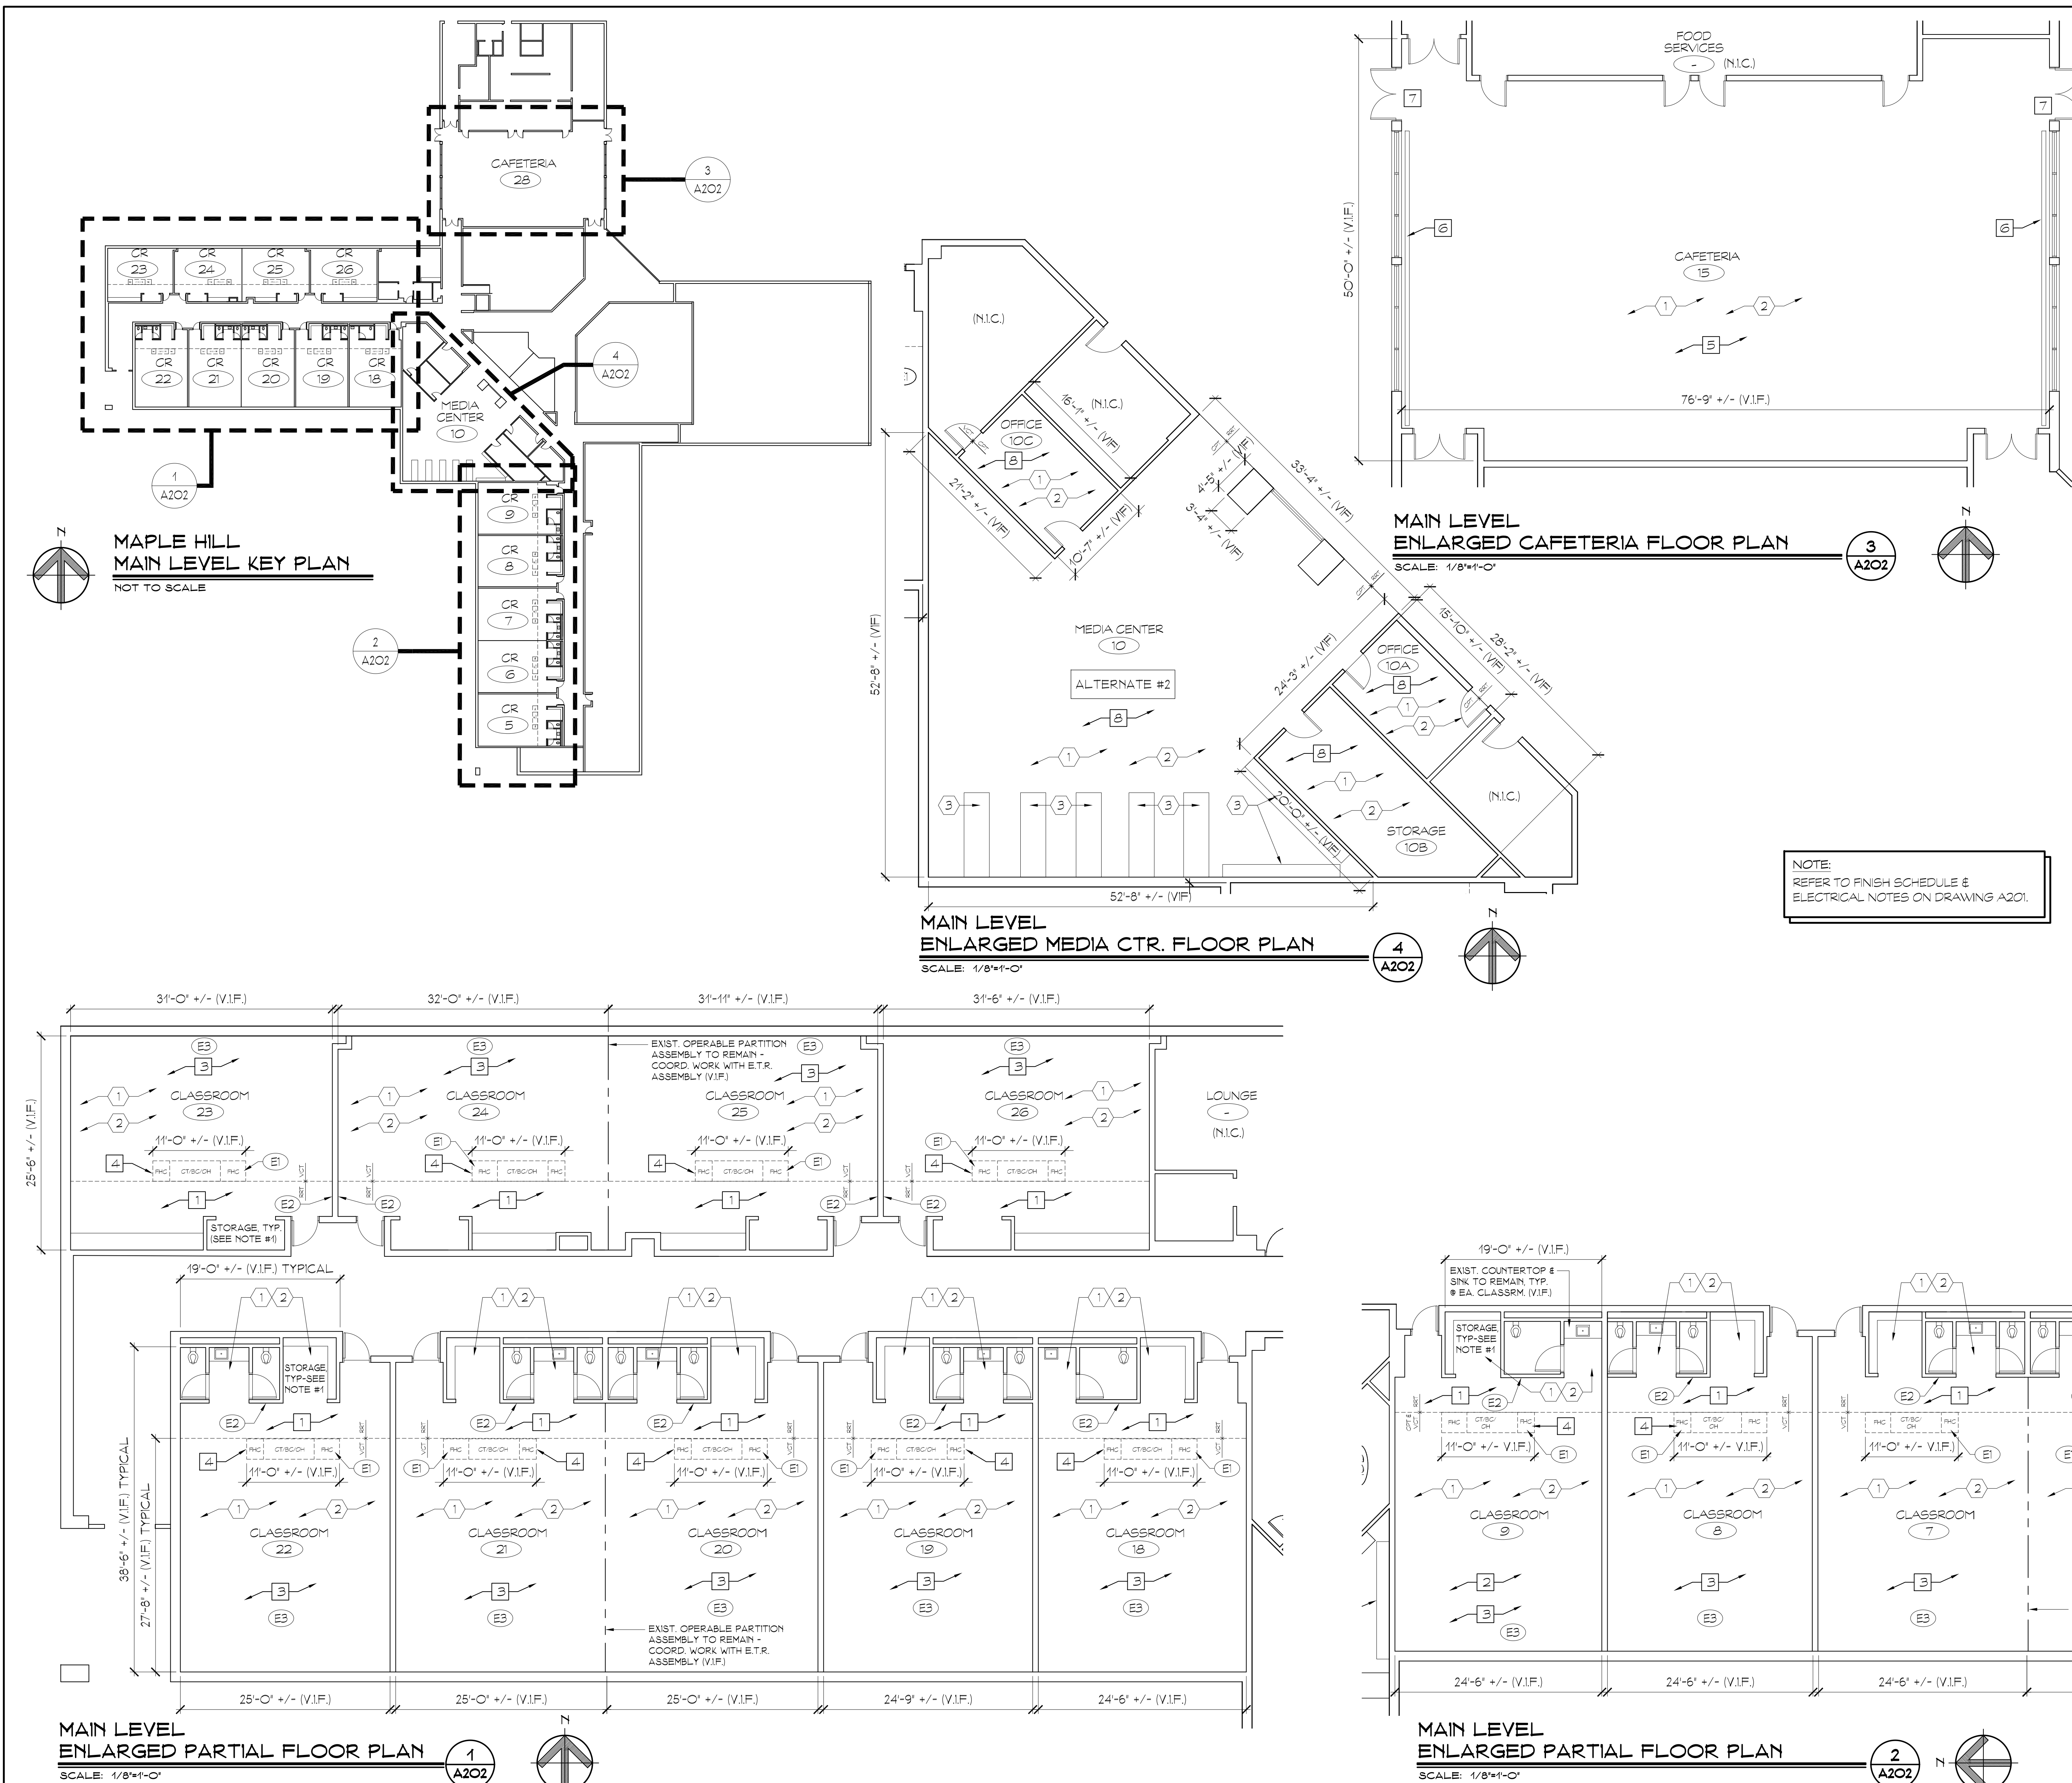


- ### GENERAL NOTES
- TEMPORARILY REMOVE & REINSTALL EXISTING BUILT-IN COMPONENTS (INCLUDING, BUT NOT LIMITED TO, SHELVING, STORAGE CABINETS, LOCKERS, WARDROBES, STORAGE CABINETS, ETC.) AS REQUIRED TO COMPLETELY REMOVE EXISTING FLOORING AND TO PROVIDE SCHEDULED FLOORING. PROTECT ANY REMOVED ITEM/ASSEMBLY AND REPAIR DAMAGE CAUSED DURING CONSTRUCTION. CONTRACTOR TO FIELD VERIFY EXISTING CONDITIONS AT EACH AREA OF WORK, AS CONDITIONS MAY VARY BY ROOM/LOCATION.
 - DIMENSIONS & LAYOUTS SHOWN ON THE DRAWINGS ARE APPROXIMATE BASED ON EXISTING AS-BUILT DRAWINGS PROVIDED BY THE OWNER AND MAY NOT REFLECT ACTUAL FIELD CONDITIONS - CONTRACTOR IS RESPONSIBLE FOR FIELD VERIFYING ALL EXISTING CONDITIONS, INCLUDING FIELD-VERIFIED DIMENSIONS, CONFIGURATIONS AND FINISHES. NOTIFY THE ARCHITECT IMMEDIATELY UPON DISCOVERY OF ANY DISCREPANCIES.
 - CONTRACTOR IS REQUIRED TO VISIT THE SITE AND BECOME FULLY FAMILIAR WITH THE EXISTING CONDITIONS AND THE SCOPE OF WORK PRIOR TO SUBMITTING A BID.
- ### DEMOLITION NOTES
- REMOVE EXISTING RESILIENT RUBBER FLOORING, WALL BASE & TRANSITION STRIPS AT CLASSROOM, INCLUDING STORAGE ALCOVE, SINK AREA & TOILET ROOM PASSAGE. PREP SUBSTRATE TO RECEIVE SCHEDULED FINISH. AT DOORWAY TO CORRIDOR, CUT AND REMOVE RUBBER FLOORING TO A POINT IN-LINE WITH CLASSROOM FACE OF DOOR. SEE TRANSITION STRIP DETAIL FOR MORE INFO.
 - REMOVE EXISTING BROADLOOM CARPETING & ALL ASSOCIATED COMPONENTS.
 - REMOVE EXISTING VCT FLOORING & WALL BASE AND PREP EXISTING SUBSTRATE TO RECEIVE SCHEDULED FINISH.
 - REMOVE EXISTING FLOOR-MOUNTED CASEWORK ISLAND ASSEMBLY INCLUDING BASE CABINETS, COUNTERTOPS, FULL HEIGHT STORAGE CABINETS AND ALL ASSOCIATED SHELVING, FIXTURES AND FINISHES. PATCH/REPAIR EXISTING SUBSTRATE AS REQ'D TO PROVIDE SCHEDULED FLOORING.
 - REMOVE EXISTING RESILIENT RUBBER FLOORING, WALL BASE & TRANSITION STRIPS AT CAFETERIA. AT DOORWAYS TO CORRIDORS & ADJACENT SPACES, CUT AND REMOVE RUBBER FLOORING TO A POINT IN-LINE WITH CAFETERIA FACE OF DOOR. SEE TRANSITION STRIP DETAIL FOR MORE INFO.
 - EXISTING FLOOR MOUNTED RADIATOR TO REMAIN (CONTRACTOR TO VERIFY SIZE, LOCATION AND CONFIGURATION IN FIELD). REMOVE, CLEAN & REINSTALL EXISTING COVERS AS REQ'D TO PROVIDE SCHEDULED FINISHES.
 - EXISTING DOOR ASSEMBLY & THRESHOLD TO REMAIN - REMOVE & REINSTALL EXISTING THRESHOLD AS REQ'D TO PROVIDE SCHEDULED FINISHES.
 - ALTERNATE #2: REMOVE EXISTING BROADLOOM CARPETING & WALL BASE AT MEDIA CENTER & ADJACENT ROOMS. TEMPORARILY REMOVE & RELOCATE EXISTING SHELVING AS REQ'D TO PROVIDE SCHEDULED FINISHES.
- ### CASEWORK ISLAND REMOVAL NOTES:
- CASEWORK ISLAND ASSEMBLY CONFIGURATION VARIES - VERIFY ACTUAL CONFIGURATION AT EACH CLASSROOM IN FIELD.
 - REFER TO ELECTRICAL NOTES FOR INFORMATION REGARDING REMOVAL, RELOCATION, AND REPLACEMENT OF EXISTING CASEWORK MOUNTED POWER, LIGHTING & TELE/DATA COMPONENTS. VERIFY LOCATION & CONFIGURATION OF EXISTING ELECTRICAL SCOPE ITEMS IN FIELD.
- ### CONSTRUCTION NOTES
- REPAIR & PREP EXISTING CONCRETE SUBSTRATE AT AREAS OF FLOORING REMOVAL AS REQUIRED TO RECEIVE SCHEDULED RESILIENT FLOORING FINISH. PROVIDE SCHEDULED FINISHES - REFER TO FINISH SCHEDULE FOR MORE INFORMATION.
 - REPAIR & PREP EXISTING WALL SUBSTRATE AS REQUIRED TO RECEIVE SCHEDULED WALL BASE - REFER TO FINISH SCHEDULE.
 - SEE GENERAL NOTE #1

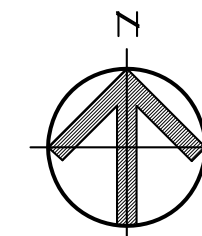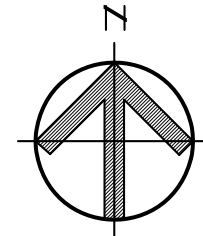



AC.T.	- ACOUSTICAL CEILING TILE
PT.	- PAINTED GYP. BOARD
RB.	- RUBBER BASE
ETR.	- EXISTING TO REMAIN
C.T.	- CERAMIC WALL TILE
C.F.T.	- CERAMIC FLOOR TILE
C.W.B.	- CERAMIC WALL BASE
V.C.T.	- VINYL COMPOSITION TILE
G.W.B.	- GYPSUM WALLBOARD
C.M.U.	- CONCRETE MASONRY UNIT

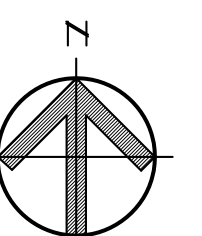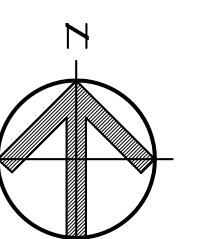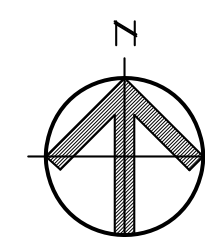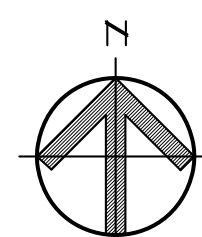

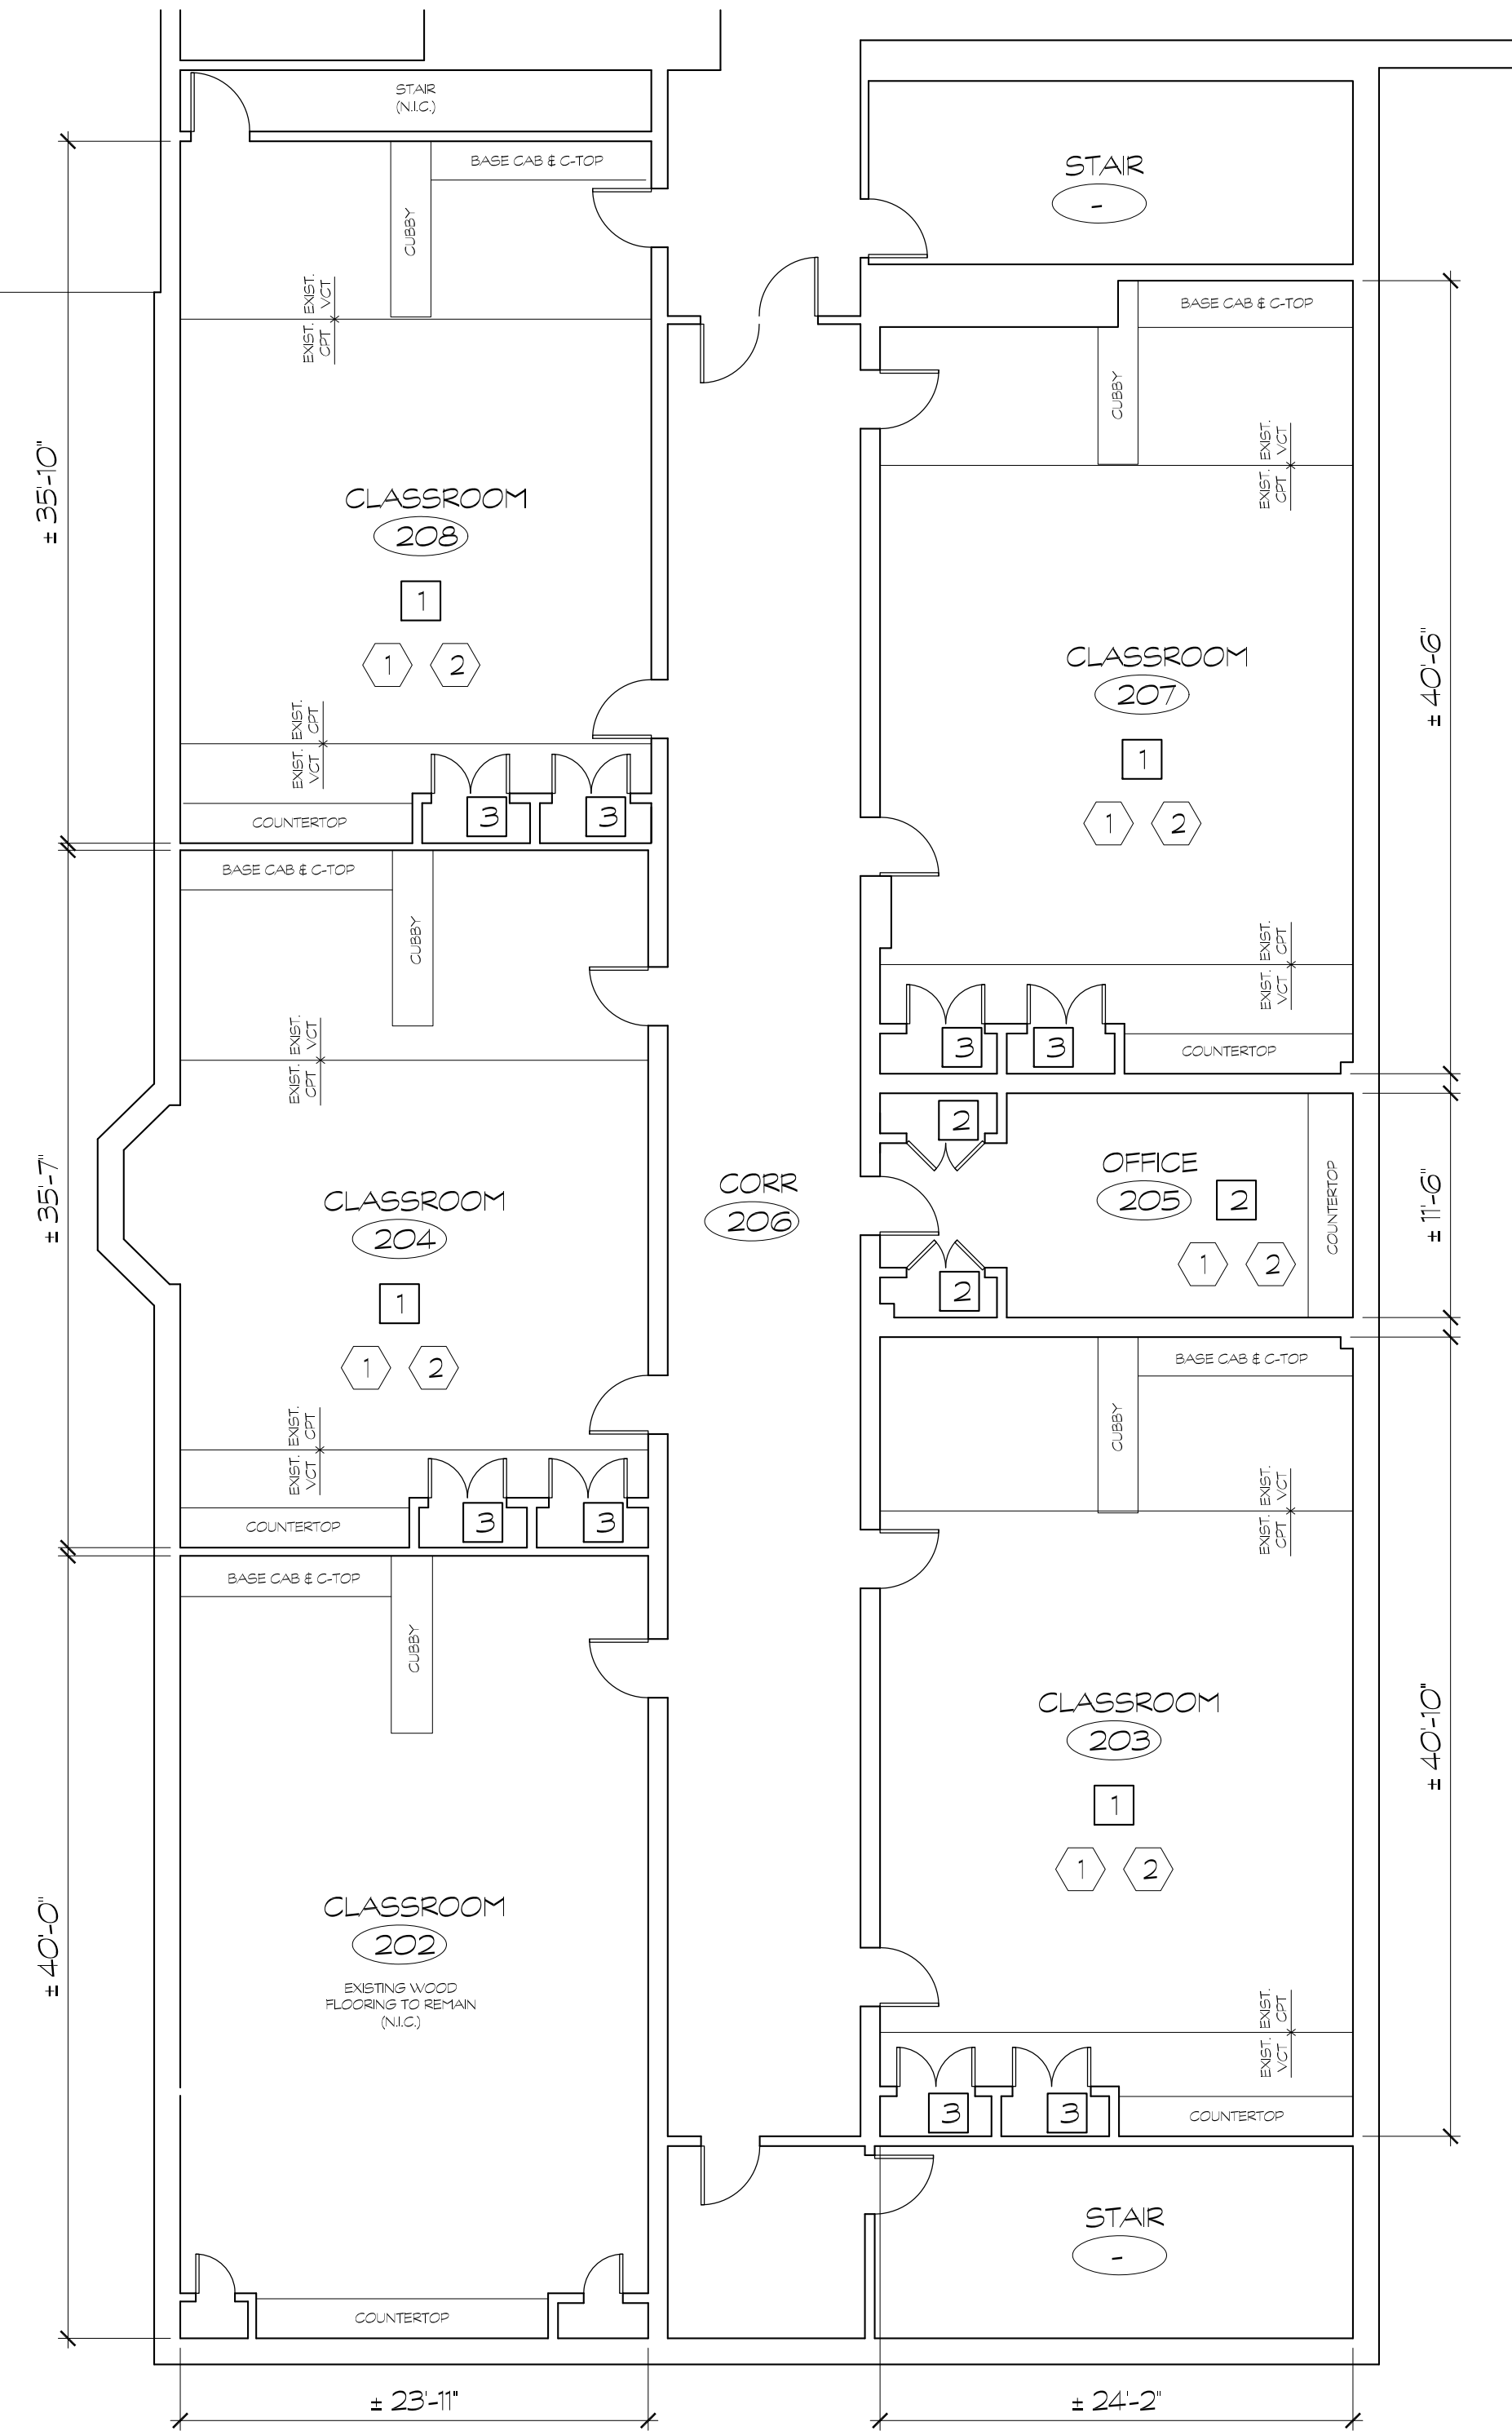


ENLARGED PARTIAL SECOND FLOOR PLAN

SCALE: 1/8"=1'-0"

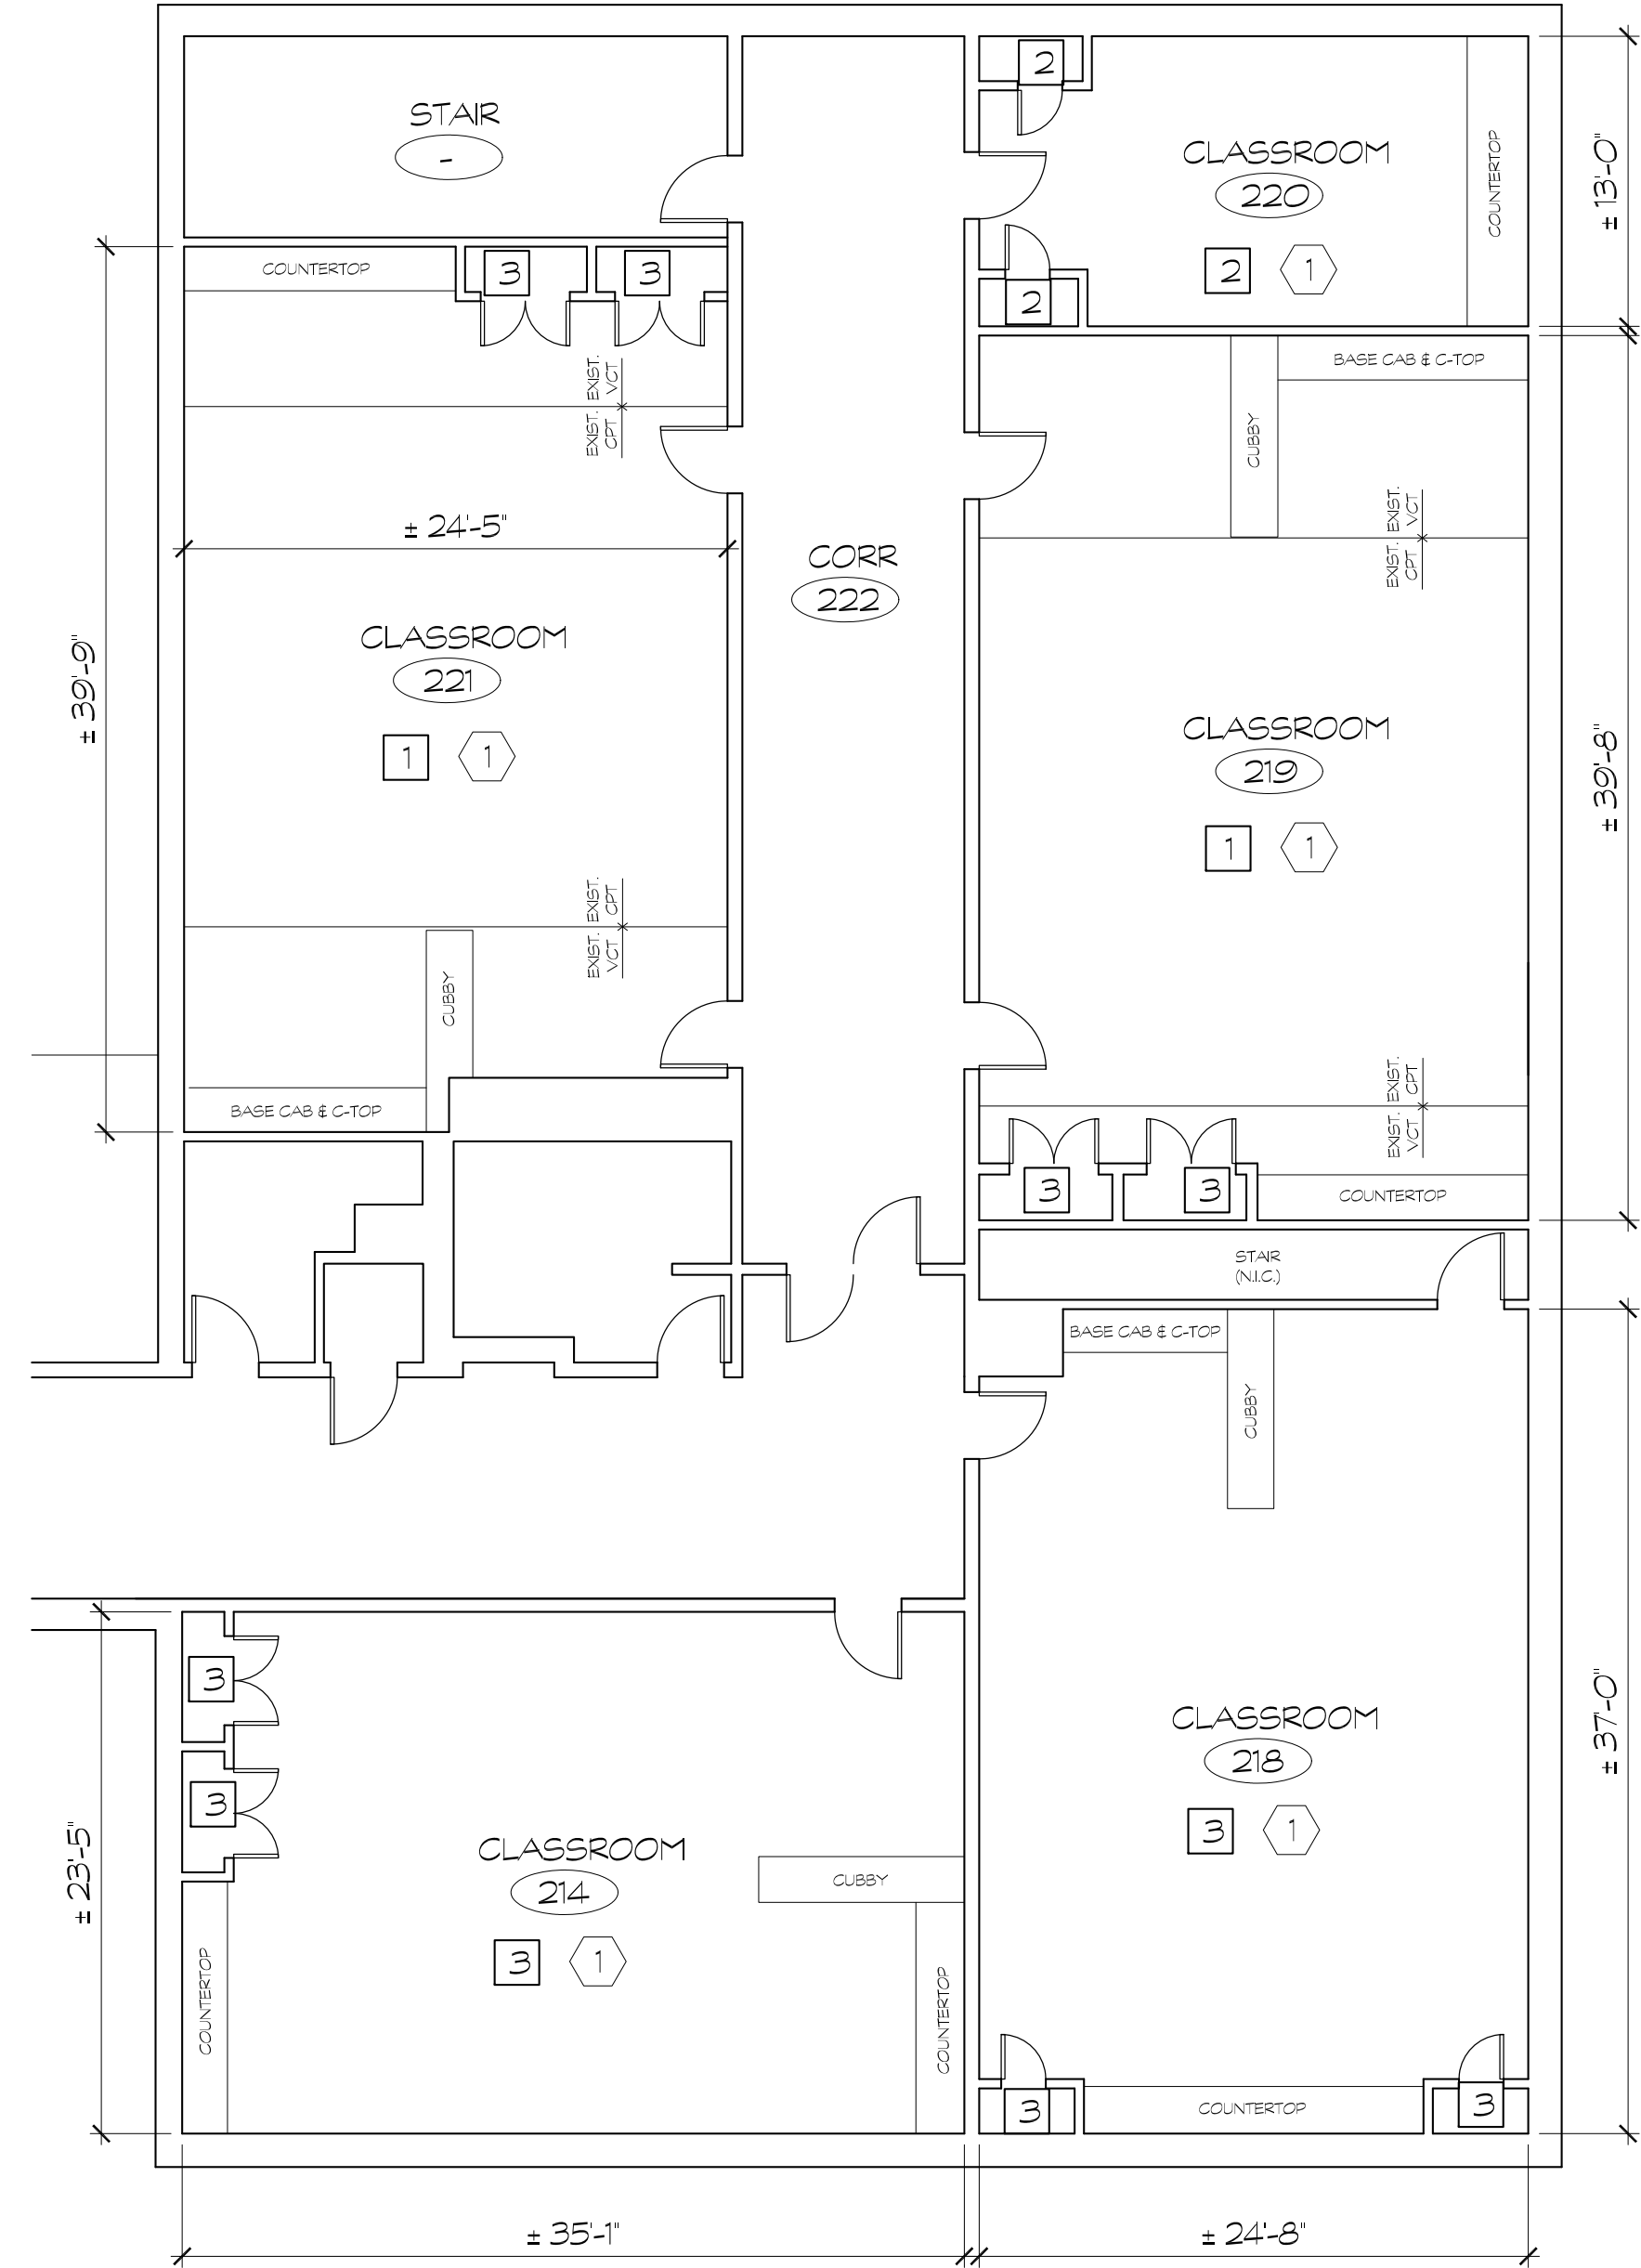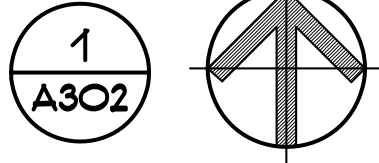

ENLARGED PARTIAL SECOND FLOOR PLAN

SCALE: 1/8"=1'-0"

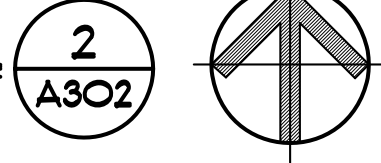

ROOM FINISH SCHEDULE												
ROOM		FLOOR			WALL FINISH				CEILING		NOTES	
NO.	ROOM NAME	SUBSTRATE (EX. - V.I.F.)	FLR. FIN.	BASE	NORTH	SOUTH	EAST	WEST	MAT'L.	FINISH		
LOWER LEVEL	019 CLASSROOM	CONC.	VCT	RB	ETR.	ETR.	ETR.	ETR.	ETR.	ETR.	NOTE 1	
	019A CR STORAGE	CONC.	VCT	RB	ETR.	ETR.	ETR.	ETR.	ETR.	ETR.	NOTE 1	
	019B CR TOILET	CONC.	VCT	RB	ETR.	ETR.	ETR.	ETR.	ETR.	ETR.	NOTE 1	
	021 STORAGE	CONC.	ETR	ETR	ETR.	ETR.	ETR.	ETR.	ETR.	ETR.		
	022 CORRIDOR	CONC.	ETR	ETR	ETR.	ETR.	ETR.	ETR.	ETR.	ETR.		
	025 CLASSROOM	CONC.	VCT	RB	ETR.	ETR.	ETR.	ETR.	ETR.	ETR.	NOTE 1	
	025A CR STORAGE	CONC.	VCT	RB	ETR.	ETR.	ETR.	ETR.	ETR.	ETR.	NOTE 1	
	025B CR TOILET	CONC.	VCT	RB	ETR.	ETR.	ETR.	ETR.	ETR.	ETR.	NOTE 1	
	025C OFFICE	CONC.	VCT	RB	ETR.	ETR.	ETR.	ETR.	ETR.	ETR.	NOTE 1	
	026 CORRIDOR	CONC.	ETR	ETR	ETR.	ETR.	ETR.	ETR.	ETR.	ETR.		
FIRST FLOOR	101 OFFICE	WOOD	VCT	RB	ETR.	ETR.	ETR.	ETR.	ETR.	ETR.	NOTES 1, 2	
	102 CLASSROOM	WOOD	VCT	RB	ETR.	ETR.	ETR.	ETR.	ETR.	ETR.	NOTES 1, 2	
	102A CR STORAGE	WOOD	VCT	RB	ETR.	ETR.	ETR.	ETR.	ETR.	ETR.	NOTE 1	
	102B CR TOILET	WOOD	VCT	RB	ETR.	ETR.	ETR.	ETR.	ETR.	ETR.	NOTE 1	
	103 CLASSROOM	WOOD	VCT	RB	ETR.	ETR.	ETR.	ETR.	ETR.	ETR.	NOTES 1, 2	
	103A CR STORAGE	WOOD	VCT	RB	ETR.	ETR.	ETR.	ETR.	ETR.	ETR.	NOTE 1	
	103B CR TOILET	WOOD	VCT	RB	ETR.	ETR.	ETR.	ETR.	ETR.	ETR.	NOTE 1	
	110 OFFICE	WOOD	VCT	RB	ETR.	ETR.	ETR.	ETR.	ETR.	ETR.	NOTES 1, 2	
	111 CORRIDOR	WOOD	ETR	ETR	ETR.	ETR.	ETR.	ETR.	ETR.	ETR.		
	114 CLASSROOM	WOOD	VCT	RB	ETR.	ETR.	ETR.	ETR.	ETR.	ETR.	NOTES 1, 2	
	114A CR STORAGE	WOOD	VCT	RB	ETR.	ETR.	ETR.	ETR.	ETR.	ETR.	NOTE 1	
	114B CR TOILET	WOOD	VCT	RB	ETR.	ETR.	ETR.	ETR.	ETR.	ETR.	NOTE 1	
	115 CLASSROOM	WOOD	VCT	RB	ETR.	ETR.	ETR.	ETR.	ETR.	ETR.	NOTES 1, 2	
	115A CR STORAGE	WOOD	VCT	RB	ETR.	ETR.	ETR.	ETR.	ETR.	ETR.	NOTE 1	
	115B CR TOILET	WOOD	VCT	RB	ETR.	ETR.	ETR.	ETR.	ETR.	ETR.	NOTE 1	
	120 ADMIN	CONC.	VCT	RB	ETR.	ETR.	ETR.	ETR.	ETR.	ETR.	NOTE 1	
	121 CONFERENCE RM.	CONC.	VCT	RB	ETR.	ETR.	ETR.	ETR.	ETR.	ETR.	NOTE 1	
	122 CORRIDOR	CONC.	VCT	RB	ETR.	ETR.	ETR.	ETR.	ETR.	ETR.	NOTE 1	
	123 MAIN OFFICE	CONC.	VCT	RB	ETR.	ETR.	ETR.	ETR.	ETR.	ETR.	NOTE 1	
	124 PRINCIPAL OFFICE	CONC.	VCT	RB	ETR.	ETR.	ETR.	ETR.	ETR.	ETR.	NOTE 1	
	124A TOILET	CONC.	ETR	ETR	ETR.	ETR.	ETR.	ETR.	ETR.	ETR.		
SECOND FLOOR	125 COPY ROOM	CONC.	VCT	RB	ETR.	ETR.	ETR.	ETR.	ETR.	ETR.	NOTE 1	
	129 CORRIDOR	CONC.	ETR	ETR	ETR.	ETR.	ETR.	ETR.	ETR.	ETR.		
	134 OFFICE	CONC.	VCT	RB	ETR.	ETR.	ETR.	ETR.	ETR.	ETR.	NOTE 1	
	135 LIBRARY/MEDIA CENTER	CONC.	VCT	RB	ETR.	ETR.	ETR.	ETR.	ETR.	ETR.	NOTE 1	
	135A STORAGE	CONC.	VCT	RB	ETR.	ETR.	ETR.	ETR.	ETR.	ETR.	NOTE 1	
	144 CLASSROOM	CONC.	VCT	RB	ETR.	ETR.	ETR.	ETR.	ETR.	ETR.	NOTE 1	
	144A CR STORAGE	CONC.	VCT	RB	ETR.	ETR.	ETR.	ETR.	ETR.	ETR.	NOTE 1	
	144B CR TOILET	CONC.	VCT	RB	ETR.	ETR.	ETR.	ETR.	ETR.	ETR.	NOTE 1	
	145 CORRIDOR	CONC.	ETR	ETR	ETR.	ETR.	ETR.	ETR.	ETR.	ETR.		
	146 CLASSROOM	CONC.	VCT	RB	ETR.	ETR.	ETR.	ETR.	ETR.	ETR.	NOTE 1	
	146A CR STORAGE	CONC.	VCT	RB	ETR.	ETR.	ETR.	ETR.	ETR.	ETR.	NOTE 1	
	146B CR TOILET	CONC.	VCT	RB	ETR.	ETR.	ETR.	ETR.	ETR.	ETR.	NOTE 1	
	202 CLASSROOM	WOOD	ETR	ETR	ETR.	ETR.	ETR.	ETR.	ETR.	ETR.		
	203 CLASSROOM	WOOD	VCT	RB	ETR.	ETR.	ETR.	ETR.	ETR.	ETR.	NOTES 1, 2	
	204 CLASSROOM	WOOD	VCT	RB	ETR.	ETR.	ETR.	ETR.	ETR.	ETR.	NOTES 1, 2	
	205 OFFICE	WOOD	VCT	RB	ETR.	ETR.	ETR.	ETR.	ETR.	ETR.	NOTES 1, 2	
	206 CORRIDOR	WOOD	VCT	RB	ETR.	ETR.	ETR.	ETR.	ETR.	ETR.	NOTE 1	
	207 CLASSROOM	WOOD	ETR	ETR	ETR.	ETR.	ETR.	ETR.	ETR.	ETR.	NOTES 1, 2	
	208 CLASSROOM	WOOD	VCT	RB	ETR.	ETR.	ETR.	ETR.	ETR.	ETR.	NOTES 1, 2	
	214 CLASSROOM	CONC.	VCT	RB	ETR.	ETR.	ETR.	ETR.	ETR.	ETR.	NOTE 1	
	218 CLASSROOM	CONC.	VCT	RB	ETR.	ETR.	ETR.	ETR.	ETR.	ETR.	NOTE 1	
	219 CLASSROOM	CONC.	VCT	RB	ETR.	ETR.	ETR.	ETR.	ETR.	ETR.	NOTE 1	
	220 CLASSROOM	CONC.	VCT	RB	ETR.	ETR.	ETR.	ETR.	ETR.	ETR.	NOTE 1	
	221 CLASSROOM	CONC.	VCT	RB	ETR.	ETR.	ETR.	ETR.	ETR.	ETR.	NOTE 1	
	222 CORRIDOR	CONC.	ETR	ETR	ETR.	ETR.	ETR.	ETR.	ETR.	ETR.		

GENERAL FINISH NOTES

- CONTRACTOR SHALL FIELD VERIFY ALL CONDITIONS & DIMENSIONS AND NOTIFY ARCHITECT IMMEDIATELY OF ANY DISCREPANCIES.
- FINISHES SCHEDULED FOR PRIMARY ROOMS ALSO APPLY TO SECONDARY ROOMS (IE: CLOSETS/ STORAGE AREAS, ETC.) ACCESSED FROM WITHIN THE SCHEDULED ROOM THAT MAY OR MAY NOT BE ASSIGNED A ROOM NAME & NUMBER.

FINISH SCHEDULE NOTES

- PATCH/REPAIR, PREP & PAINT ANY EXISTING FINISHED SURFACE DAMAGED DURING CONSTRUCTION ACTIVITIES - MATCH EXISTING FINISHES (V.I.F.).
- ALTERNATE #3: REFER TO SECTION 012500 AND CONSTRUCTION NOTE #3 ON FLOOR PLAN FOR MORE INFORMATION.

EXISTING COND. ABBREVIATIONS		FINISH SCHEDULE LEGEND	
ENC	- FULL HEIGHT CABS/CLO	ACT	- ACCESTRAL CEILING TILE
CT	- COUNTERTOP W/IC	PT	- PAINTED GYP BOARD
EC	- BASE CABINET VCT	RB	- RUBBER BASE
QH	- OVERHEAD CONNECTOR	ETR	- EXISTING TO REMAIN
VCT	- VINYL COMPOSITION TILE	CT	- CERAMIC WALL TILE
ERT	- RAISED RUBBER TILE	CPT	- CERAMIC FLOOR TILE
CPT	- CARPET OVER VCT	CWB	- CERAMIC WALL BASE
		VCT	- VINYL COMPOSITION TILE
		GWB	- GYPSON WALLBOARD
		CHL	- CONCRETE HANGING LFT

GENERAL NOTES


- TEMPORARILY REMOVE & REINSTALL EXISTING BUILT-IN COMPONENTS (INCLUDING BUT NOT LIMITED TO SHELVING, STORAGE CUBBIES, LOCKERS, WARDROBES, STORAGE CABINETS, ETC.) AS REQUIRED TO COMPLETELY REMOVE EXISTING FLOORING AND TO PROVIDE SCHEDULED FLOORING. PROTECT ANY REMOVED ITEM/ASSEMBLY AND REPAIR DAMAGE CAUSED DURING CONSTRUCTION. CONTRACTOR TO FIELD VERIFY EXISTING CONDITIONS AT EACH AREA OF WORK, AS CONDITIONS MAY VARY BY ROOM/LOCATION.
- DIMENSIONS & LAYOUTS SHOWN ON THE DRAWINGS ARE APPROXIMATE BASED ON EXISTING AS-BUILT DRAWINGS PROVIDED BY THE OWNER AND MAY NOT REFLECT ACTUAL FIELD CONDITIONS - CONTRACTOR IS RESPONSIBLE FOR FIELD VERIFYING ALL EXISTING CONDITIONS, INCLUDING FIELD-VERIFIED DIMENSIONS, CONFIGURATIONS AND FINISHES. NOTIFY THE ARCHITECT IMMEDIATELY UPON DISCOVERY OF ANY DISCREPANCIES.
- CONTRACTOR IS REQUIRED TO VISIT THE SITE AND BECOME FULLY FAMILIAR WITH THE EXISTING CONDITIONS AND THE SCOPE OF WORK PRIOR TO SUBMITTING A BID.

DEMOLITION NOTES

- REMOVE EXISTING RESILIENT TILE FLOORING, CARPET FLOORING, WALL BASE & TRANSITION STRIPS AT CLASSROOM, INCLUDING CLASSROOM STORAGE CLOSETS & TOILET ROOMS. PREP EXISTING WOOD OR CONCRETE (V.I.F.) SUBSTRATE TO RECEIVE SCHEDULED FINISH. AT DOORWAY TO CORRIDOR, CUT AND REMOVE EXISTING FLOORING TO A POINT ALIGNED WITH CENTER OF DOOR (V.I.F.). SEE TRANSITION STRIP DETAIL FOR MORE INFO.
- REMOVE EXISTING CARPET FLOORING & ALL ASSOCIATED COMPONENTS, INCLUDING EXISTING WALL BASE. PREP EXISTING SUBSTRATE (V.I.F.) TO RECEIVE SCHEDULED FINISH. REFER TO DEMO NOTE #1 ABOVE FOR DOORWAY INFO.
- REMOVE EXISTING RESILIENT TILE FLOORING & WALL BASE AND PREP EXISTING SUBSTRATE (V.I.F.) TO RECEIVE SCHEDULED FINISH. REFER TO DEMO NOTE #1 ABOVE FOR DOORWAY INFO.


CONSTRUCTION NOTES


- REPAIR & PREP EXISTING WOOD OR CONCRETE SUBSTRATE (V.I.F.) AT AREAS OF FLOORING REMOVAL, AS REQUIRED TO RECEIVE SCHEDULED RESILIENT FLOORING FINISH. REPAIR & PREP EXISTING WALL SUBSTRATE AS REQUIRED TO RECEIVE SCHEDULED WALL BASE. PROVIDE SCHEDULED FINISHES - REFER TO FINISH SCHEDULE FOR MORE INFORMATION.
 - ALTERNATE #3: REFINISH WOOD SUBSTRATE
- IN LIEU OF PROVIDING SCHEDULED RESILIENT FLOORING FINISH AT ROOMS WITH EXISTING WOOD SUBSTRATE, REPAIR, PATCH & PREP EXISTING WOOD STRIP FLOOR SUBSTRATE TO MATCH EXISTING SPECIES, GRADE, COLOR & SIZE AND PROVIDE TRANSPARENT FINISH. REFER TO SPECIFICATIONS FOR ADDITIONAL INFORMATION & REQUIREMENTS.

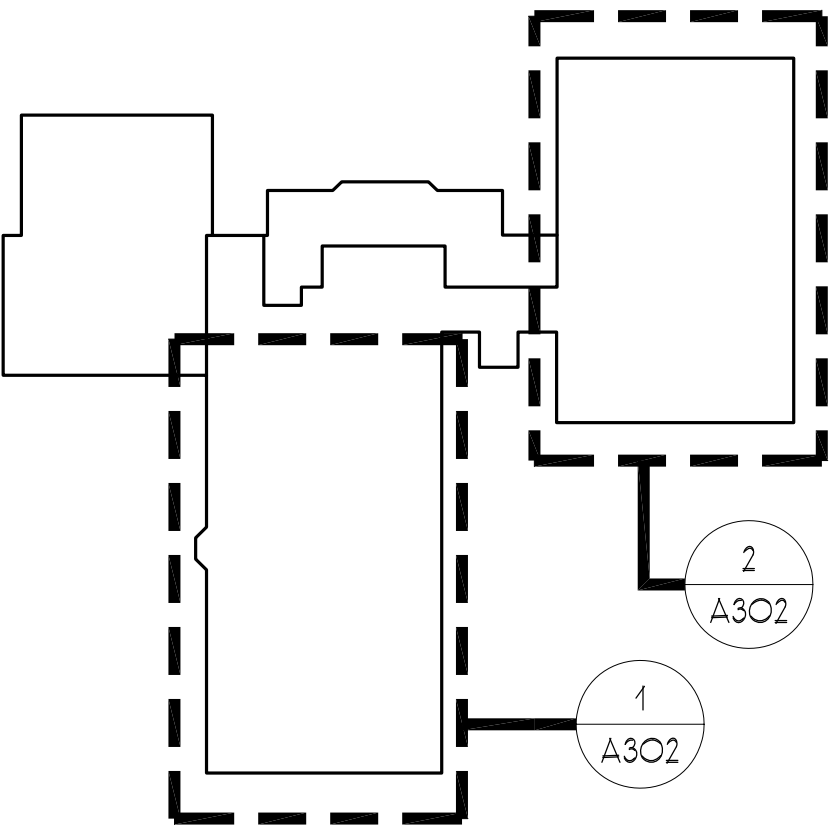


HOP BROOK
SECOND FLOOR KEY PLAN

NOT TO SCALE

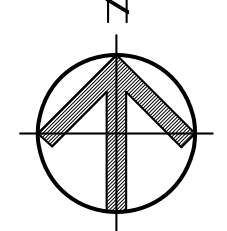


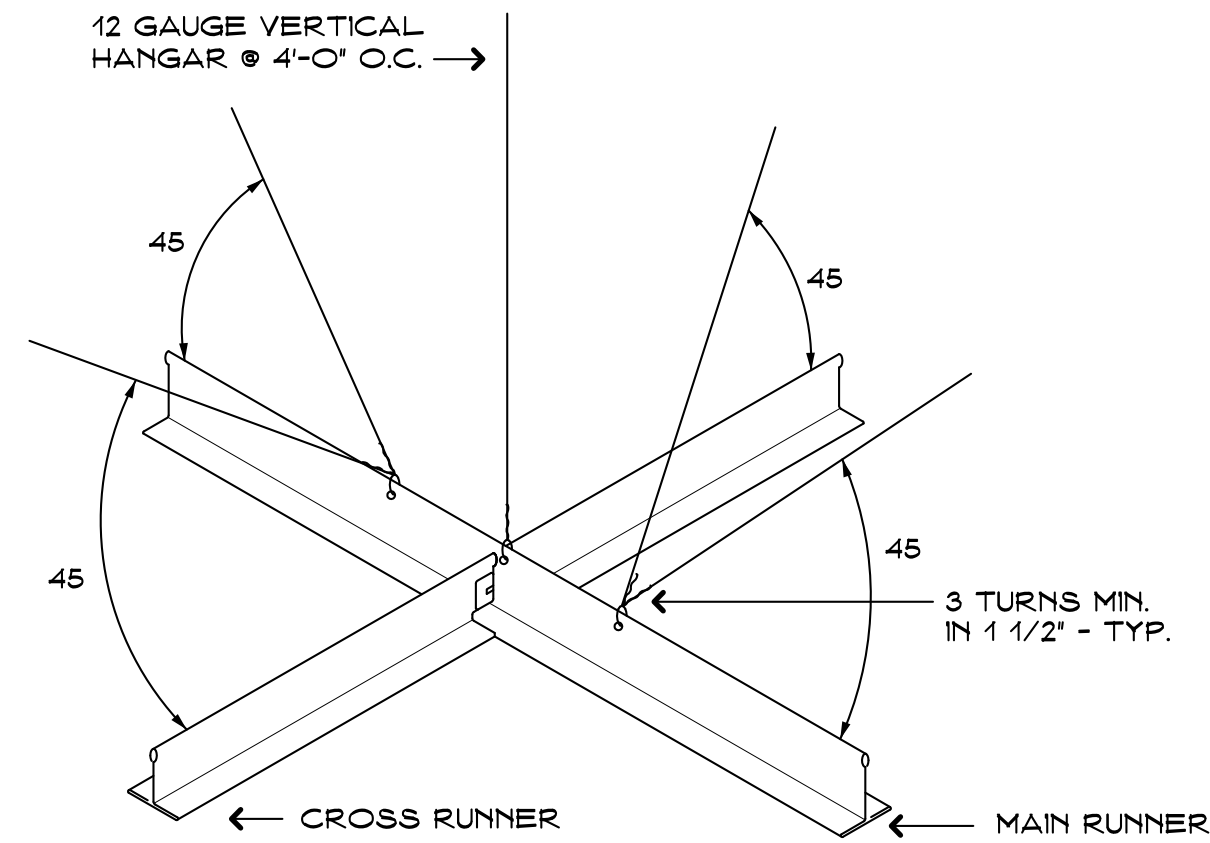


SEISMIC BRACING DETAIL A
SCALE: NONE

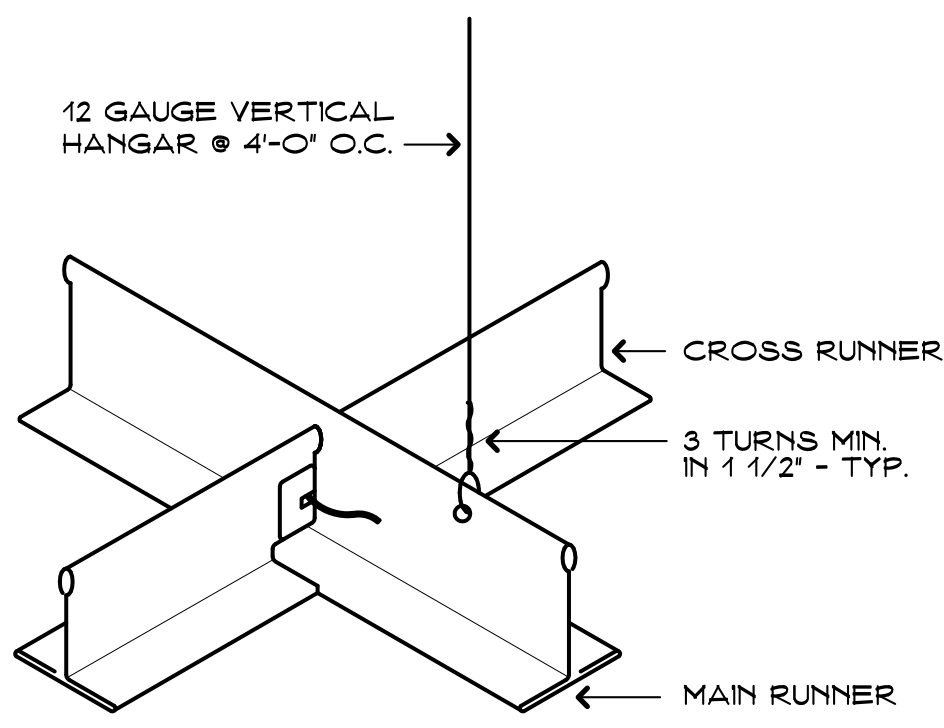

NOTE:
BRACING TO OCCUR
@ 4'-0" O.C. - TYP.

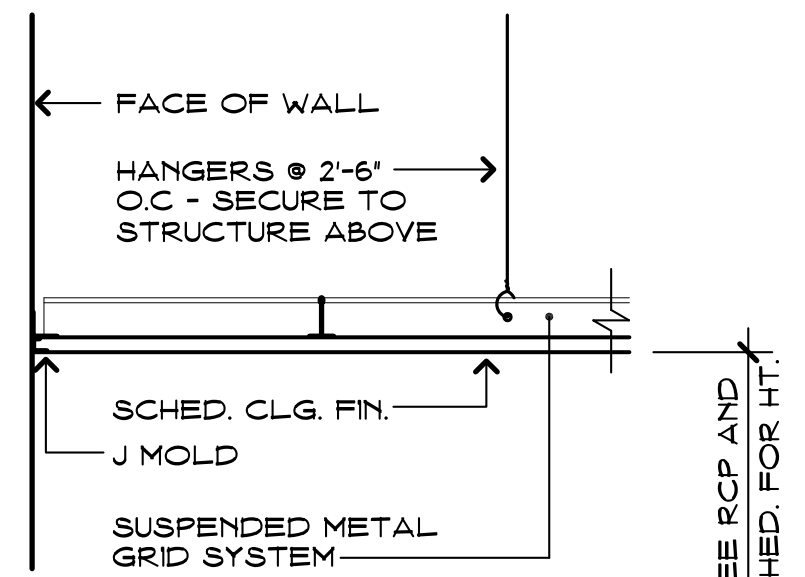

TYPICAL CEILING DETAIL B
SCALE: 1 1/2" = 1'-0"

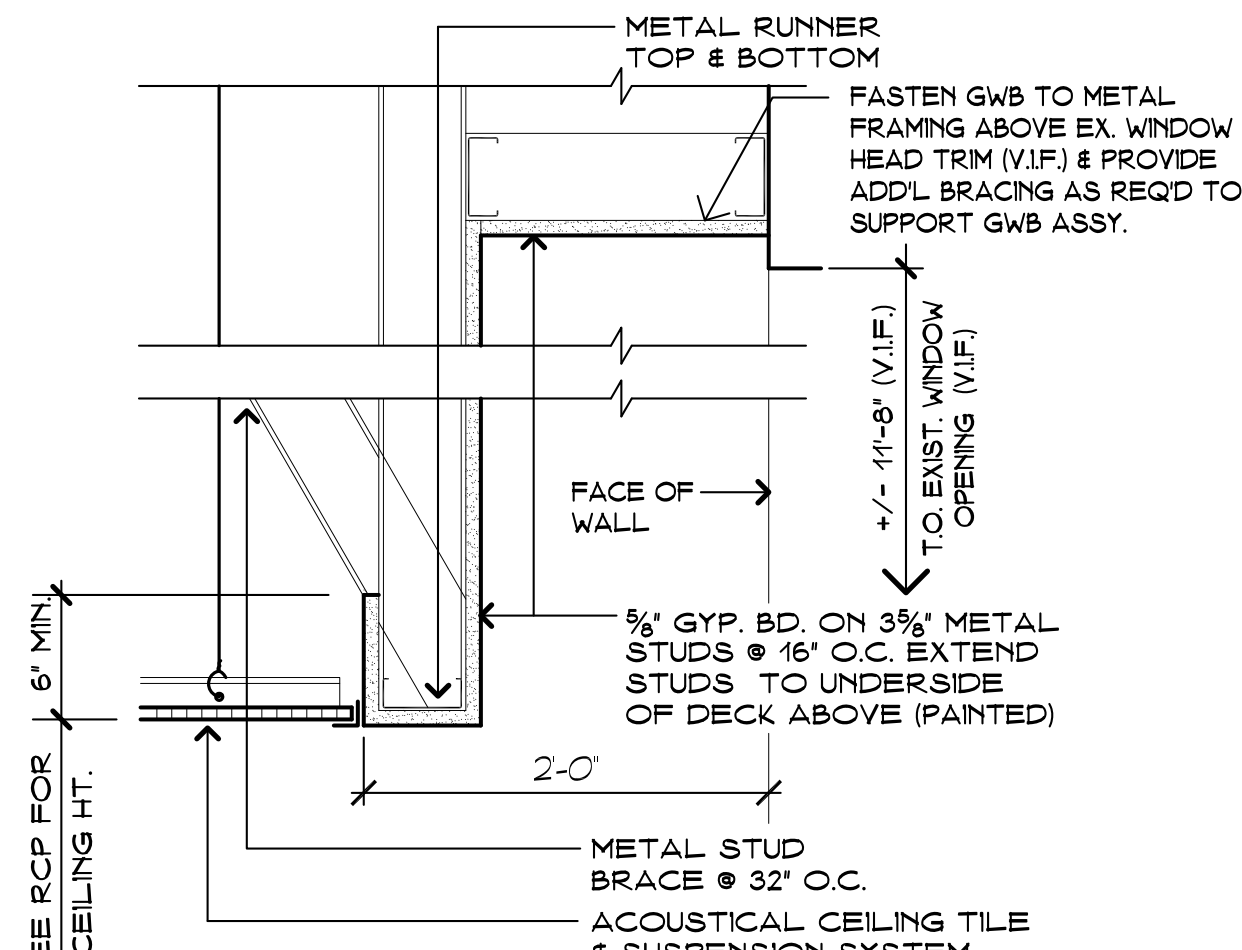

CEILING DETAIL C
SCALE: 1 1/2" = 1'-0"

ELECTRICAL NOTES

- (E1) FURNISH FIXTURE WITH AN EMERGENCY BATTERY PACK (1400 LUMEN)
- (E2) REPLACE EXISTING LIGHT SWITCH(ES) WITH NEW 0-10 VOLT DIMMING SWITCH. ALSO PROVIDE ADDITIONAL WIRING FROM NEW DIMMER SWITCH TO FIXTURES FOR CONTROL OF THE 0-10 VOLT DIMMING.

LIGHT FIXTURE SCHEDULE

DESIGNATION	MFR	MODEL NUMBER
A	LITHONIA	2GTL-4-48L-EZH-LP840
B	LITHONIA	2GTL-4-40L-EZH-LP840
C	LITHONIA	2GTL-4-30L-EZH-LP840
D	LITHONIA	2GTL-2-20L-EZH-LP840

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- CONTRACTOR IS REQUIRED TO VISIT THE SITE AND BECOME FULLY FAMILIAR WITH THE EXISTING CONDITIONS AND THE SCOPE OF WORK PRIOR TO SUBMITTING A BID.

DEMOLITION NOTES


- PROVIDE THE FOLLOWING CEILING DEMOLITION WORK:
 - REMOVE EXISTING ACOUSTICAL CEILING TILES FROM THE EXISTING SUSPENDED CEILING GRID. PROTECT EXISTING SUSPENDED CEILING GRID TO REMAIN.
 - TEMPORARILY REMOVE, DISCONNECT & PROTECT EXISTING-TO-REMAIN CEILING MOUNTED COMPONENTS, INCLUDING (BUT NOT LIMITED TO) LIGHTING, SENSORS, CCTV, NETWORK COMPONENTS, SMOKE DETECTORS, HVAC COMPONENTS, EXIT SIGNS, SPEAKERS, SPRINKLER HEADS, ETC., AS REQUIRED TO PROVIDE THE WORK. PROTECT ALL EXISTING TO REMAIN COMPONENTS FROM WORK ACTIVITIES.
- ALTERNATE #4: SPRINKLER HEAD REPLACEMENT.
 - REMOVE EXISTING SPRINKLER HEADS AT ALL ROOMS/SPACES ON THE SECOND & THIRD FLOORS AND PROVIDE NEW SPRINKLER HEADS & TRIM (SEE FIRE PROTECTION DETAILS & NOTES ON A404). CONTRACTOR REQUIRED TO FIELD VERIFY SPRINKLER HEAD QUANTITIES & LOCATIONS AND FIELD VERIFY EXISTING FIRE SUPPRESSION SYSTEM.
- REMOVE EXISTING METAL PANEL CEILING ASSEMBLY & PREP FOR PROVISION OF NEW SUSPENDED CEILING ASSEMBLY. DISCONNECT & REMOVE EXISTING SURFACE MOUNTED LIGHT FIXTURES, HVAC COMPONENTS & OTHER CEILING MOUNTED COMPONENTS (V.I.F.) AND PREP ELECTRICAL FOR PROVISION OF NEW LAY-IN FIXTURES.

CONSTRUCTION NOTES

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 - CLEAN & PREP EXISTING SUSPENDED CEILING GRID TO RECEIVE NEW PAINTED FINISH - ALL DUST, GREASE, OIL, RUST, ETC. MUST BE REMOVED PRIOR TO PAINTING. PROTECT ADJACENT FINISHES, EQUIPMENT, FURNISHINGS AND CEILING-MOUNTED COMPONENTS FROM PAINTING WORK.
 - REPAIR DAMAGED PORTIONS OF EXISTING SUSPENDED CEILING GRID MAINS, TEES & PERIMETER TRIM, INCLUDING AREAS THAT ARE NOT SUITABLE TO RECEIVE NEW PAINTED FINISH.
 - PROVIDE EXISTING SUSPENDED CEILING GRID WITH NEW "WHITE" PAINTED FINISH TO MATCH STANDARD WHITE FINISH BY ARMSTRONG (PROVIDE COLOR MATCH).
 - REINSTALL ALL EXISTING TO REMAIN CEILING MOUNTED FIXTURES/COMPONENTS AT EXISTING LOCATIONS.
- PROVIDE SUSPENDED CEILING ASSEMBLY. REINSTALL EXISTING TO REMAIN CEILING MOUNTED COMPONENTS & PROVIDE NEW LAY-IN LIGHT FIXTURES. PROVIDE NEW HVAC GRILLES & CONNECT TO EXISTING HVAC SYSTEM (V.I.F.).

CEILING LEGEND

	SUSPENDED CEILING GRID		SPRINKLER HEAD
	GWB CEILING/SOFFIT		OCCUPANCY SENSOR
	CEILING HEIGHT A.F.F.		EXIT SIGN
	EXISTING CEILING HEIGHT TO REMAIN/MATCH EXISTING		SPEAKER
	2X2 OR 4X4 RECESSED LIGHT FIXTURE		CEILING MOUNTED PROJECTOR POLE & POWER RECEPTACLE
	NEW LIGHT FIXTURE & TYPE		CCTV CAMERA
	SURFACE MOUNTED LIGHT FIXTURE		RECESSED LIGHT FIXT. W/ PLEXIGLAS SHIELD
	HVAC OR EXHAUST FAN		

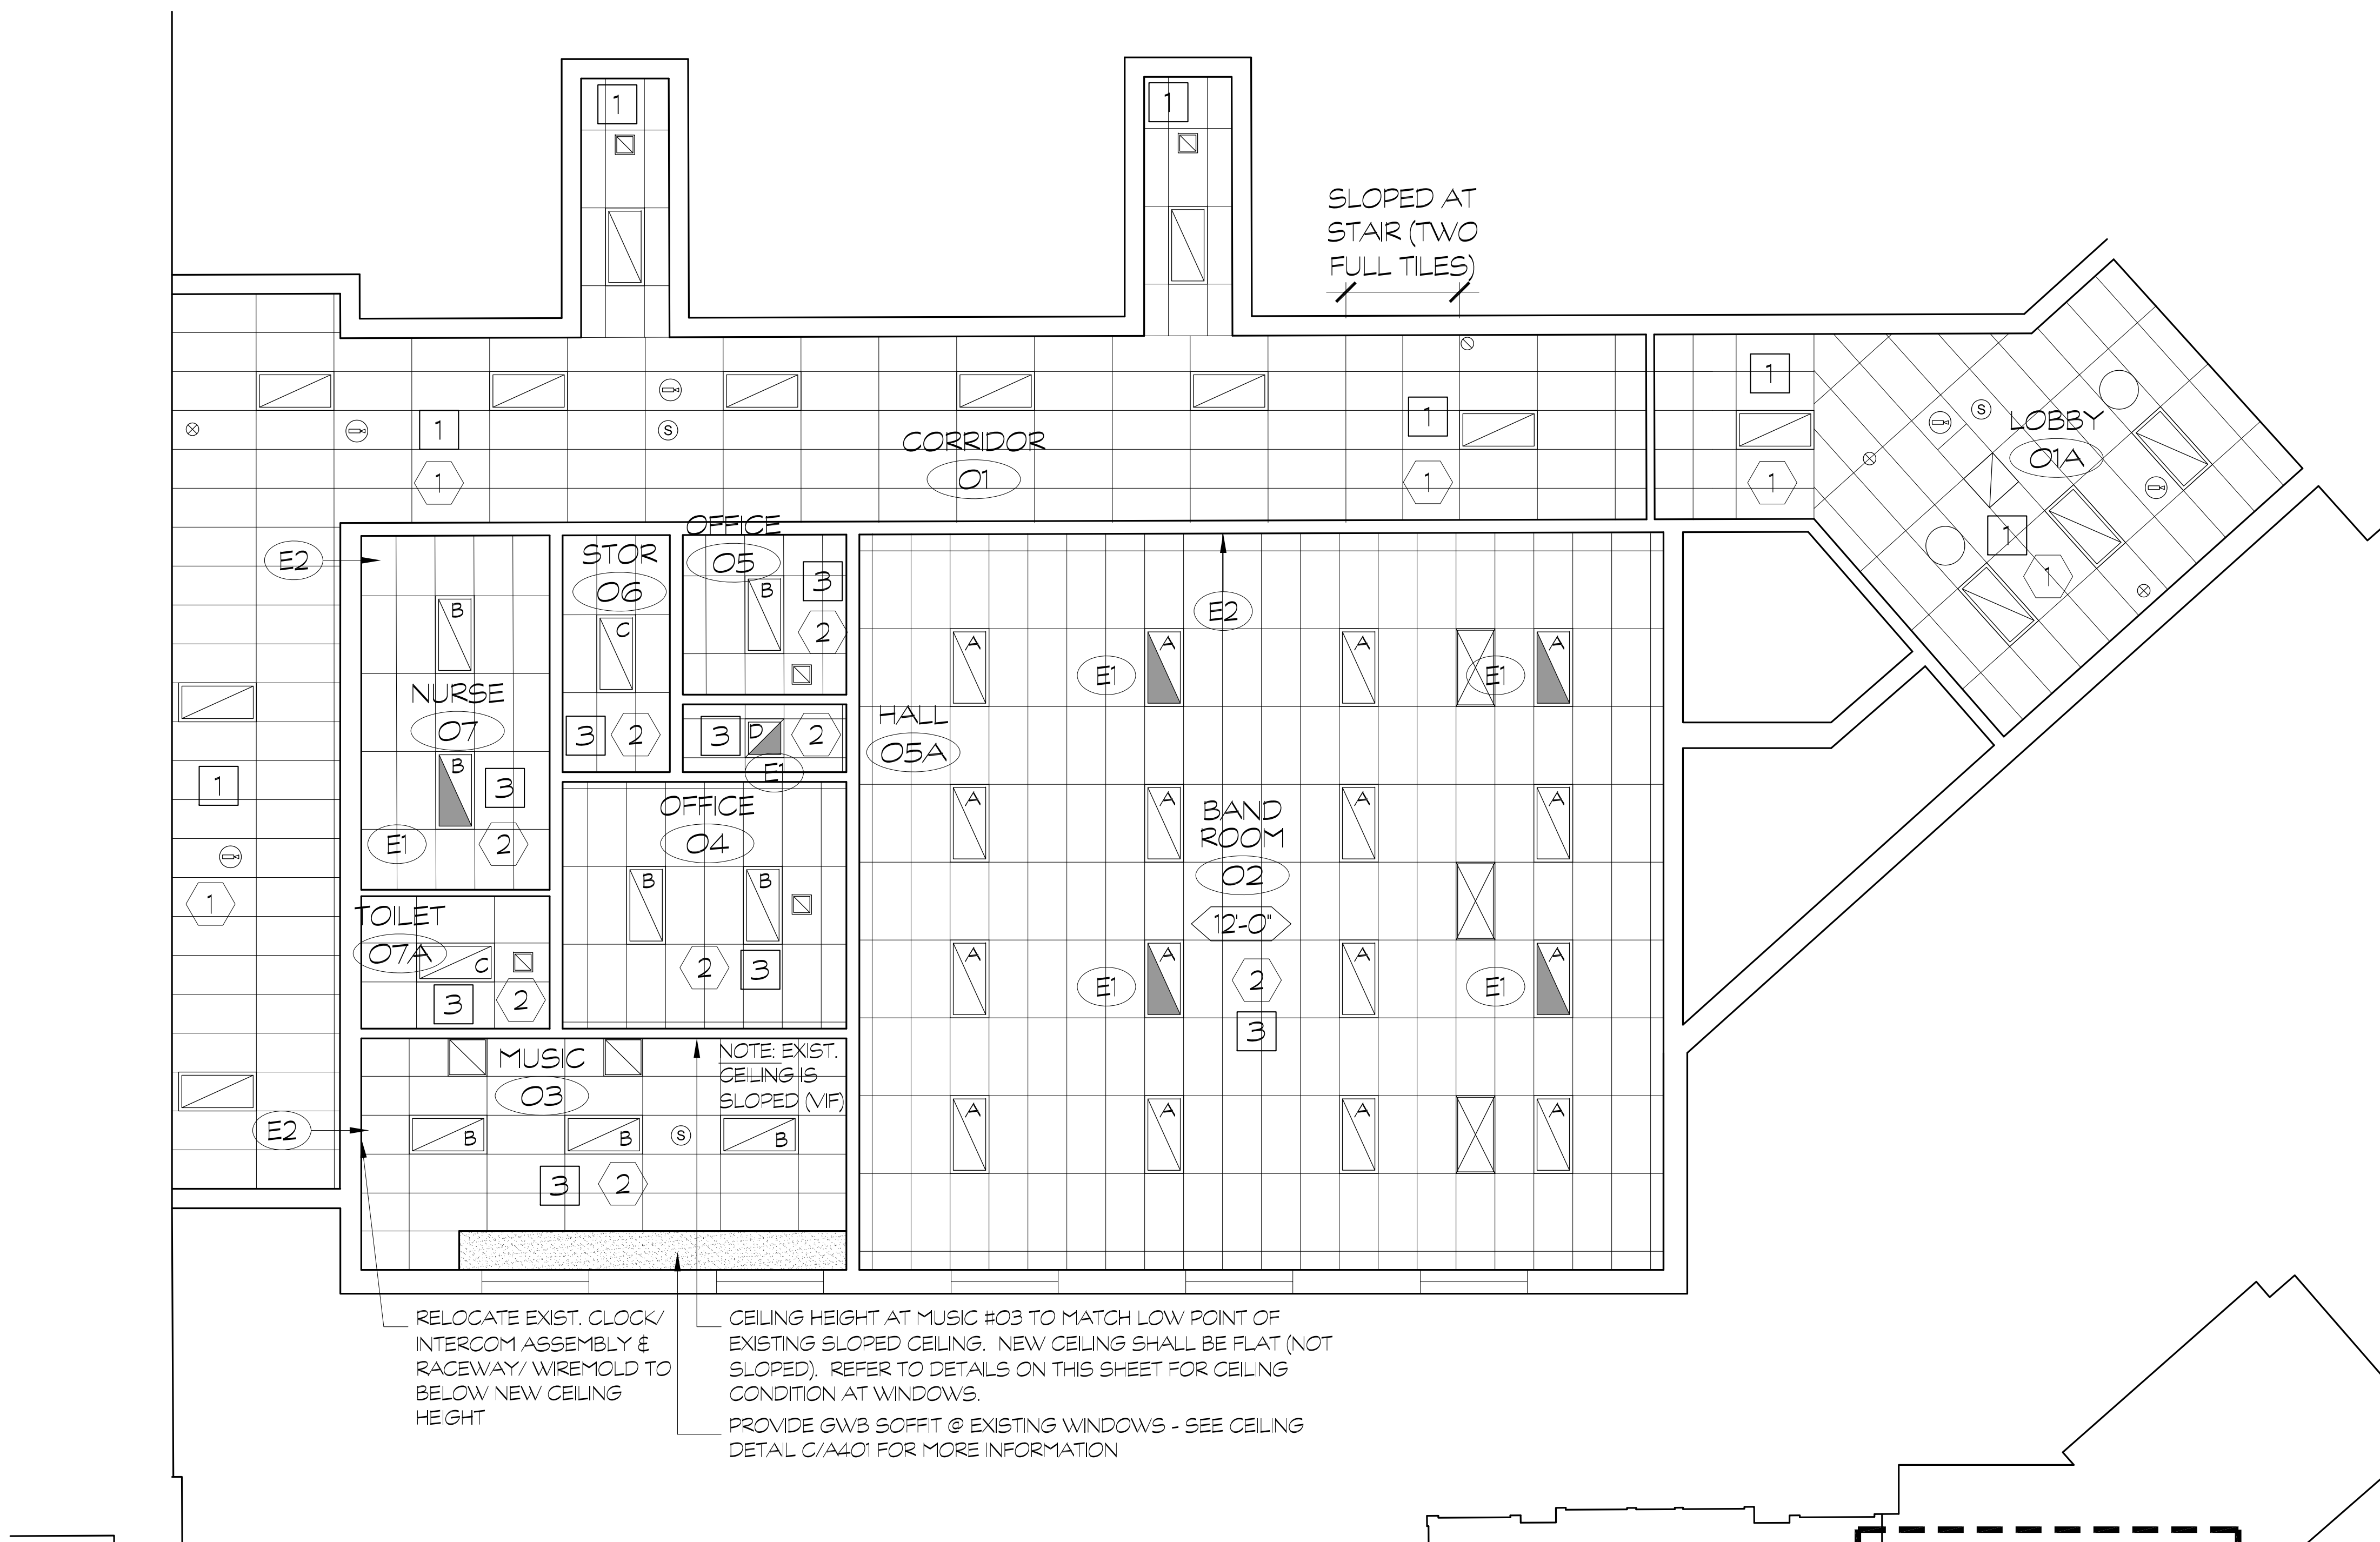

HILLSIDE - PARTIAL FIRST FLOOR RCP
SCALE: 3/16" = 1'-0"

HILLSIDE
FIRST FLOOR KEY PLAN
NOT TO SCALE



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2. CONTRACTOR IS REQUIRED TO VISIT THE SITE AND BECOME FULLY FAMILIAR WITH THE EXISTING CONDITIONS AND THE SCOPE OF WORK PRIOR TO SUBMITTING A BID.

DEMOLITION NOTES


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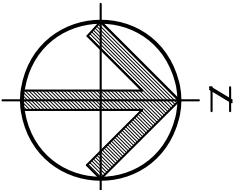
CEILING LEGEND

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	EXISTING CEILING HEIGHT TO REMAIN/MATCH EXISTING		SPEAKER
	2X2 OR 4X4 RECESSED LIGHT FIXTURE		CEILING MOUNTED PROJECTOR POLE & POWER RECEPTACLE
	NEW LIGHT FIXTURE & TYPE		CCTV CAMERA
	SURFACE MOUNTED LIGHT FIXTURE		RECESSED LIGHT FIXT. W/ PLEXIGLAS SHIELD
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HILLSIDE - SECOND FLOOR RCP
SCALE: 3/16"=1'-0"

1
A402



Borough of Naugatuck
District Wide School Upgrades
497 Rubber Ave
Naugatuck, Connecticut 06770

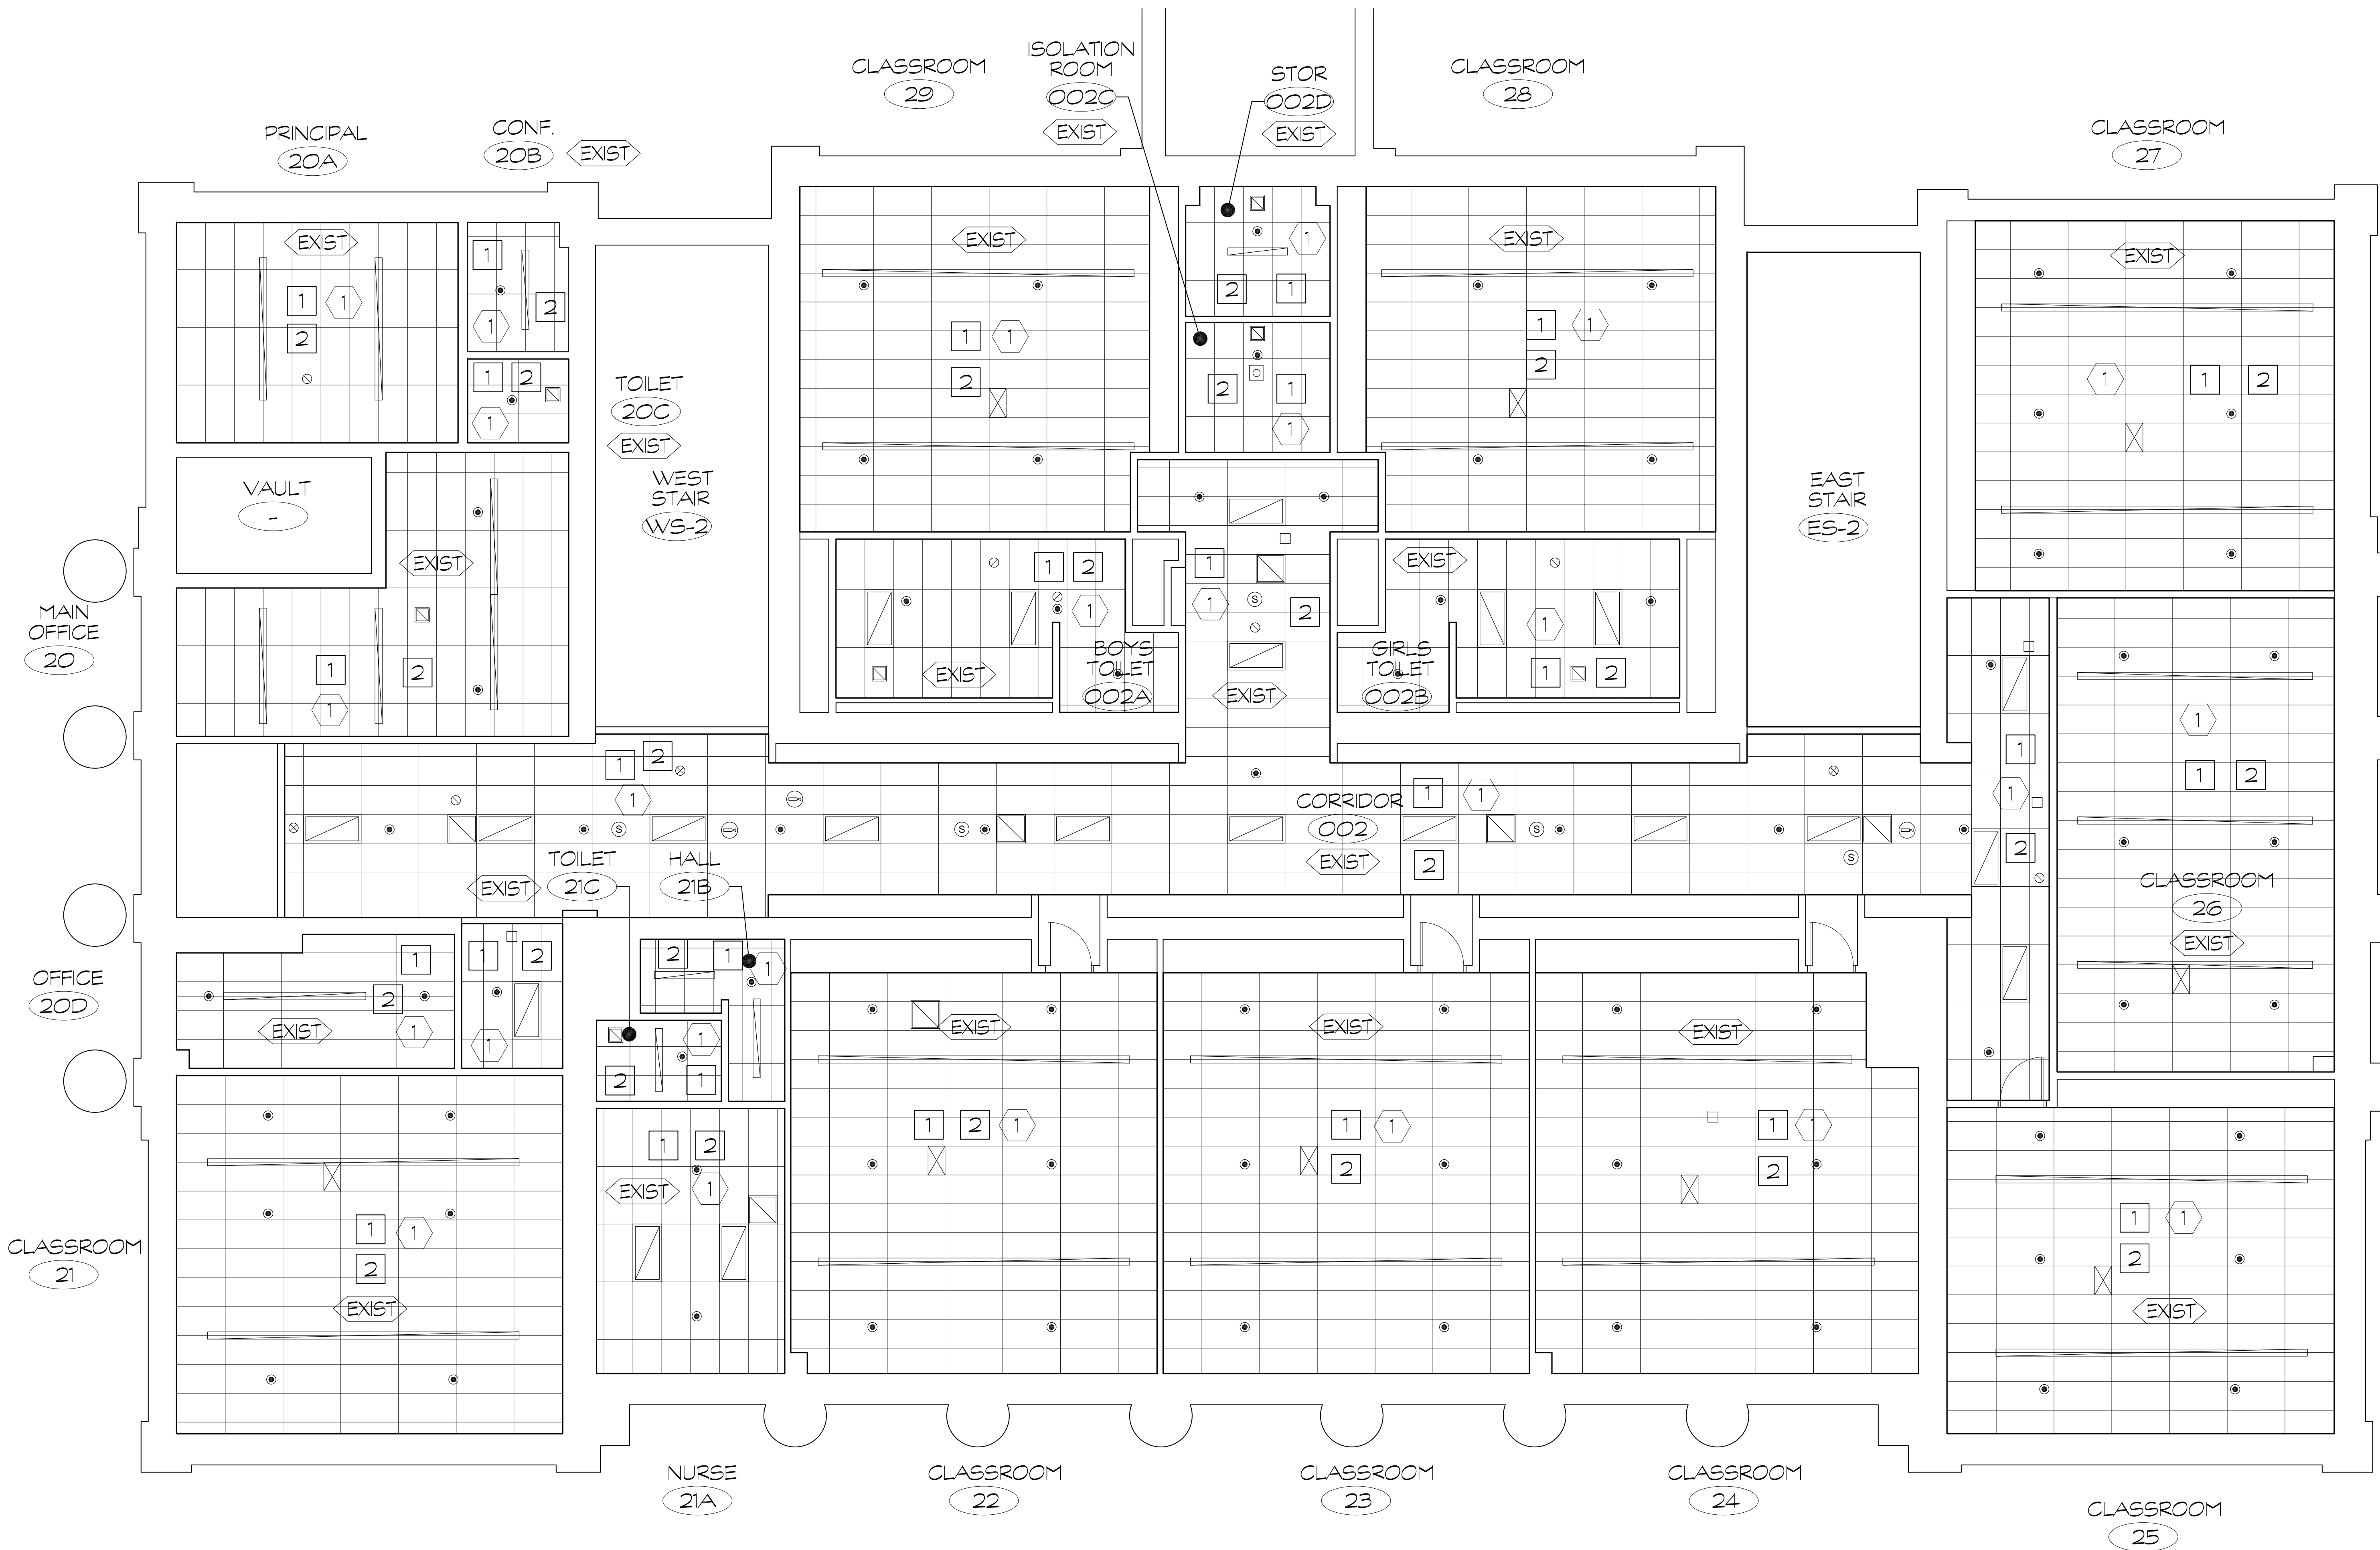

SILVER / PETRUCELLI + ASSOCIATES
Architects / Engineers / Interior Designers
3190 Whitney Avenue, Hamden, CT 06518-2340
Tel. 203 230 9007 Fax. 203 230 8247
silverpetrucelli.com

Revision	Description	Date	Revised By

Hillside School
2nd Floor Ceiling Plan

Date:
JUNE 14, 2016
Scale:
AS NOTED
Drawn By:
RH
Project Number:
16041

Drawing Number:
A402

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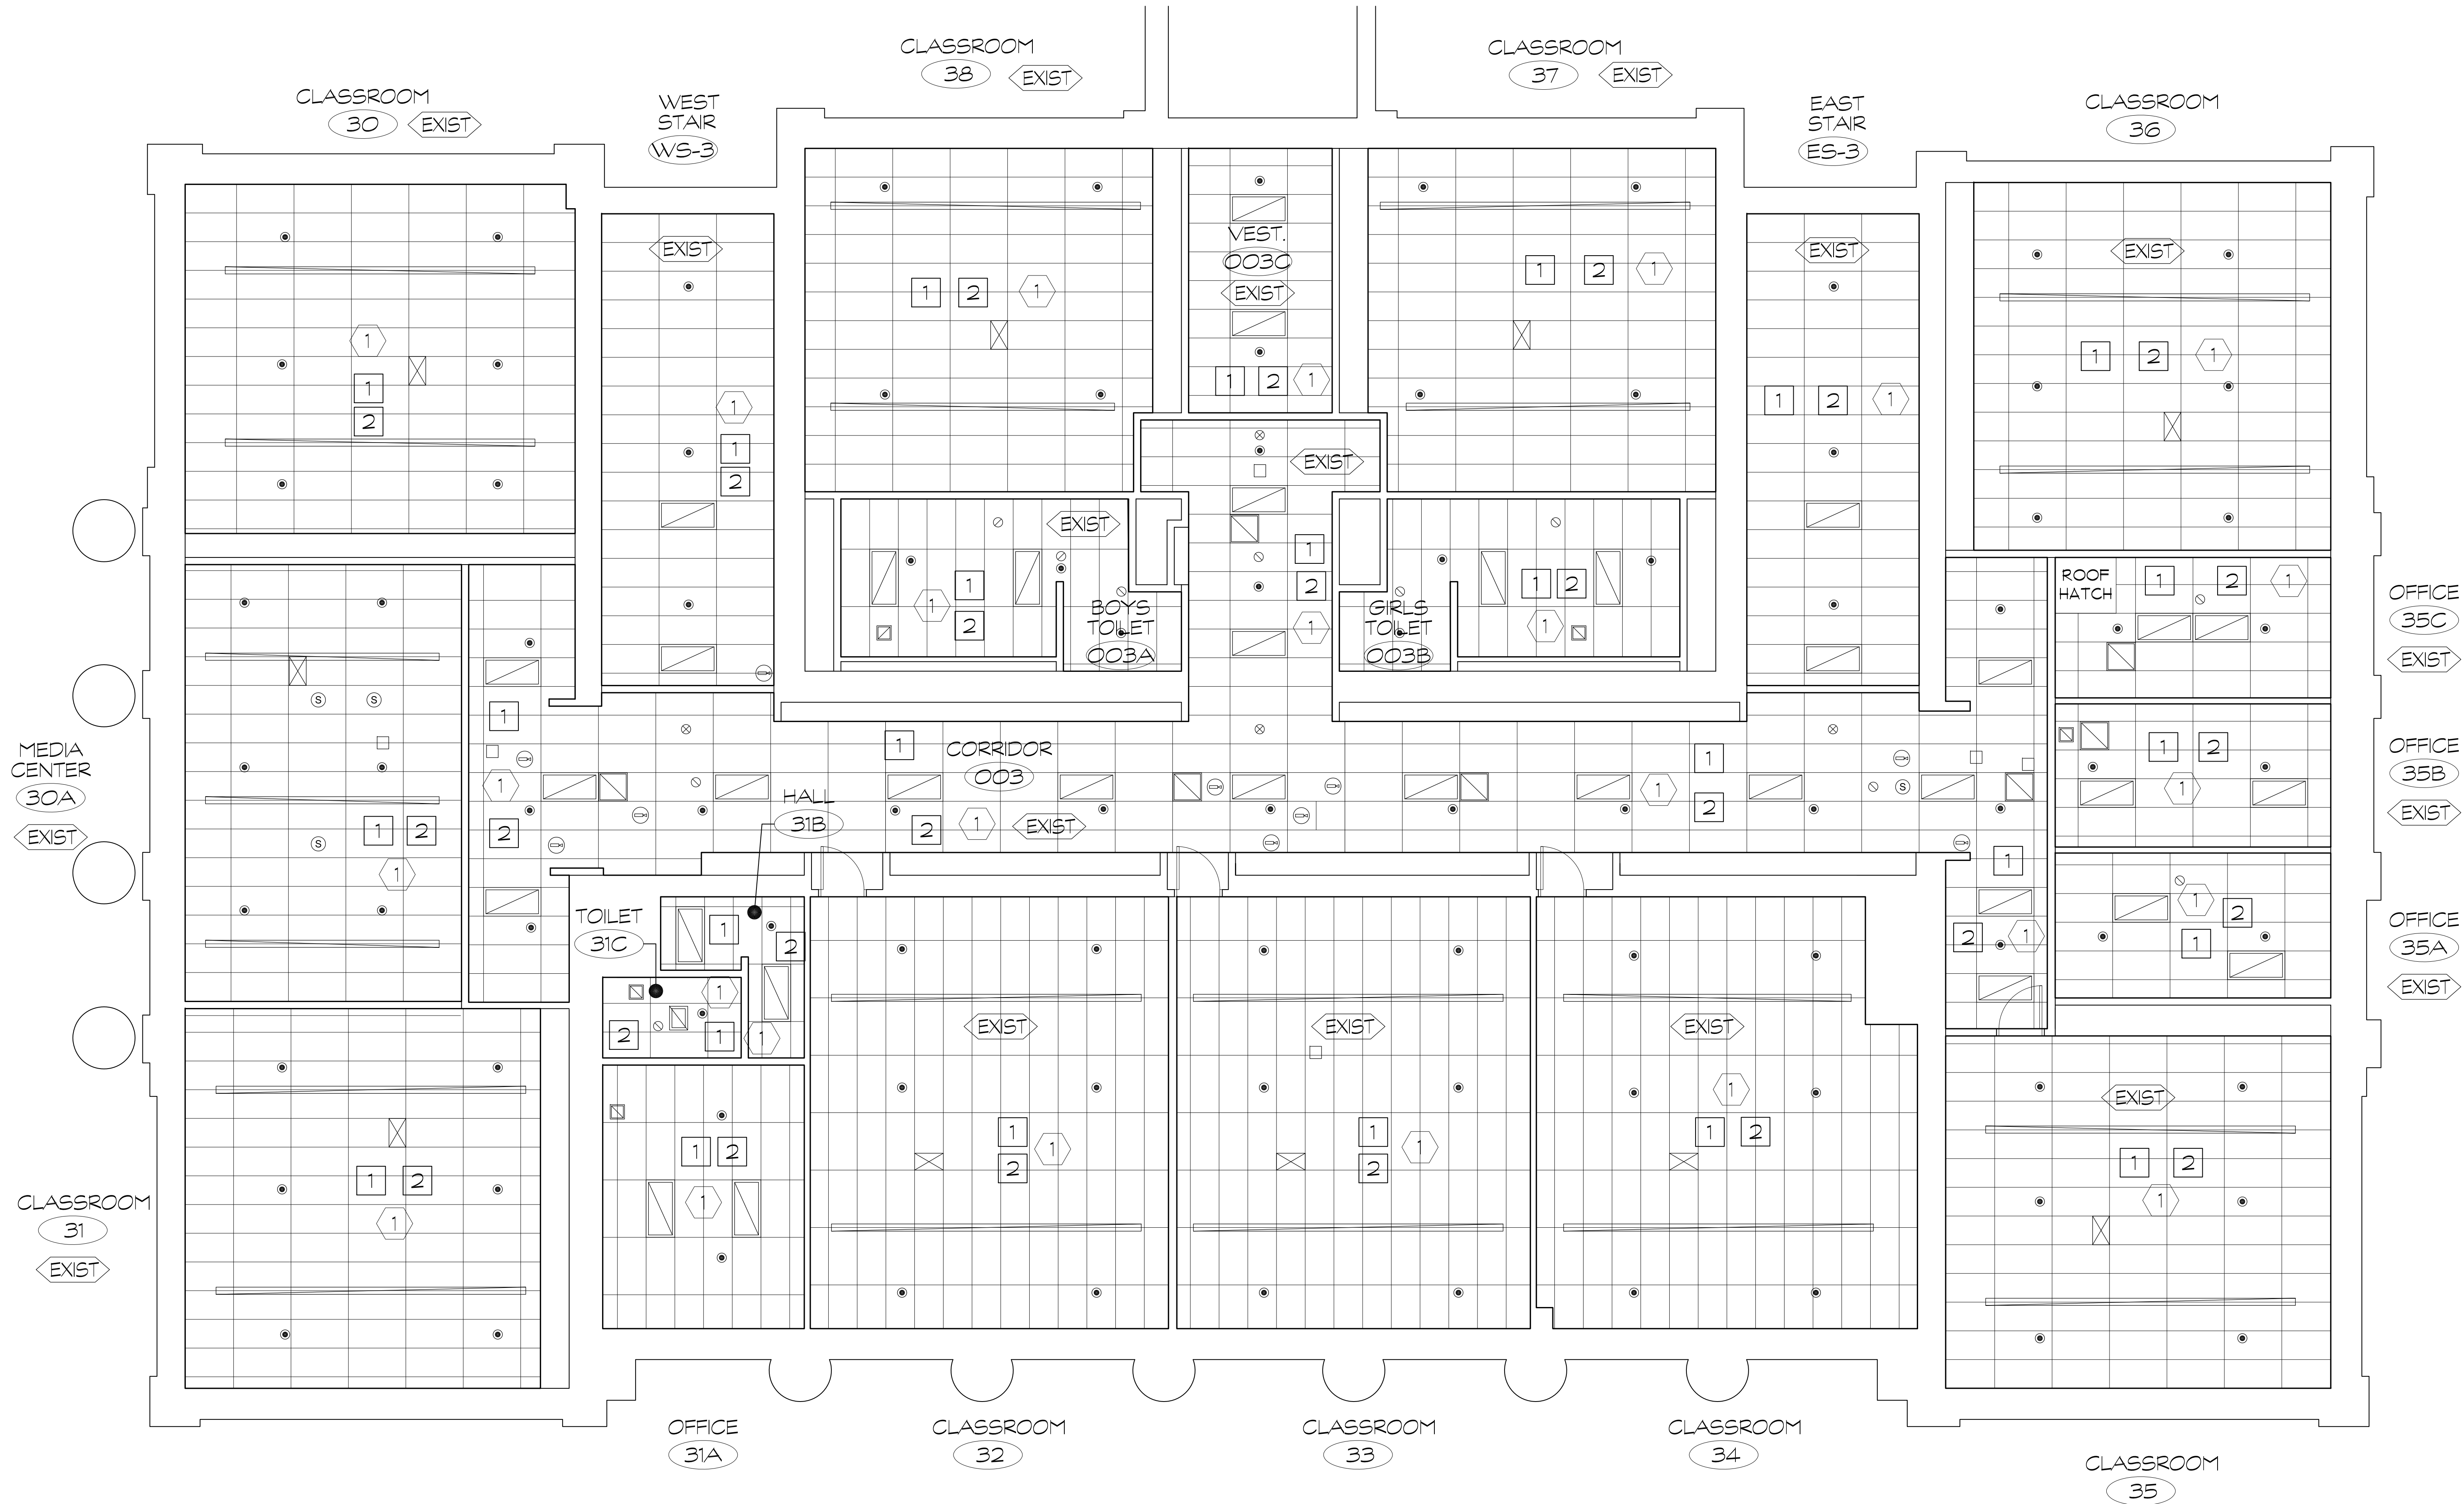
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- D. REINSTALL ALL EXISTING TO REMAIN CEILING MOUNTED FIXTURES/COMPONENTS AT EXISTING LOCATIONS.
2. PROVIDE SUSPENDED CEILING ASSEMBLY. REINSTALL EXISTING TO REMAIN CEILING MOUNTED COMPONENTS & PROVIDE NEW LAY-IN LIGHT FIXTURES. PROVIDE NEW HVAC GRILLES & CONNECT TO EXISTING HVAC SYSTEM (V.I.F.).


CEILING LEGEND

	SUSPENDED CEILING GRID		SPRINKLER HEAD
	GWB CEILING/SOFFIT		OCCUPANCY SENSOR
	CEILING HEIGHT A.F.F.		EXIT SIGN
	EXISTING CEILING HEIGHT TO REMAIN/MATCH EXISTING		SPEAKER
	2X2 OR 4X4 RECESSED LIGHT FIXTURE		CEILING MOUNTED PROJECTOR POLE & POWER RECEPTACLE
	NEW LIGHT FIXTURE & TYPE		CCTV CAMERA
	SURFACE MOUNTED LIGHT FIXTURE		RECESSED LIGHT FIXT. W/ PLEXIGLAS SHIELD
	HVAC OR EXHAUST FAN		



HILLSIDE - THIRD FLOOR RCP
SCALE: 3/16"=1'-0"

1
A403

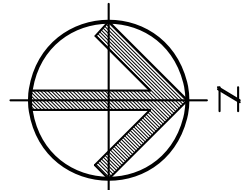

Borough of Naugatuck
District Wide School Upgrades
497 Rubber Ave
Naugatuck, Connecticut 06770



SILVER / PETRUCCELLI + ASSOCIATES
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Revision	Description	Date	Revised By

Hillside School
3rd Floor Ceiling Plan

Date:
JUNE 14, 2016
Scale:
AS NOTED
Drawn By:
RH
Project Number:
16041

Drawing Number:

A403

FIRE PROTECTION GENERAL NOTES

GENERAL

UTILIZE CONCEALED PENDENT SPRINKLERS AND PIPING IN AREAS WITH FINISHED CEILING, AND EXPOSED PIPING AND UPRIGHT SPRINKLERS IN AREAS WITHOUT CEILING. CONCEALED SPRINKLER HEADS LOCATED IN ACUSTICAL TILES TO UTILIZE FLEX HOSE PIPING 6 IN LENGTH. PROVIDE AND INSTALL SPRINKLERS UNDER AND ABOVE ALL OBSTRUCTIONS IN ACCORDANCE WITH NFPA 13.

ACTIVATION OF A FLOW SWITCH SHALL RESULT AS AN ALARM INDICATION AT THE FIRE ALARM CONTROL PANEL AND THE FIRE ALARM ANNUNCIATOR PANEL. THE SPRINKLER CONTRACTOR SHALL FURNISH ALL CONTRACT DOCUMENTS AND SHALL VERIFY ALL CONDITIONS IN THE FIELD. THE SPRINKLER

FIRE PROTECTION PLANS ARE INTENDED TO INDICATE TOTAL COVERAGE AND MAY OR MAY NOT INDICATE ALL SPRINKLER HEADS. SPRINKLER HEADS INDICATED ON DRAWINGS ARE DIAGRAMMATIC AND SHALL NOT BE COUNTED FOR BID. IT IS NOT THE INTENT OF THESE DRAWINGS TO SHOW ENTIRE PIPING LAYOUT. PROPOSED MAINS AND DEVICES INDICATED ONLY. THE CONTRACTOR SHALL PROVIDE A COMPLETE SPRINKLER SYSTEM WITH COMPLETE SPRINKLER COVERAGE, INDICATED OR NOT. ITEMS AND SERVICES NOT SHOWN ON DRAWINGS OR SPECIFICATIONS BUT REQUIRED TO RENDER THE WORK COMPLETE IN ACCORDANCE WITH NFPA, INSURANCE COMPANY REQUIREMENTS AND OWNERS. READY FOR OPERATION, SHALL BE PROVIDED AND INSTALLED. THE CONTRACTOR SHALL PROVIDE COMPLETE SPRINKLER COVERAGE AS REQUIRED INCLUDING BUT NOT LIMITED TO: DRAWING, SPACES, CONCEALED COMBUSTIBLE SPACES, SHAFTS, AND ALL CLOSETS.

DRAWINGS ARE DIAGRAMMATIC AND INDICATE A GENERAL ARRANGEMENT OF WORK AND ARE NOT TO BE CONSIDERED SUB-CONTRACTOR DOCUMENTS. IT IS THE INTENT OF THESE DOCUMENTS TO INCLUDE THE PROVISION AND INSTALLATION OF ALL NECESSARY WORK AND MATERIALS FOR COMPLETE, OPERATIONAL, AND CODE COMPLIANT SYSTEMS BY THE CONTRACTOR. GENERAL DESIGN CONCEPTS INDICATED MUST BE FOLLOWED OR BETTERED. THE BID SHALL INCLUDE OFFSETS, ADDITIONAL PIPING, VALVES AND EQUIPMENT AND COMPONENTS AS REQUIRED TO MEET CONSTRUCTION CONDITIONS FOR PROPER OPERATION. DO NOT SCALE DRAWINGS. CONSULT ARCHITECTURAL AND STRUCTURAL DRAWINGS FOR SPACE CONDITIONS AND ADDITIONAL REQUIREMENTS.

WHEN A CONFLICT BETWEEN THE DRAWINGS, NOTES AND/OR SPECIFICATIONS OCCUR, THE MORE STRINGENT, AND/OR LARGER QUANTITY AND/OR MORE EXPENSIVE SHALL APPLY. THE REQUIREMENTS LISTED WITHIN NOTES OR SPECIFICATIONS SHALL BE REQUIRED. PROVIDED AND INSTALLED WHETHER SPECIFICALLY INDICATED ON THE DRAWINGS OR NOT.

THE CONTRACTOR SHALL COORDINATE SPRINKLER HEAD LOCATIONS WITH THE LATEST ARCHITECTURAL, REFLECTED CEILING PLANS. ANY DISCREPANCIES SHALL BE BROUGHT BACK TO THE ARCHITECT/ENGINEER. DO NOT SCALE DRAWINGS FOR DIMENSIONS NOT INDICATED. REFER TO ARCHITECT FOR RESOLUTION FOR ANY DIMENSIONS NOT INDICATED.

IT IS THE INTENTION OF THE SPECIFICATIONS AND DRAWINGS TO PROVIDE FOR FINISHED WORK, TESTED AND READY FOR OPERATION.

THE DESIGN OF ALL FIRE SUPPRESSION SYSTEMS WILL BE IN ACCORDANCE WITH THE LOCAL AND STATE BUILDING CODE, NFPA 13, FM GLOBAL. USE ONLY UL/FM SPRINKLERS, MATERIALS AND DEVICES, UNLESS NOTED OTHERWISE.

CONCEALED SPRINKLERS AND PIPING SHALL BE INSTALLED IN AREAS WITH FINISHED CEILING. AREAS WITH EXPOSED CONSTRUCTION SHALL HAVE EXPOSED PIPING AND SPRINKLERS (CUSTOM COLOR).

THE SPRINKLER CONTRACTOR IS REQUIRED TO VISIT THE SITE AT THE TIME OF BID, TO EXAMINE CONDITIONS AND BECOME FAMILIAR WITH THE JOB, NOTING DEGREE OF DIFFICULTY IN GETTING EQUIPMENT INCLUDING LIFTS AND SCARFOLDING IN AND OUT OF THE BUILDING. ANY DISCREPANCIES SHALL BE BROUGHT TO THE ATTENTION OF THE ARCHITECT OR ENGINEER IN WRITING PRIOR TO SUBMITTING A BID.

NOTIFY PROPER AUTHORITIES (INCLUDING BUT NOT LIMITED TO THE LOCAL A.H.J., INSURANCE COMPANY, ETC.) OF ANY FIRE PROTECTION "SHUT DOWNS". SCHEDULE ALL WORK TO MINIMIZE THE LENGTH OF TIME THAT THE FIRE PROTECTION SYSTEM(S) WILL BE OUT OF SERVICE. RETURN THE SPRINKLER SYSTEM BACK IN SERVICE AT THE END OF EACH WORKING DAY. IF A FIRE WATCH IS REQUIRED BY THE LOCAL A.H.J., BUILDING MANAGER, ETC. IT SHALL BE PROVIDED BY THE GENERAL CONTRACTOR. FIRE WATCH SCHEDULED PERSONNEL SHALL BE COORDINATED WITH THE LOCAL A.H.J., BUILDING MANAGER AND INSURANCE COMPANY.

ASSEMBLE PIPING TO FACILITATE FLUSHING. PROVIDE READILY ACCESSIBLE DRAIN AND FLUSHING CONNECTIONS AS REQUIRED BY NFPA 13. PROVIDE AND INSTALL AUXILIARY DRAINS WITH PROVISIONS FOR COMPLETE DRAINAGE. PIPE ALL DRAINS TO

AN APPROVED LOCATION.

PROVIDE A HEAD GUARD ON SPRINKLERS IN AREAS SUBJECT TO MECHANICAL DAMAGE (I.E. SPRINKLERS IN MECHANICAL ROOMS, ETC.)

REFER TO ADDITIONAL NOTES ON ARCHITECTURAL DRAWINGS.

THE CONTRACTOR SHALL COORDINATE SPRINKLER WORK WITH THE OWNERS PHASING SCHEDULE PRIOR TO COMMENCEMENT OF ANY WORK. ALL PHASED SECTIONS OF WORK SHALL COMPLY WITH THE OWNERS SCHEDULE AND BE TESTED, INSPECTED, READY FOR OPERATION IN ACCORDANCE WITH NFPA, OWNERS INSURANCE COMPANY AND A.H.J. REQUIREMENTS.

THE CONTRACTOR SHALL PROVIDE COMPLETE SIGNED AND SEALED (BY LICENSED P.E.) DRAWINGS INDICATING ALL PIPING AND SPRINKLER HEADS. CONTRACTOR SHALL SECURE AND PAY COSTS OF PERMITS, CERTIFICATES, LICENSES, INSPECTIONS AND APPROVALS.

INSTALL SPRINKLERS BELOW DUCTS, AND/OR COMBINATIONS OF DUCTS/EQUIPMENT IN ACCORDANCE WITH THE OBSTRUCTION REQUIREMENTS OF NFPA 13.

SHEET METAL, PLUMBING AND FIRE PROTECTION SHOP DRAWINGS THAT HAVE BEEN COORDINATED WITH ARCHITECTURAL AND STRUCTURAL DRAWINGS SHALL BE SUBMITTED TO ENGINEER FOR REVIEW. DRAWINGS MUST BE RETURNED FROM ENGINEER EITHER REVIEWED OR FLUSH AS CORRECTED PRIOR TO BEING USED AS BASIS FOR COORDINATION DRAWINGS.

ALL DRAIN PIPING AND ANY PIPING SUBJECT TO ALTERNATE WETTING AND DRYING SHALL BE GALVANIZED.

ALL SYSTEM COMPONENTS SHALL BE CAPABLE OF WITHSTANDING A MINIMUM WORKING PRESSURE OF ITS PSI.

THE CONTRACTOR SHALL SEAL AROUND ALL NEW PENETRATIONS THROUGHOUT THE BUILDING WITH SEALANT OF FIRE AND/OR SMOKE RETARDANT TYPE EQUAL IN FIRE RATINGS TO THE STRUCTURE BEING PENETRATED. SEALANT SHALL BE A UL LISTED ASSEMBLY.

WORK OF THIS SECTION SHALL BE GOVERNED BY THE CONTRACT DOCUMENTS. PROVIDE MATERIALS, LABOR, EQUIPMENT AND SERVICES NECESSARY TO FURNISH, DELIVER AND INSTALL ALL WORK AS SPECIFIED AND AS REQUIRED BY JOB CONDITIONS. WHERE A CONFLICT EXISTS BETWEEN THESE NOTES, THE DRAWINGS AND THE SPECIFICATIONS, THE MORE STRINGENT REQUIREMENT SHALL APPLY.

PERFORM THE WORK IN ACCORDANCE WITH THE REQUIREMENTS OF THE CONTRACT GENERAL CONDITIONS AND WITH THE PROVISIONS OF ALL APPLICABLE LOCAL, STATE, AND FEDERAL CODES AND LAWS.

WORK SHALL INCLUDE ALL INCIDENTALS, LABOR, MATERIAL, EQUIPMENT, APPLIANCES, SERVICES, HOISTING, SCARFOLDING, SUPPORTS, TOOLS, CONSUMABLE ITEMS, FEES, LICENSES, AND ADMINISTRATIVE TASKS REQUIRED TO COMPLETE AND MAKE OPERABLE WORK SHOWN ON THE DRAWINGS, SPECIFIED HEREIN AND AS REQUIRED FOR A COMPLETE AND OPERATIONAL SYSTEM.

STORE MATERIALS INSIDE AND PROTECTED FROM DEBRIS, WEATHER AND MOISTURE.

THIS CONTRACTOR SHALL PROVIDE AND INSTALL ALL POWER AND CONTROL WIRING REQUIRED FOR EQUIPMENT OPERATION NOT SPECIFICALLY PROVIDED BY OTHERS BUT REQUIRED FOR A COMPLETE AND OPERATIONAL SYSTEM. THIS CONTRACTOR SHALL PROVIDE MOTOR STARTERS FOR INSTALLATION BY OTHERS. COORDINATE REQUIREMENTS.

ALTERATION WORK AND DEMOLITION

EXISTING PIPING AND SPRINKLERS SHOWN DO NOT NECESSARILY REFLECT EXACT FIELD CONDITIONS. FIELD VERIFY EXTENT AND LOCATION OF WORK TO BE REMOVED.

ALL EQUIPMENT, PIPING, ETC. TO BE REMOVED SHALL BE DISPOSED OF, TURNED OVER TO THE OWNER OR SALVAGED AS DIRECTED BY THE OWNERS. EQUIPMENT, PIPING, DEVICES, ETC. SHALL NOT BE REMOVED FROM THE PREMISES WITHOUT THE OWNERS APPROVAL.

NO EXISTING PIPE MAY BE CUT OR DAMAGED WHEN ENCOUNTERED ALONG THE ROUTE DESIGNED FOR NEW SERVICE. ANY EXISTING PIPING SEVERED OR DAMAGED SHALL BE REPLACED INCLUDING DAMAGED AREAS. ANY UNUSED OUTLETS SHALL BE PROPERLY CAPPED.

UPON COMPLETION OF REMOVALS AND MODIFICATIONS, ALL PIPING TO REMAIN SHALL BE PROPERLY PLUGGED, VALVED, CAPPED AND/OR BY PASSED SUCH THAT UPON COMPLETION OF WORK ALL SYSTEMS TO REMAIN REMAIN OPERATIONAL.

REMOVE & REPLACE ANY EXISTING SPRINKLER PIPING WHICH DOES NOT PASS THE REQUIRED HYDROSTATIC PRESSURE TESTS. CONDUCT VISUAL INTERNAL INSPECTIONS ON AT LEAST 50% OF ANY EXISTING PIPING TO REMAIN. NO DEAD ENDS SHALL BE LEFT ON ANY PIPING SYSTEMS UPON COMPLETION OF WORK.

EXISTING EXPOSED PIPING SYSTEMS NOT TO BE REMOVED, AND NOT SPECIFICALLY NOTED FOR REMOVAL SHALL BE COMPLETELY REMOVED.

ALL SYSTEMS SHALL BE LEFT IN WORKING ORDER TO THE SATISFACTION OF THE OWNER UPON COMPLETION OF ALL NEW WORK.

BE AWARE OF REMOVE ALL EXISTING PIPING AND SYSTEMS WHERE NECESSARY TO AVOID NEW EQUIPMENT, STRUCTURAL OR MASONRY WORK AS REQUIRED BY THE PROPOSED ALTERATIONS.

COORDINATION DRAWINGS

DEVELOP AND SUBMIT COORDINATION DRAWINGS AS OUTLINED.

SHEET METAL, PLUMBING AND FIRE PROTECTION SHOP DRAWINGS THAT HAVE BEEN COORDINATED WITH ARCHITECTURAL AND STRUCTURAL DRAWINGS SHALL BE SUBMITTED TO ENGINEER FOR REVIEW. DRAWINGS MUST BE RETURNED FROM ENGINEER EITHER REVIEWED OR FLUSH AS CORRECTED PRIOR TO BEING USED AS BASIS FOR COORDINATION DRAWINGS.

AFTER SHEET METAL AND PIPING DRAWINGS HAVE BEEN REVISED PER ENGINEERS COMMENTS, REPRODUCIBLE COPIES SHALL BE SENT TO THE TRADES IN THE FOLLOWING SEQUENCE FOR THE INCLUSION OF THEIR WORK.

- MECHANICAL SHEET METAL
- PLUMBING PIPING
- MECHANICAL PIPING
- SPRINKLER PIPING
- ELECTRICAL WORK

AFTER ALL TRADES HAVE INCLUDED THEIR WORK ON THE COORDINATION DRAWING AND NOTED CONFLICTS, ALL TRADES SHALL MEET TO RESOLVE CONFLICTS AND AGREE TO ACCEPTABLE SOLUTIONS. EACH TRADE SHALL SIGN COORDINATION DRAWINGS. ITEMS NOT SHOWN ON COORDINATION DRAWING IS RESPONSIBILITY OF OMITTING CONTRACTOR AND CONTRACTOR IS SUBJECT TO ADDITIONAL COSTS INCURRED BY OTHER TRADES.

THE ARCHITECT AND ENGINEER ARE NOT PART OF THE COORDINATION DRAWING PROCESS. THE ENGINEER WILL PROVIDE ASSISTANCE FOR NOTED CONFLICTS ONLY. INDICATING ALL NECESSARY COMPONENT CUTS, PLAN LOCATIONS AND CALCULATIONS FOR A COMPLETE SYSTEM.

PROVIDE ALL NECESSARY STRUCTURAL MEMBERS INCLUDING ADDITIONAL STRUCTURAL SUPPORT TO SUPPORT PIPING AND EQUIPMENT. HANGERS AND SUPPORTS SHALL BE OF AN APPROVED DESIGN NECESSARY TO SUPPORT PIPING, EQUIPMENT AND TO KEEP PIPING IN PROPER ALIGNMENT AND PREVENT TRANSMISSION OF NOISIOUS THRUSTS AND VIBRATIONS. IN ALL CASES WHERE HANGERS, BRACKETS, ETC., ARE SUPPORTED FROM CONCRETE CONSTRUCTION, DO NOT WEAKEN CONCRETE OR PENETRATE WATERPROOFING. ALL HANGERS AND SUPPORTS SHALL BE CAPABLE OF SCREW ADJUSTMENT AFTER PIPING IS ERECTED. HANGERS SUPPORTING PIPING EXPANDING INTO LOOPS, BENDS AND OFFSETS SHALL BE SECURED TO THE BUILDING STRUCTURE IN SUCH A MANNER THAT HORIZONTAL ADJUSTMENT PERPENDICULAR TO THE RUN OF PIPING SUPPORTED MAY BE MADE TO ACCOMMODATE DISPLACEMENT DUE TO EXPANSION. ALL SUCH HANGERS SHALL BE FINALLY ADJUSTED BOTH IN THE VERTICAL AND HORIZONTAL DIRECTION, AS REQUIRED.

PROVIDE ADDITIONAL SUPPORT FOR PIPING AND EQUIPMENT WHEN DECK IS NOT CAPABLE OF SUPPORT.

BEAM CLAMPS - HANGERS SUPPORTED FROM STEEL, SHALL BE CENTER LOADING. BEAM CLAMPS FOR HANGERS SUPPORTING PIPING 2 INCHES, FOR PIPING 2 1/2 INCHES AND LARGER, BEAM CLAMPS SHALL BE FORGED STEEL. CLAMPS ARE PERMITTED ONLY WHEN PROVIDED WITH RESTRAINING STRAP. BAR JOIST HANGERS SHOULD BE UTILIZED WHEN HANGING FROM BAR JOIST CONSTRUCTION.


ALL HANGERS AND SUPPORTS SHALL BE HOT DIPPED GALVANIZED. ALL THREADED ROD AND HARDWARE SHALL BE HOT DIPPED GALVANIZED.

PROVIDE AND INSTALL EXPANSION COMPENSATION FOR ALL PIPING. SUBMIT PLANS, CALCULATIONS AND EQUIPMENT DATA.


THE OVERALL COORDINATION OF THE COORDINATION PROCESS IS THE RESPONSIBILITY OF THE CONTRACTOR. THE ENGINEER IS NOT RESPONSIBLE FOR THE COORDINATION PROCESS. THE ENGINEER WILL RESPOND TO QUESTIONS THAT ARISE FROM THE COORDINATION PROCESS. DRAWINGS SUBMITTED WILL BE REVIEWED FOR CLEARLY IDENTIFIED CONFLICTS ONLY. SOLUTIONS TO CONFLICTS WILL NOT BEAR ADDITIONAL COST.

AS BUILT DRAWINGS

CONTRACTOR SHALL PROVIDE LISTED HEAD GUARDS FOR USE WITH SPRINKLERS IN AREAS SUBJECT TO MECHANICAL DAMAGE. COORDINATE AREAS WITH OWNER, PRIOR TO INSTALLATION.

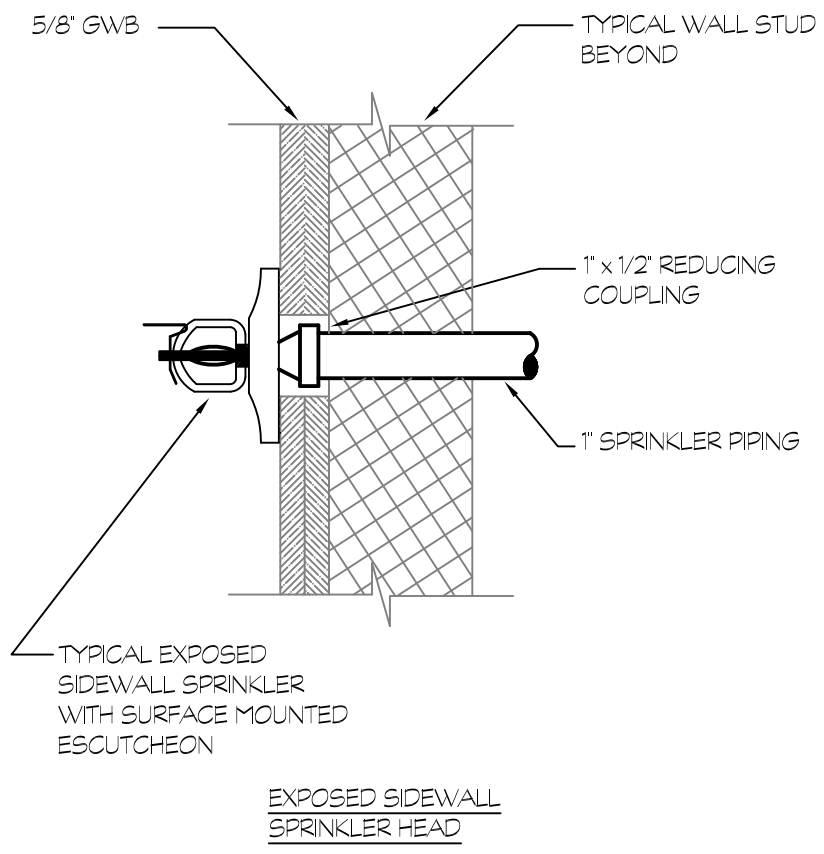

SIDEWALL SPRINKLER HEAD DETAILS
NOT TO SCALE

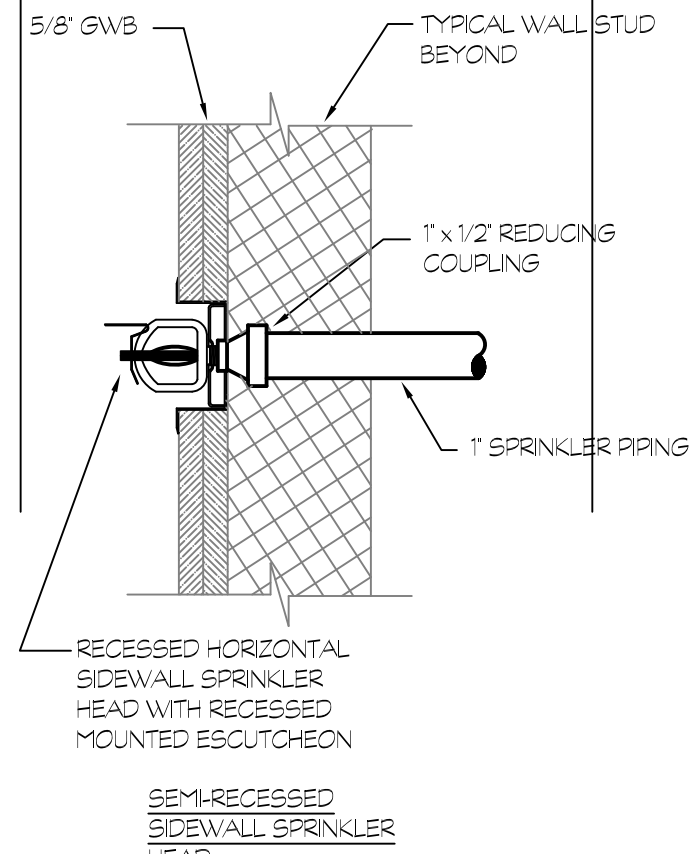

SEMI-RECESSED SIDEWALL SPRINKLER HEAD
NOT TO SCALE

FIRE PROTECTION DESIGN CRITERIA

WORK STARTS AT AREAS INDICATED, INCLUDING BUT NOT LIMITED TO: REMOVAL OF EXISTING SPRINKLER PIPING, HEADS, HANGERS, ETC., AND INSTALLATION OF NEW SPRINKLER HEADS, SPRINKLER PIPING, OFFSETS, ETC. AS NECESSARY TO PROVIDE COMPLETE SPRINKLER PROTECTION IN THE RENOVATED AREAS.

THE DESIGN OF ALL FIRE SUPPRESSION SYSTEMS WILL BE IN ACCORDANCE WITH THE 2008 STATE OF CONNECTICUT BUILDING & FIRE CODE, LOCAL CODE AND THE OWNERS INSURANCE COMPANY REQUIREMENTS. USE ONLY UL/FM APPROVED SPRINKLERS, MATERIALS AND DEVICES, UNDO.

WORK SHALL ALSO INCLUDE PROVIDING PIPING, FITTINGS, ETC. AS NECESSARY TO SUPPLY EXISTING, ADJACENT SPRINKLERS OUTSIDE OF RENOVATED AREA.

CONTRACTOR RESPONSIBLE FOR DOCUMENTING SIZE AND LENGTH OF EXISTING WATER SUPPLY INCLUDING SIZE OF ANY EXISTING FIRE PUMP, ETC. AS NECESSARY IN ORDER TO SUBMIT A COMPLETE DESIGN.

THE CONTRACTOR SHALL PROVIDE SPRINKLER COVERAGE OF ALL SPACES FORMED OF CONCEALED COMBUSTIBLE CONSTRUCTION.

THE CONTRACTOR SHALL COMPLY WITH THE OWNERS INSURANCE INSTALLATION DETAILS, DESIGN CRITERIA, AND PLAN APPROVAL SUBMISSION (INCLUDING COMMENTS). ANY DEVIATIONS AS A RESULT OF THE OWNERS INSURANCE COMPANIES REQUIREMENTS SHALL BE PROVIDED AT NO ADDITIONAL COST.

USE OF LINE SPACING OFF WALL IN EXCESS OF 7'-6", ETC (AS NOTED IN NFPA 13) IS NOT PERMITTED.

CONTRACTOR TO SUBMIT UNIT COST PER SPRINKLER HEAD INSTALLED AND OPERATIONAL WITH BID IN ACCORDANCE WITH THE GENERAL CONDITIONS (INCLUDING PIPING, FITTINGS, HANGERS, SPRINKLER HEAD, LABOR, ETC.).

PIPE SCHEDULE DESIGN CRITERIA

CONTRACTOR TO SUBMIT UNIT COST PER SPRINKLER HEAD (INCLUDING PIPING, FITTINGS, HANGERS, SPRINKLER HEAD, LABOR, ETC.) INSTALLED AND OPERATIONAL WITH BID IN ACCORDANCE WITH THE GENERAL CONDITIONS.

DESIGN CRITERIA FOR PIPE SCHEDULE SYSTEMS:

LIGHT HAZARD AREAS: OFFICES, HALLWAYS, LOBBYS, ETC. MAXIMUM COVERAGE PER SPRINKLER HEAD IS 195 SQ.FT.

ORDINARY HAZARD (GROUP I) AREAS: MECHANICAL ROOMS, ELECTRICAL ROOMS, ETC. MAXIMUM COVERAGE PER SPRINKLER HEAD IS 130 SQ.FT.

ORDINARY HAZARD (GROUP II) AREAS: STORAGE ROOMS MAXIMUM COVERAGE PER SPRINKLER HEAD IS 130 SQ.FT.

ALL FIRE PROTECTION EQUIPMENT SHALL BE FM APPROVED AND UL LISTED.

FIRE PROTECTION SYMBOL LEGEND

SYMBOL	DESCRIPTION
	GATE VALVE
	POINT OF NEW CONNECTION
	POINT OF DISCONNECTION
	FLOW SWITCH
	TAMPER SWITCH
	PIPE DOWN
	PIPE UP
	CAPPED PIPE
	PIPE OR EQUIPMENT TO BE DEMOLISHED

SPRINKLER SYMBOL LEGEND

EXISTING	NEW	DESCRIPTION
		UPRIGHT
		PENDENT - EXPOSED
		SIDEWALL

NOTE: SOME SYMBOLS AND ABBREVIATIONS SHOWN MAY NOT PERTAIN TO THIS PROJECT.


FIRE PROTECTION DEMOLITION NOTES

- NOTIFY PROPER AUTHORITIES (INCLUDING BUT NOT LIMITED TO THE LOCAL A.H.J., INSURANCE COMPANY, ETC.) OF ANY FIRE PROTECTION "SHUT DOWNS". SCHEDULE ALL WORK TO MINIMIZE THE LENGTH OF TIME THAT THE FIRE PROTECTION SYSTEM(S) WILL BE OUT OF SERVICE. RETURN THE SPRINKLER SYSTEM BACK IN SERVICE AT THE END OF EACH WORKING DAY.
- THIS JOB IS A RENOVATION OF EXISTING FACILITY.
- THE CONTRACTOR SHALL VISIT THE SITE AND BECOME THOROUGHLY FAMILIAR WITH ALL EXISTING CONDITIONS. THE CONTRACTOR SHALL BE HELD RESPONSIBLE FOR ANY ASSUMPTIONS, OMISSIONS, OR ERRORS, HE MAKES AS A RESULT OF HIS FAILURE TO BECOME FULLY FAMILIAR WITH EXISTING CONDITIONS.
- THE SPRINKLER CONTRACTOR SHALL REMOVE AND PROPERLY DISPOSE OF ALL EXISTING SPRINKLER PIPING, HANGERS, HEADS, ETC. AS INDICATED (VERIFY IN FIELD) CAP ANY UNUSED OUTLETS.
- THE CONTRACTOR SHALL PROPERLY CAP AND TERMINATE ANY UNUSED DRAIN AND FIRE PROTECTION WATER SUPPLIES (IN ACCORDANCE WITH LOCAL WATER AUTHORITY REQUIREMENTS).


FIRE PROTECTION ABBREVIATIONS

ABBREVIATION	DESCRIPTION
A.F.F.	ABOVE FINISHED FLOOR
A.F.G.	ABOVE FINISHED GRADE
B.F.F.	BELOW FINISHED FLOOR
B.V.	BUTTERFLY INDICATING VALVE
BUDG.	BUILDING
C.E.	CIVIL ENGINEER
CONT.	CONTINUED
CV.	CHECK VALVE
DA.	DIAMETER
DN.	DOWN
DWG.	DRAWING
EA.	EACH
E.C.	ELECTRICAL CONTRACTOR
EX.	EXISTING
F.F.	FINISHED FLOOR
F.F.E.	FINISHED FLOOR ELEVATION
FLR.	FLOOR
F.P.C.	FIRE PROTECTION CONTRACTOR
FT.	FEET
G.C.	GENERAL CONTRACTOR
GPM.	GALLONS PER MINUTE
MAX.	MAXIMUM
M.C.	MECHANICAL CONTRACTOR
MIN.	MINIMUM
MISC.	MISCELLANEOUS
NC.	NORMALLY CLOSED
NFPA.	NATIONAL FIRE PROTECTION ASSOCIATION
N/C.	NOT IN CONTRACT
NO.	NORMALLY OPEN
NTS.	NOT TO SCALE
OSY.	OUTSIDE SCREW AND YOKES
P.C.	PLUMBING CONTRACTOR
P.V.	POST INDICATING VALVE
P.S.I.	POUNDS PER SQUARE INCH
RAD.	RADIUS
S.C.	SITE CONTRACTOR
SF.	SQUARE FEET
SS.	SANITARY SEWER STACK
TYP.	TYPICAL
U.O.N.	UNLESS OTHERWISE NOTED
V.I.F.	VERIFY IN FIELD
Ø	DIAMETER

NOTE: SOME SYMBOLS AND ABBREVIATIONS SHOWN MAY NOT PERTAIN TO THIS PROJECT.

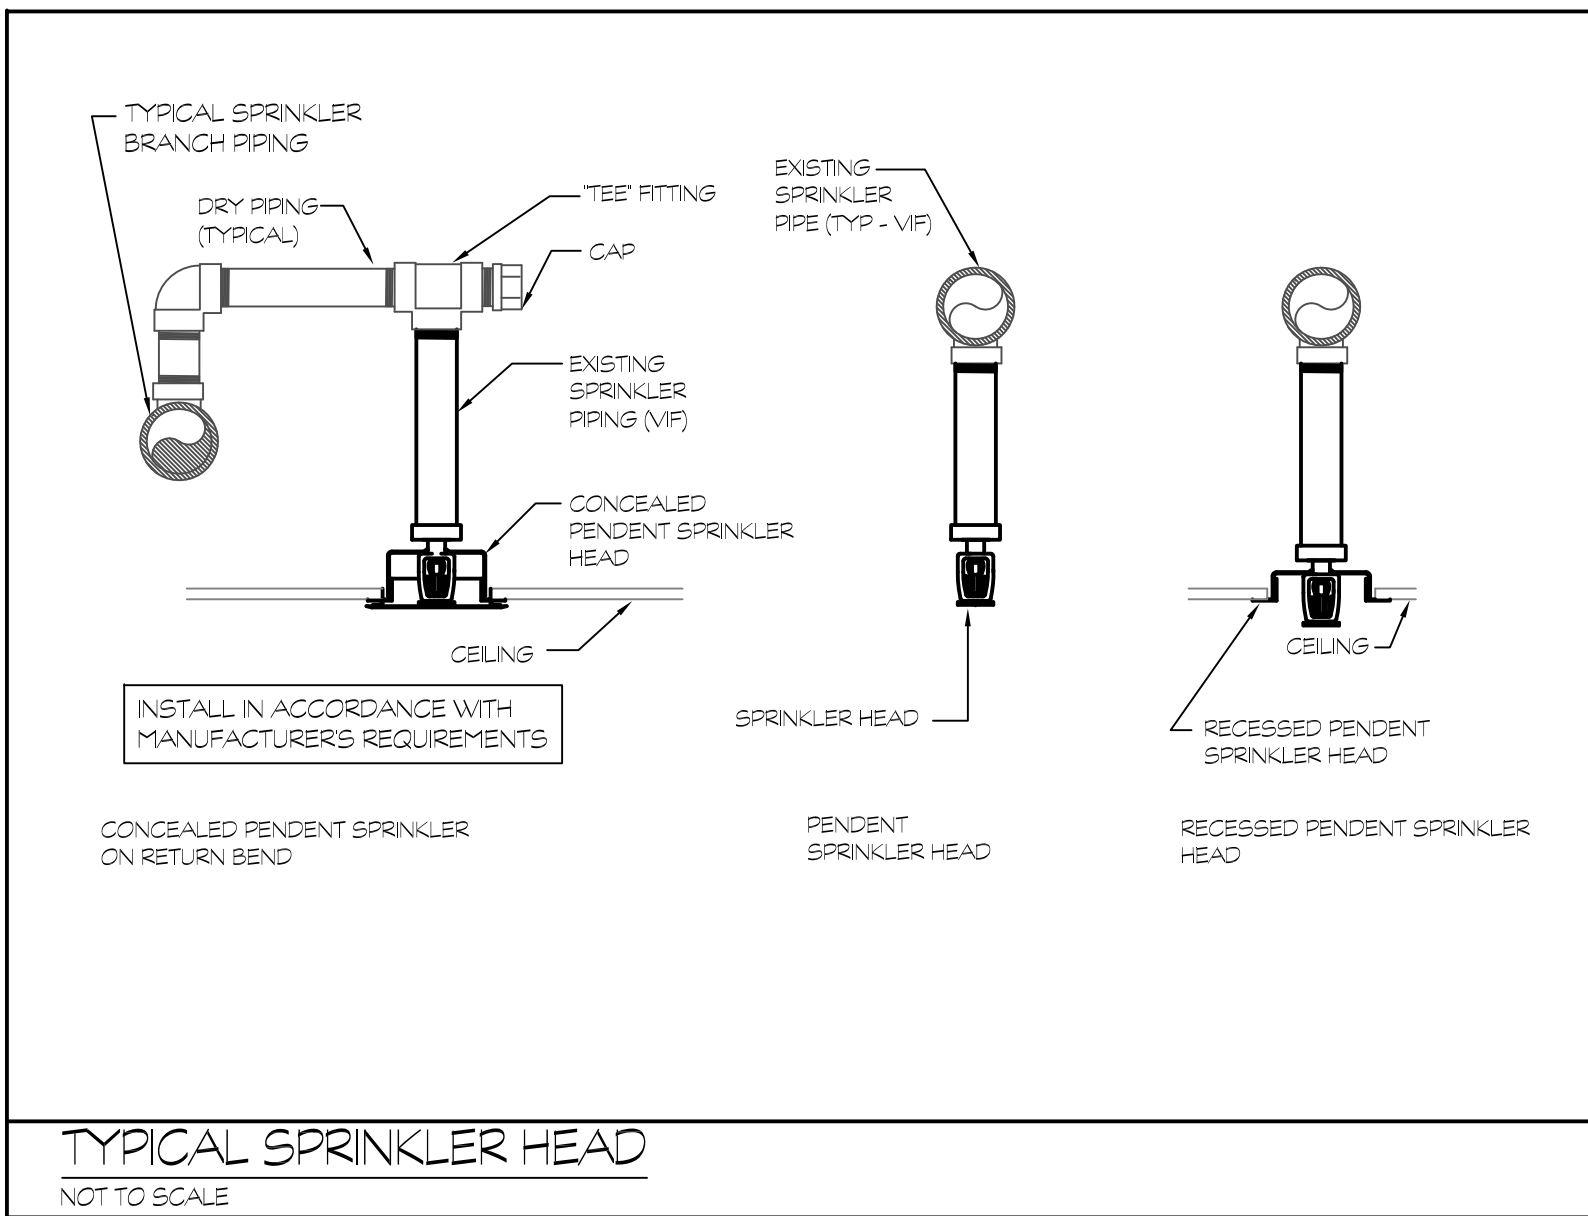

TYPICAL SPRINKLER HEAD
NOT TO SCALE

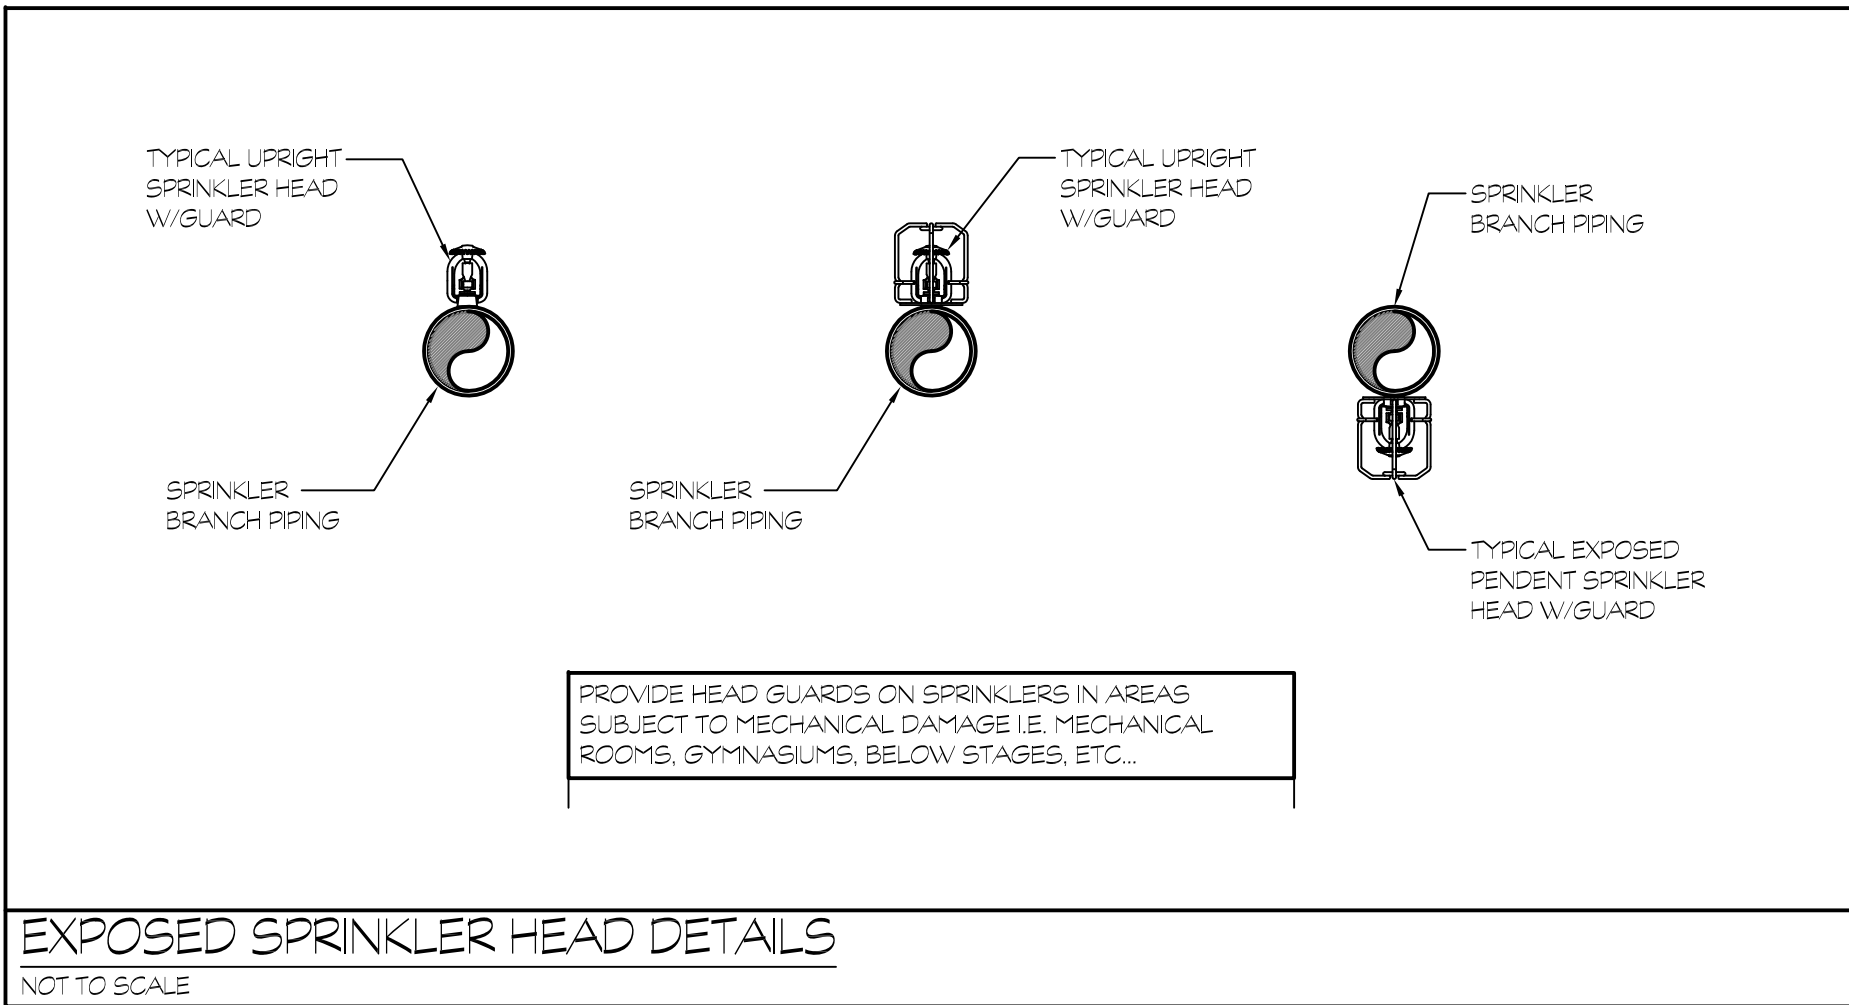

GENERAL FINISH NOTES

1. CONTRACTOR SHALL FIELD VERIFY ALL CONDITIONS & DIMENSIONS AND NOTIFY ARCHITECT IMMEDIATELY OF ANY DISCREPANCIES.


FINISH SCHEDULE NOTES

1. PATCH/REPAIR, PREP & PAINT ANY EXISTING FINISHED SURFACE DAMAGED DURING CONSTRUCTION ACTIVITIES - MATCH EXISTING FINISHES (V.I.F.).
2. PREP, REPAIR & PAINT FULL LOWER PORTION OF EXISTING COLUMNS/PIERS FROM TOP OF FINISHED FLOOR UP TO +/- 3'-6" A.F.F. (V.I.F.) TO MATCH EXISTING WAINSCOT PAINT SCHEME. RE-CUT TRANSITION LINE BETWEEN WAINSCOT COLOR AND EXISTING COLOR ABOVE TO PROVIDE SHARP TRANSITION BETWEEN COLORS. REFER TO CONSTRUCTION NOTE #4 ON FLOOR PLAN FOR LOCATIONS.

ROOM FINISH SCHEDULE

ROOM		FLOOR		WALL FINISH				CEILING		NOTES
NO.	ROOM NAME	FLR. FIN.	BASE	NORTH	SOUTH	EAST	WEST	MAT'L.	FINISH	
001	CAFETERIA	VCT	RB	E.T.R.	E.T.R.	E.T.R.	E.T.R.	E.T.R.	E.T.R.	SEE FINISH NOTES 1 & 2



FINISH SCHEDULE LEGEND	
ACT.	- ACoustICAL CEILING TILE
PT.	- PAINTED GYP BOARD
RB	- RUBBER BASE
E.T.R.	- EXISTING TO REMAIN
CT	- CERAMIC WALL TILE
CFT	- CERAMIC FLOOR TILE
CWB	- CERAMIC WALL BASE
VCT	- VINYL COMPOSITION TILE
GWB	- GYP/SM WALLBOARD
CML	- CONCRETE MASONRY UNIT

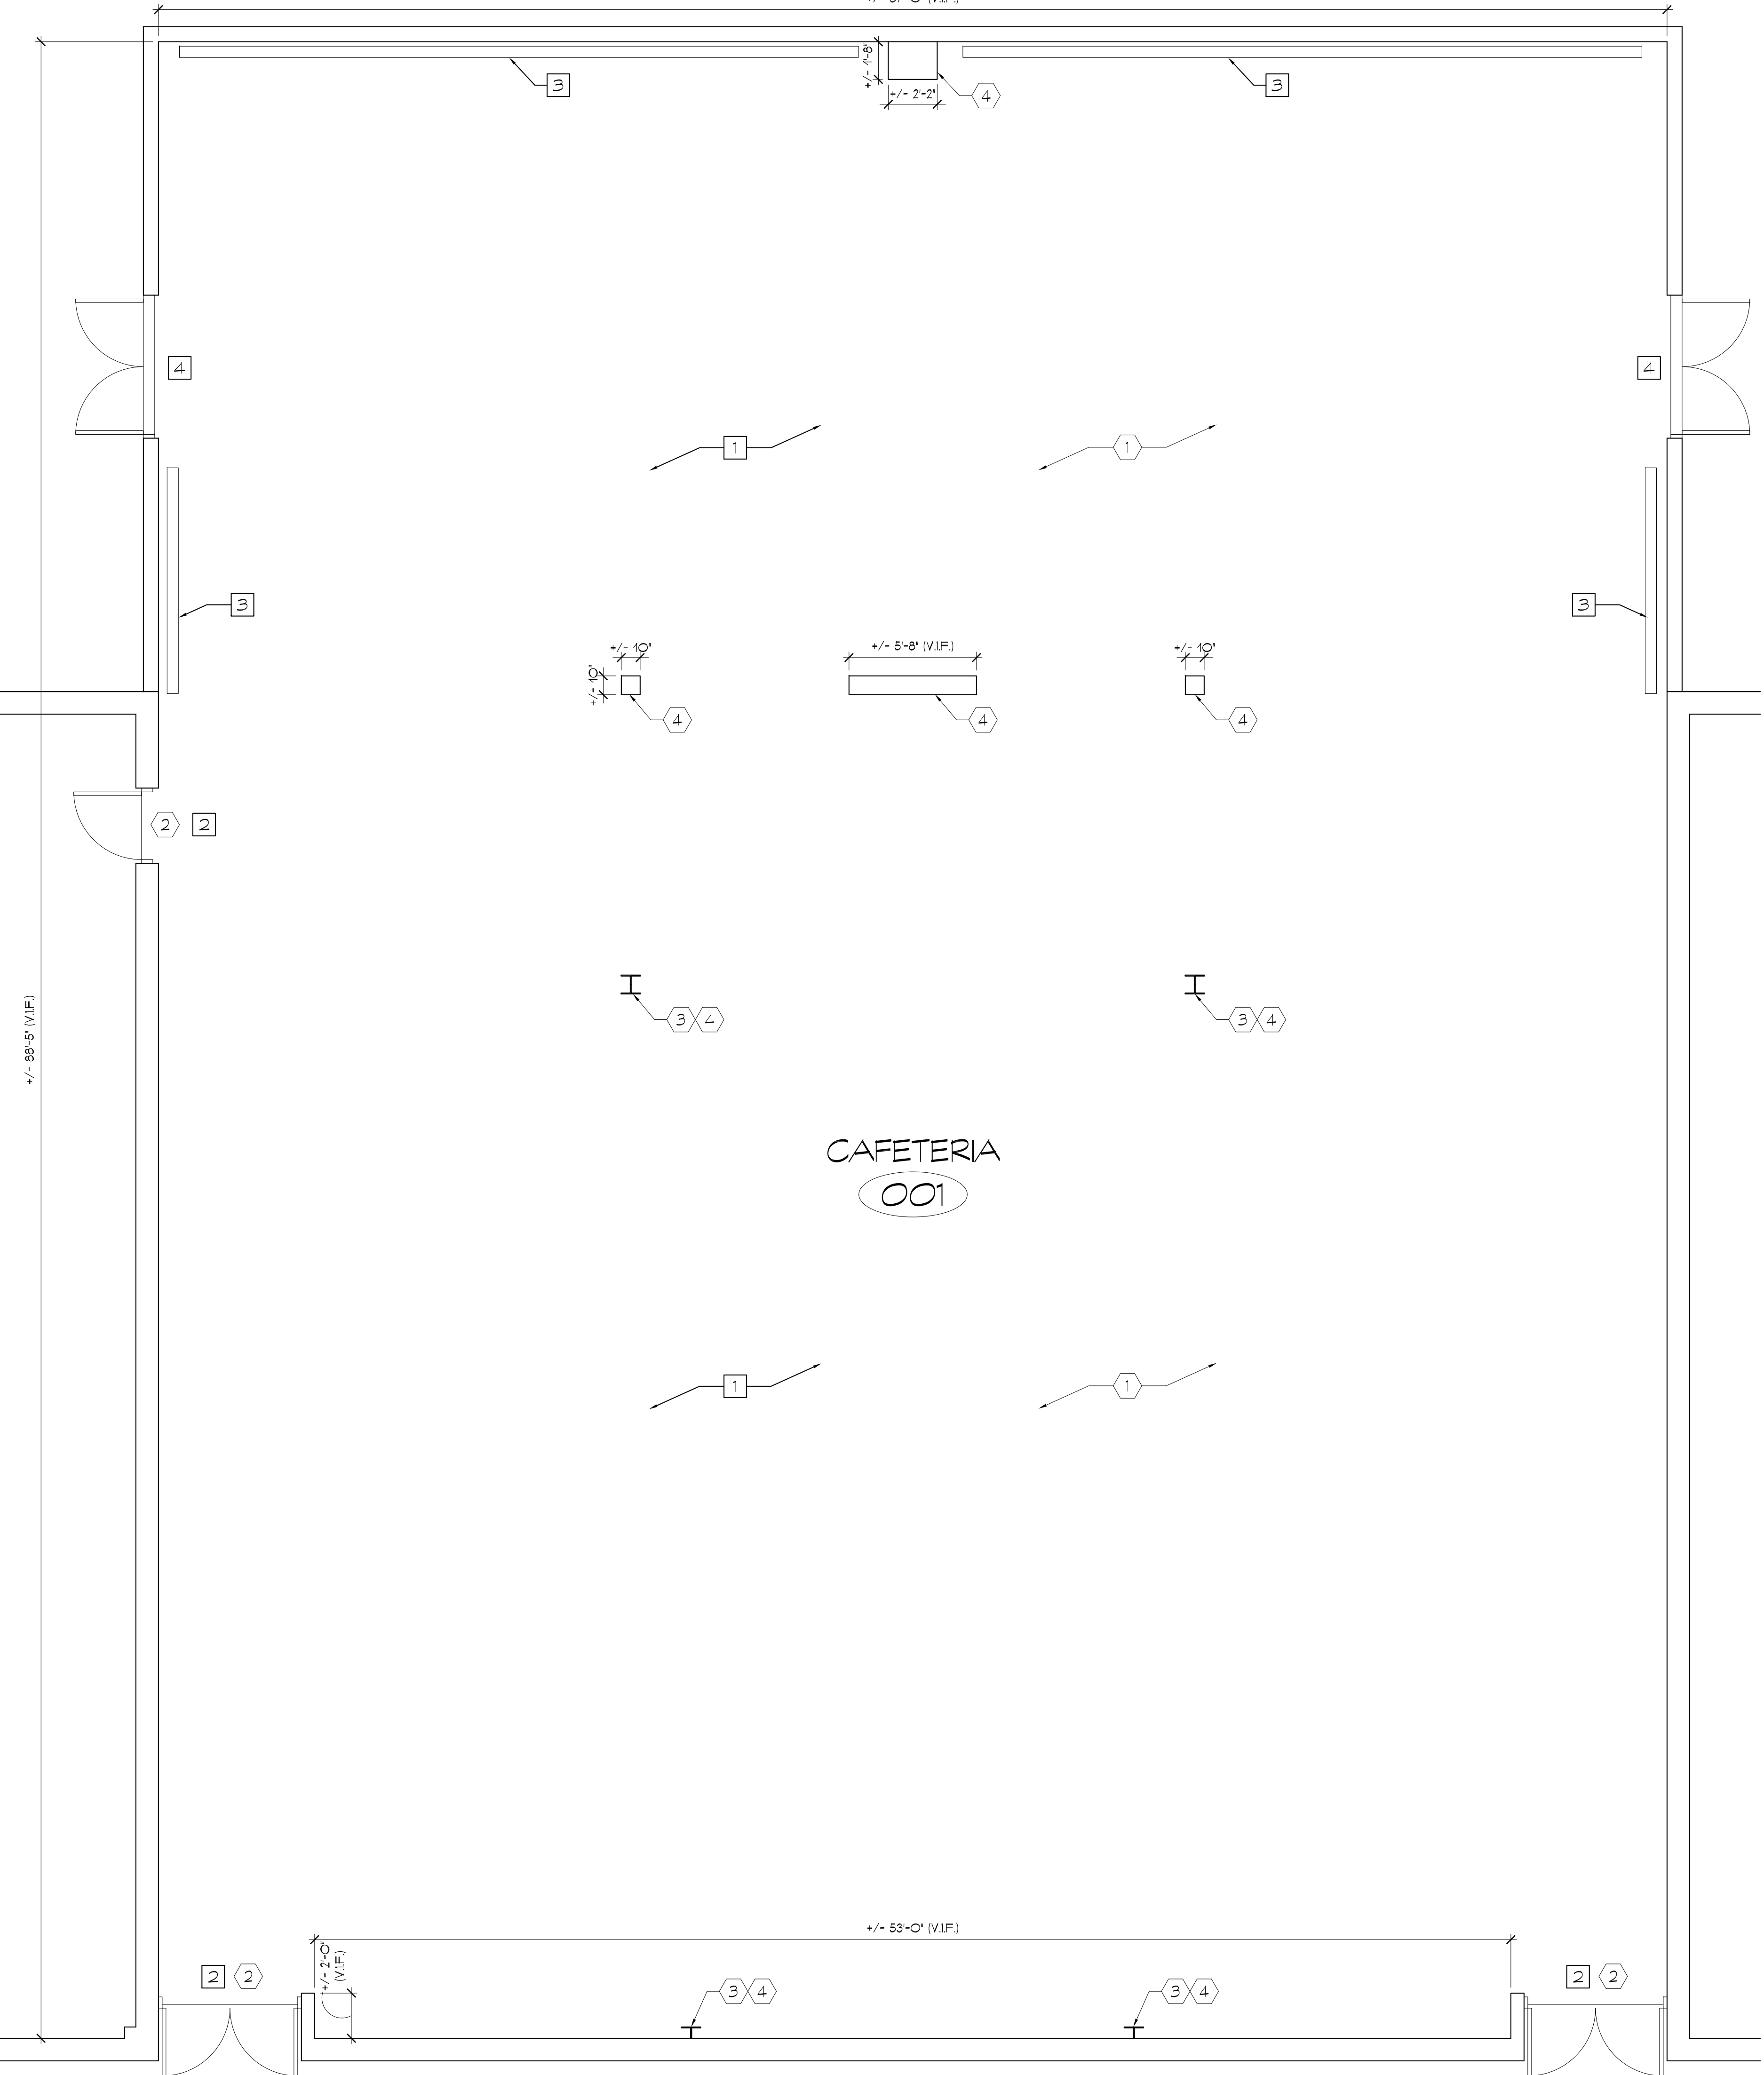

CAFETERIA FLOOR PLAN

SCALE: 1/4"=1'-0"

1
A501

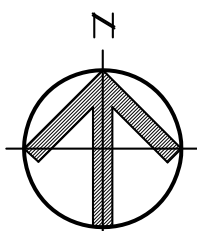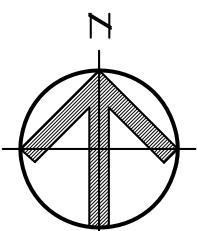

CITY HILL
LOWER LEVEL KEY PLAN
NOT TO SCALE

GENERAL NOTES

1. TEMPORARILY REMOVE & REINSTALL EXISTING BUILT-IN COMPONENTS (INCLUDING, BUT NOT LIMITED TO SHELVING, STORAGE CUBBIES, LOCKERS, WARDROBES, STORAGE CABINETS, ETC.) - VERIFY IN FIELD) AS REQUIRED TO COMPLETELY REMOVE EXISTING FLOORING AND TO PROVIDE SCHEDULED FLOORING. PROTECT ANY REMOVED ITEM/ASSEMBLY AND REPAIR DAMAGE CAUSED DURING CONSTRUCTION. CONTRACTOR TO FIELD VERIFY EXISTING CONDITIONS AT EACH AREA OF WORK, AS CONDITIONS MAY VARY BY ROOM/LOCATION.
2. DIMENSIONS & LAYOUTS SHOWN ON THE DRAWINGS ARE APPROXIMATE BASED ON EXISTING AS-BUILT DRAWINGS PROVIDED BY THE OWNER AND MAY NOT REFLECT ACTUAL FIELD CONDITIONS - CONTRACTOR IS RESPONSIBLE FOR FIELD VERIFYING ALL EXISTING CONDITIONS, INCLUDING FIELD-VERIFIED DIMENSIONS, CONFIGURATIONS AND FINISHES. NOTIFY THE ARCHITECT IMMEDIATELY UPON DISCOVERY OF ANY DISCREPANCIES.
3. CONTRACTOR IS REQUIRED TO VISIT THE SITE AND BECOME FAMILIAR WITH THE EXISTING CONDITIONS AND THE SCOPE OF WORK PRIOR TO SUBMITTING A BID.


DEMOLITION NOTES

1. REMOVE EXISTING RESILIENT RAISED RUBBER TILE FLOORING, RUBBER WALL BASE & TRANSITION STRIPS AT CAFETERIA, INCLUDING EXISTING ALCOVES AND RECESSED AREAS. PREP EXISTING CONCRETE FLOOR & CMU WALL (V.I.F.) SUBSTRATES TO RECEIVE SCHEDULED FINISH.
2. WHERE EXISTING FLOORING IS CONTINUOUS TO ADJACENT SPACES AT DOORWAYS, CUT AND REMOVE EXISTING FLOORING ON THE CAFETERIA SIDE OF THE DOOR TO A POINT ALIGNED WITH CENTER OF DOOR (V.I.F.).
3. EXISTING FLOOR MOUNTED RADIATOR TO REMAIN (CONTRACTOR TO VERIFY SIZE, LOCATION AND CONFIGURATION IN FIELD). REMOVE, CLEAN & REINSTALL EXISTING COVERS AS REQD TO PROVIDE SCHEDULED FINISHES.
4. EXISTING DOOR ASSEMBLY & THRESHOLD TO REMAIN - REMOVE & REINSTALL EXISTING THRESHOLD AS REQD TO PROVIDE SCHEDULED FINISHES.

CONSTRUCTION NOTES

1. REPAIR & PREP EXISTING CONCRETE SUBSTRATE (V.I.F.) AT AREAS OF FLOORING REMOVAL AS REQUIRED TO RECEIVE SCHEDULED RESILIENT FLOORING FINISH. REPAIR & PREP EXISTING WALL SUBSTRATE AS REQUIRED TO RECEIVE SCHEDULED WALL BASE. PROVIDE SCHEDULED FINISHES - REFER TO FINISH SCHEDULE FOR MORE INFORMATION.
2. PROVIDE TRANSITION STRIPS AT DOORWAYS WHERE FLOORING WORK IS NOT LEVEL/ALIGNED WITH EXISTING ADJACENT FLOORING TO REMAIN.
3. NEATLY & PRECISELY CUT FLOORING TO MATCH PROFILE OF EXISTING STEEL COLUMN PROFILE (V.I.F.)
4. PREP, REPAIR & PAINT FULL LOWER PORTION OF EXISTING COLUMNS/PIERS FROM TOP OF FINISHED FLOORING TO +/- 3'-6" A.F.F. (V.I.F.) TO MATCH EXISTING WAINSCOT PAINT SCHEME



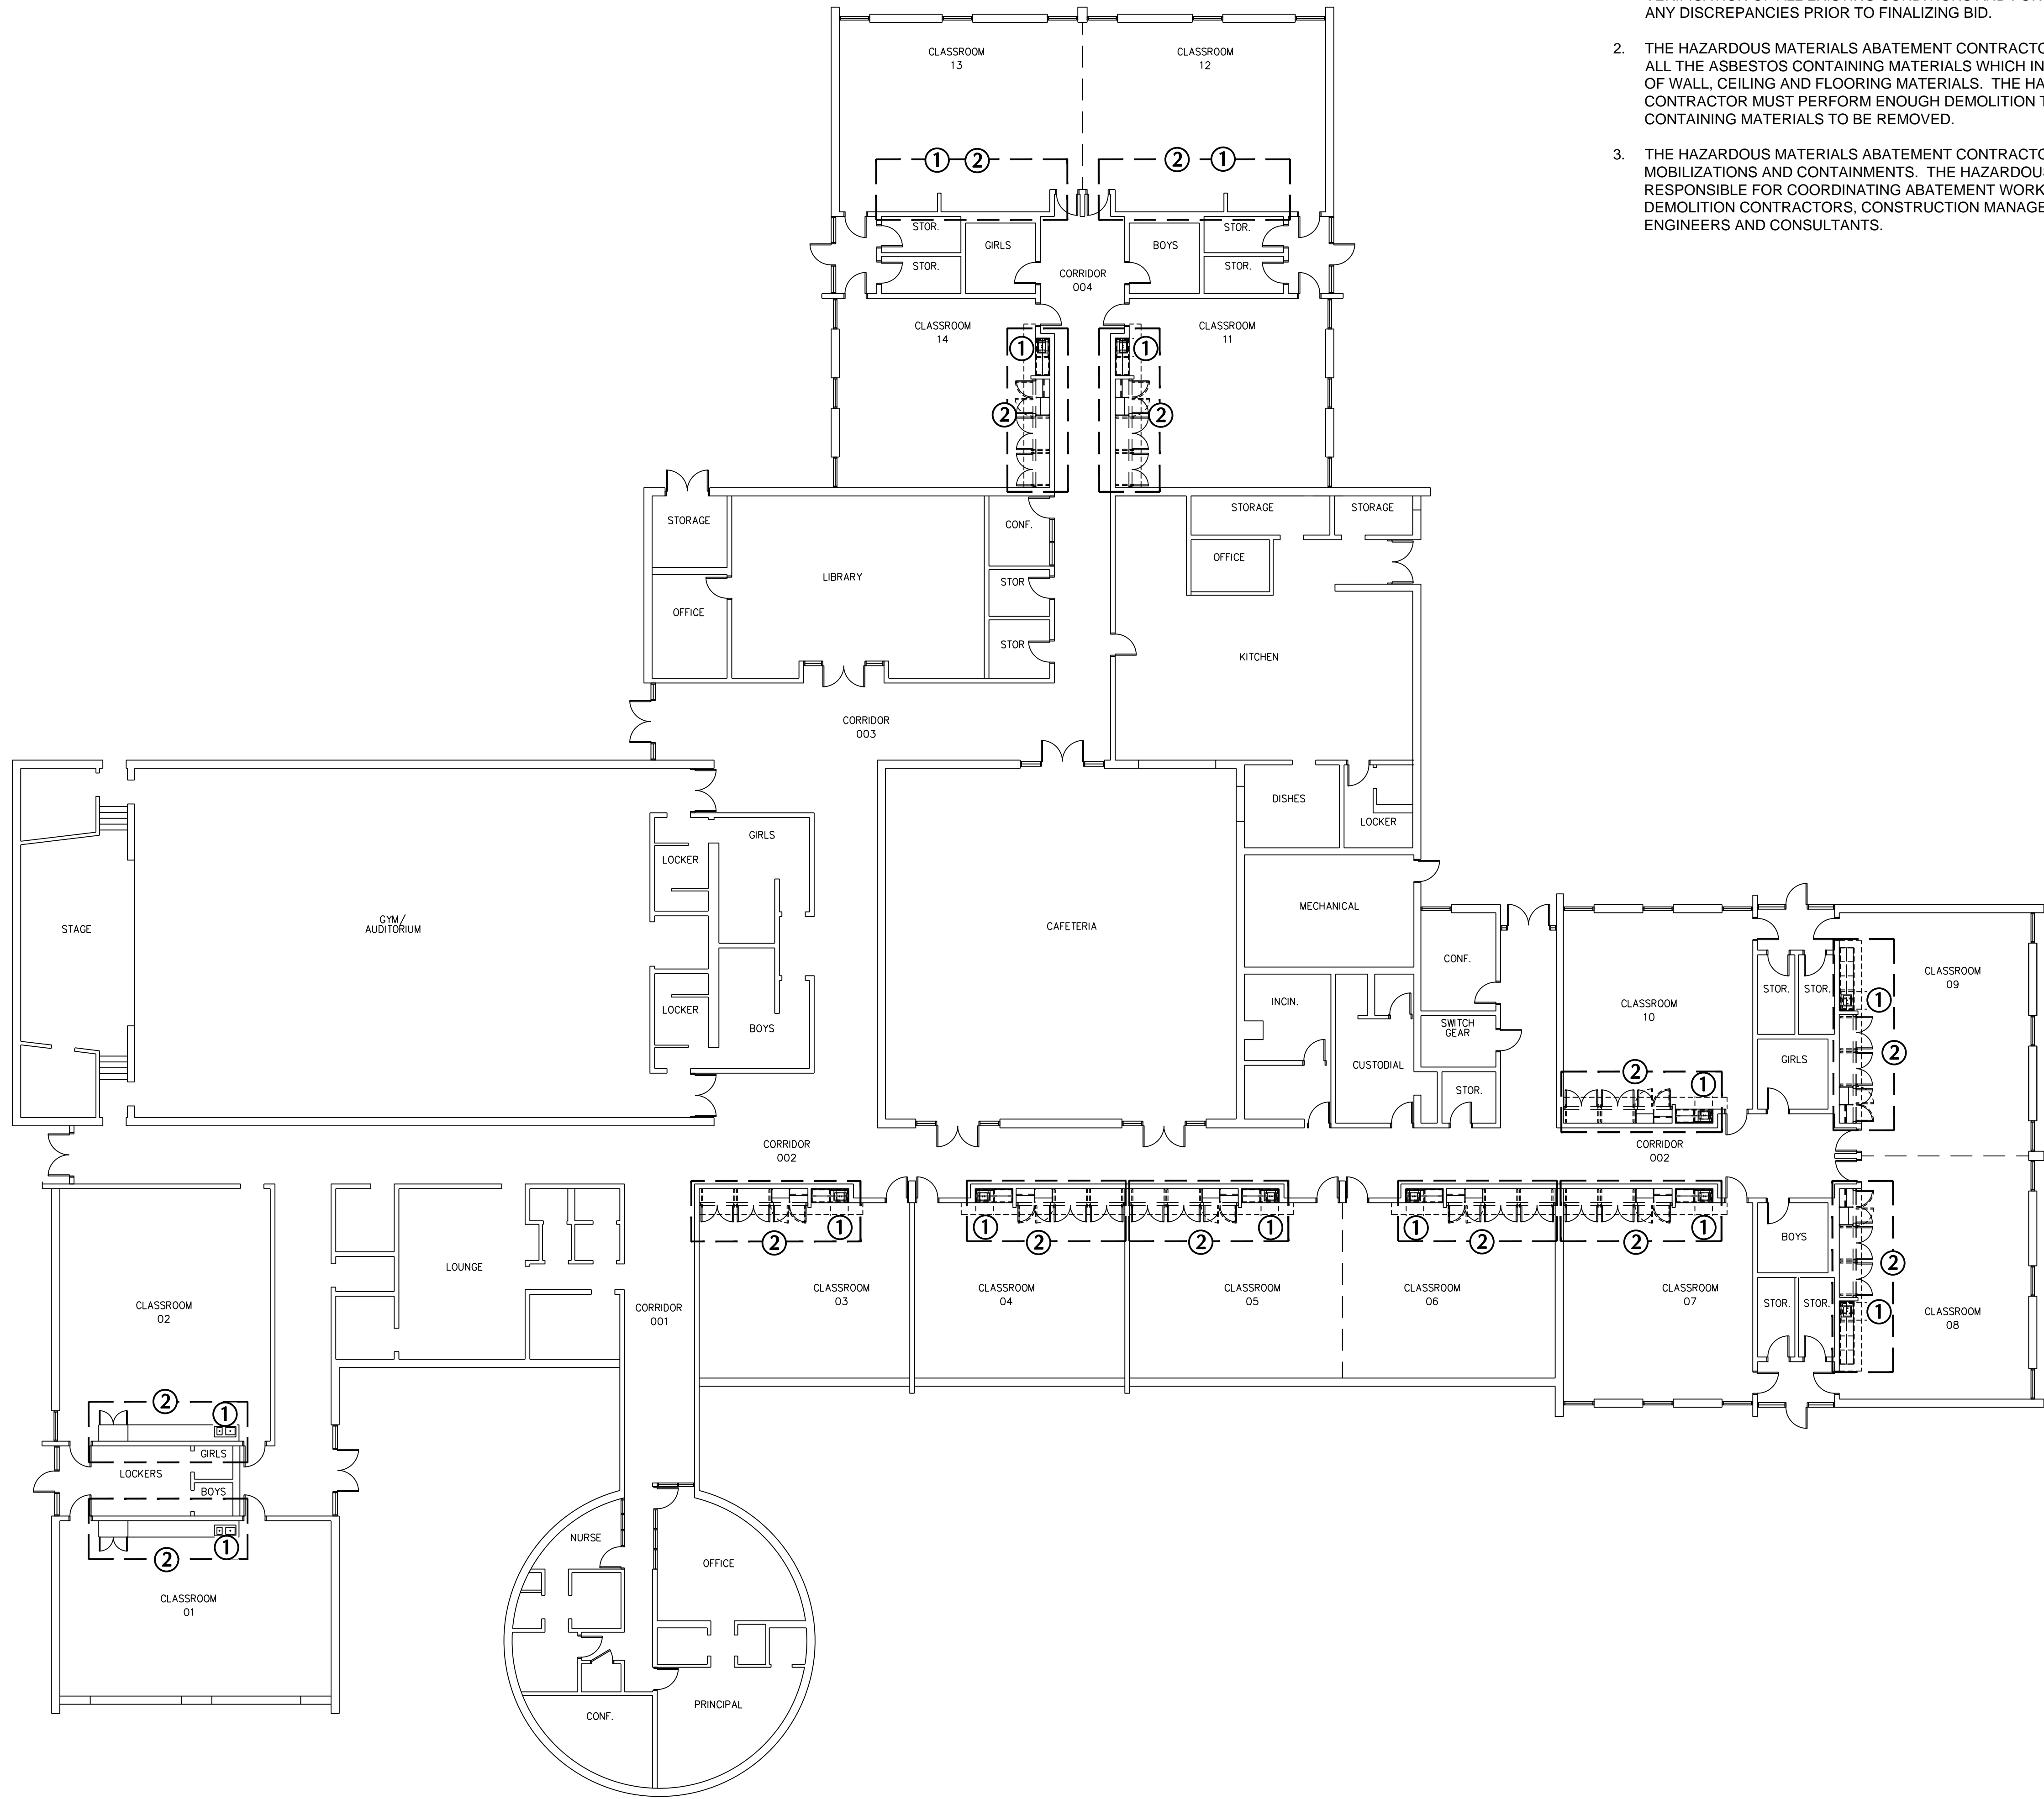

GENERAL NOTES:

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2. THE HAZARDOUS MATERIALS ABATEMENT CONTRACTOR IS RESPONSIBLE FOR REMOVING ALL THE ASBESTOS CONTAINING MATERIALS WHICH IN SOME CASES IS SEVERAL LAYERS OF WALL, CEILING AND FLOORING MATERIALS. THE HAZARDOUS MATERIALS ABATEMENT CONTRACTOR MUST PERFORM ENOUGH DEMOLITION TO ACCESS ALL ASBESTOS CONTAINING MATERIALS TO BE REMOVED.
3. THE HAZARDOUS MATERIALS ABATEMENT CONTRACTOR IS RESPONSIBLE FOR MULTIPLE MOBILIZATIONS AND CONTAINMENTS. THE HAZARDOUS MATERIALS CONTRACTOR IS RESPONSIBLE FOR COORDINATING ABATEMENT WORK WITH THE GENERAL AND DEMOLITION CONTRACTORS, CONSTRUCTION MANAGER, BUILDING OWNER, ARCHITECTS, ENGINEERS AND CONSULTANTS.

HAZARDOUS MATERIALS ABATEMENT NOTES:

① ANDREW AVENUE ELEMENTARY SCHOOL:
THE HAZARDOUS MATERIALS ABATEMENT CONTRACTOR SHALL REMOVE AND DISPOSE OF ASBESTOS CONTAINING SINK UNDERCOATING AS ACM.

② ANDREW AVENUE ELEMENTARY SCHOOL:
THE HAZARDOUS MATERIALS ABATEMENT CONTRACTOR SHALL REMOVE AND DISPOSE OF ASBESTOS CONTAINING FLOORING MATERIALS (INCLUDES MULTIPLE LAYERS OF WOOD, CARPETING, FLOOR TILES/MASTIC, SHEET FLOORING AND OTHER FLOORING MATERIALS) AS ACM. INCLUDE DEMOLITION OF CABINETRY, MILLWORK, DOORS, CLOSETS, ETC. (PLEASE SEE BASE BID AND DEDUCT ALTERNATE #1 IN SPECIFICATIONS.

③ HILLSIDE INTERMEDIATE SCHOOL:
THE HAZARDOUS MATERIALS ABATEMENT CONTRACTOR SHALL REMOVE AND DISPOSE OF ASBESTOS CONTAINING LIGHT BACKING PAPER INSULATION AS ACM.

HILLSIDE INTERMEDIATE SCHOOL - THIRD AND SECOND FLOOR
ADD ALTERNATE #5: THE HAZARDOUS MATERIALS ABATEMENT CONTRACTOR SHALL REMOVE AND DISPOSE OF ASBESTOS CONTAINING CEILING TILES AS ACM WORK INCLUDES DECONTAMINATION OF THE CEILING TILE GRID SUPPORT SYSTEM AND ASSOCIATED LIGHTING/DUCTWORK/AIR DIFFUSERS/RETURNS/ETC. LOCATED AT AND ABOVE SUSPENDED CEILING HEIGHT AS ACM.

HILLSIDE INTERMEDIATE SCHOOL - BUILDING ADDITION - FIRST FLOOR CORRIDORS ADJACENT BAND ROOM AREAS
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HILLSIDE INTERMEDIATE SCHOOL - MAIN BUILDING THIRD AND SECOND FLOORS, BUILDING ADDITION FIRST FLOOR BAND ROOM AREAS AND ADJACENT CORRIDORS
ADD ALTERNATE #7: THE HAZARDOUS MATERIALS ABATEMENT CONTRACTOR SHALL REMOVE AND DISPOSE OF ASBESTOS CONTAINING PIPE/FITTING/ROOF DRAIN INSULATION ABOVE CEILING TILES (INCLUDES REINSULATION) AS ACM.

Project Title:
Borough of Naugatuck
District Wide School Upgrades
497 Rubber Ave
Naugatuck, Connecticut 06770



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Revision:	Description:	Date:	Revised By:

Drawing Title:

**ANDREW AVENUE ES
HAZARDOUS MATERIALS
ABATEMENT PLAN**

Date:
June 14, 2016
Scale:
N.T.S.
Drawn By:
HHG
Project Number:
16.041

HM-01

GENERAL NOTES:

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ADD ALTERNATE
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Revision:	Description:	Date:	Revised By:

Drawing Title:

HILLSIDE INTERMEDIATE
SCHOOL HAZARDOUS
MATERIALS ABATEMENT
PLAN - THIRD FLOOR

Date: June 14, 2016
Scale: N.T.S.
Drawn By: HHG
Project Number: 16.041

Drawing Number:

HM-02

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#5 & #7

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Revision:	Description:	Date:	Revised By:

Drawing Title:
HILLSIDE INTERMEDIATE
SCHOOL HAZARDOUS
MATERIALS ABATEMENT
PLAN - SECOND FLOOR

Date:
June 14, 2016
Scale:
N.T.S.
Drawn By:
HHG
Project Number:
16.041

Drawing Number:


HM-03

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Revision:	Description:	Date:	Revised By:

Drawing Title:

HILLSIDE INTERMEDIATE SCHOOL
HAZARDOUS MATERIALS ABATEMENT
PLAN - FIRST FLOOR BUILDING
ADDITION BAND ROOM AREAS

Date:
June 14, 2016
Scale:
N.T.S.
Drawn By:
HHG
Project Number:
16.041

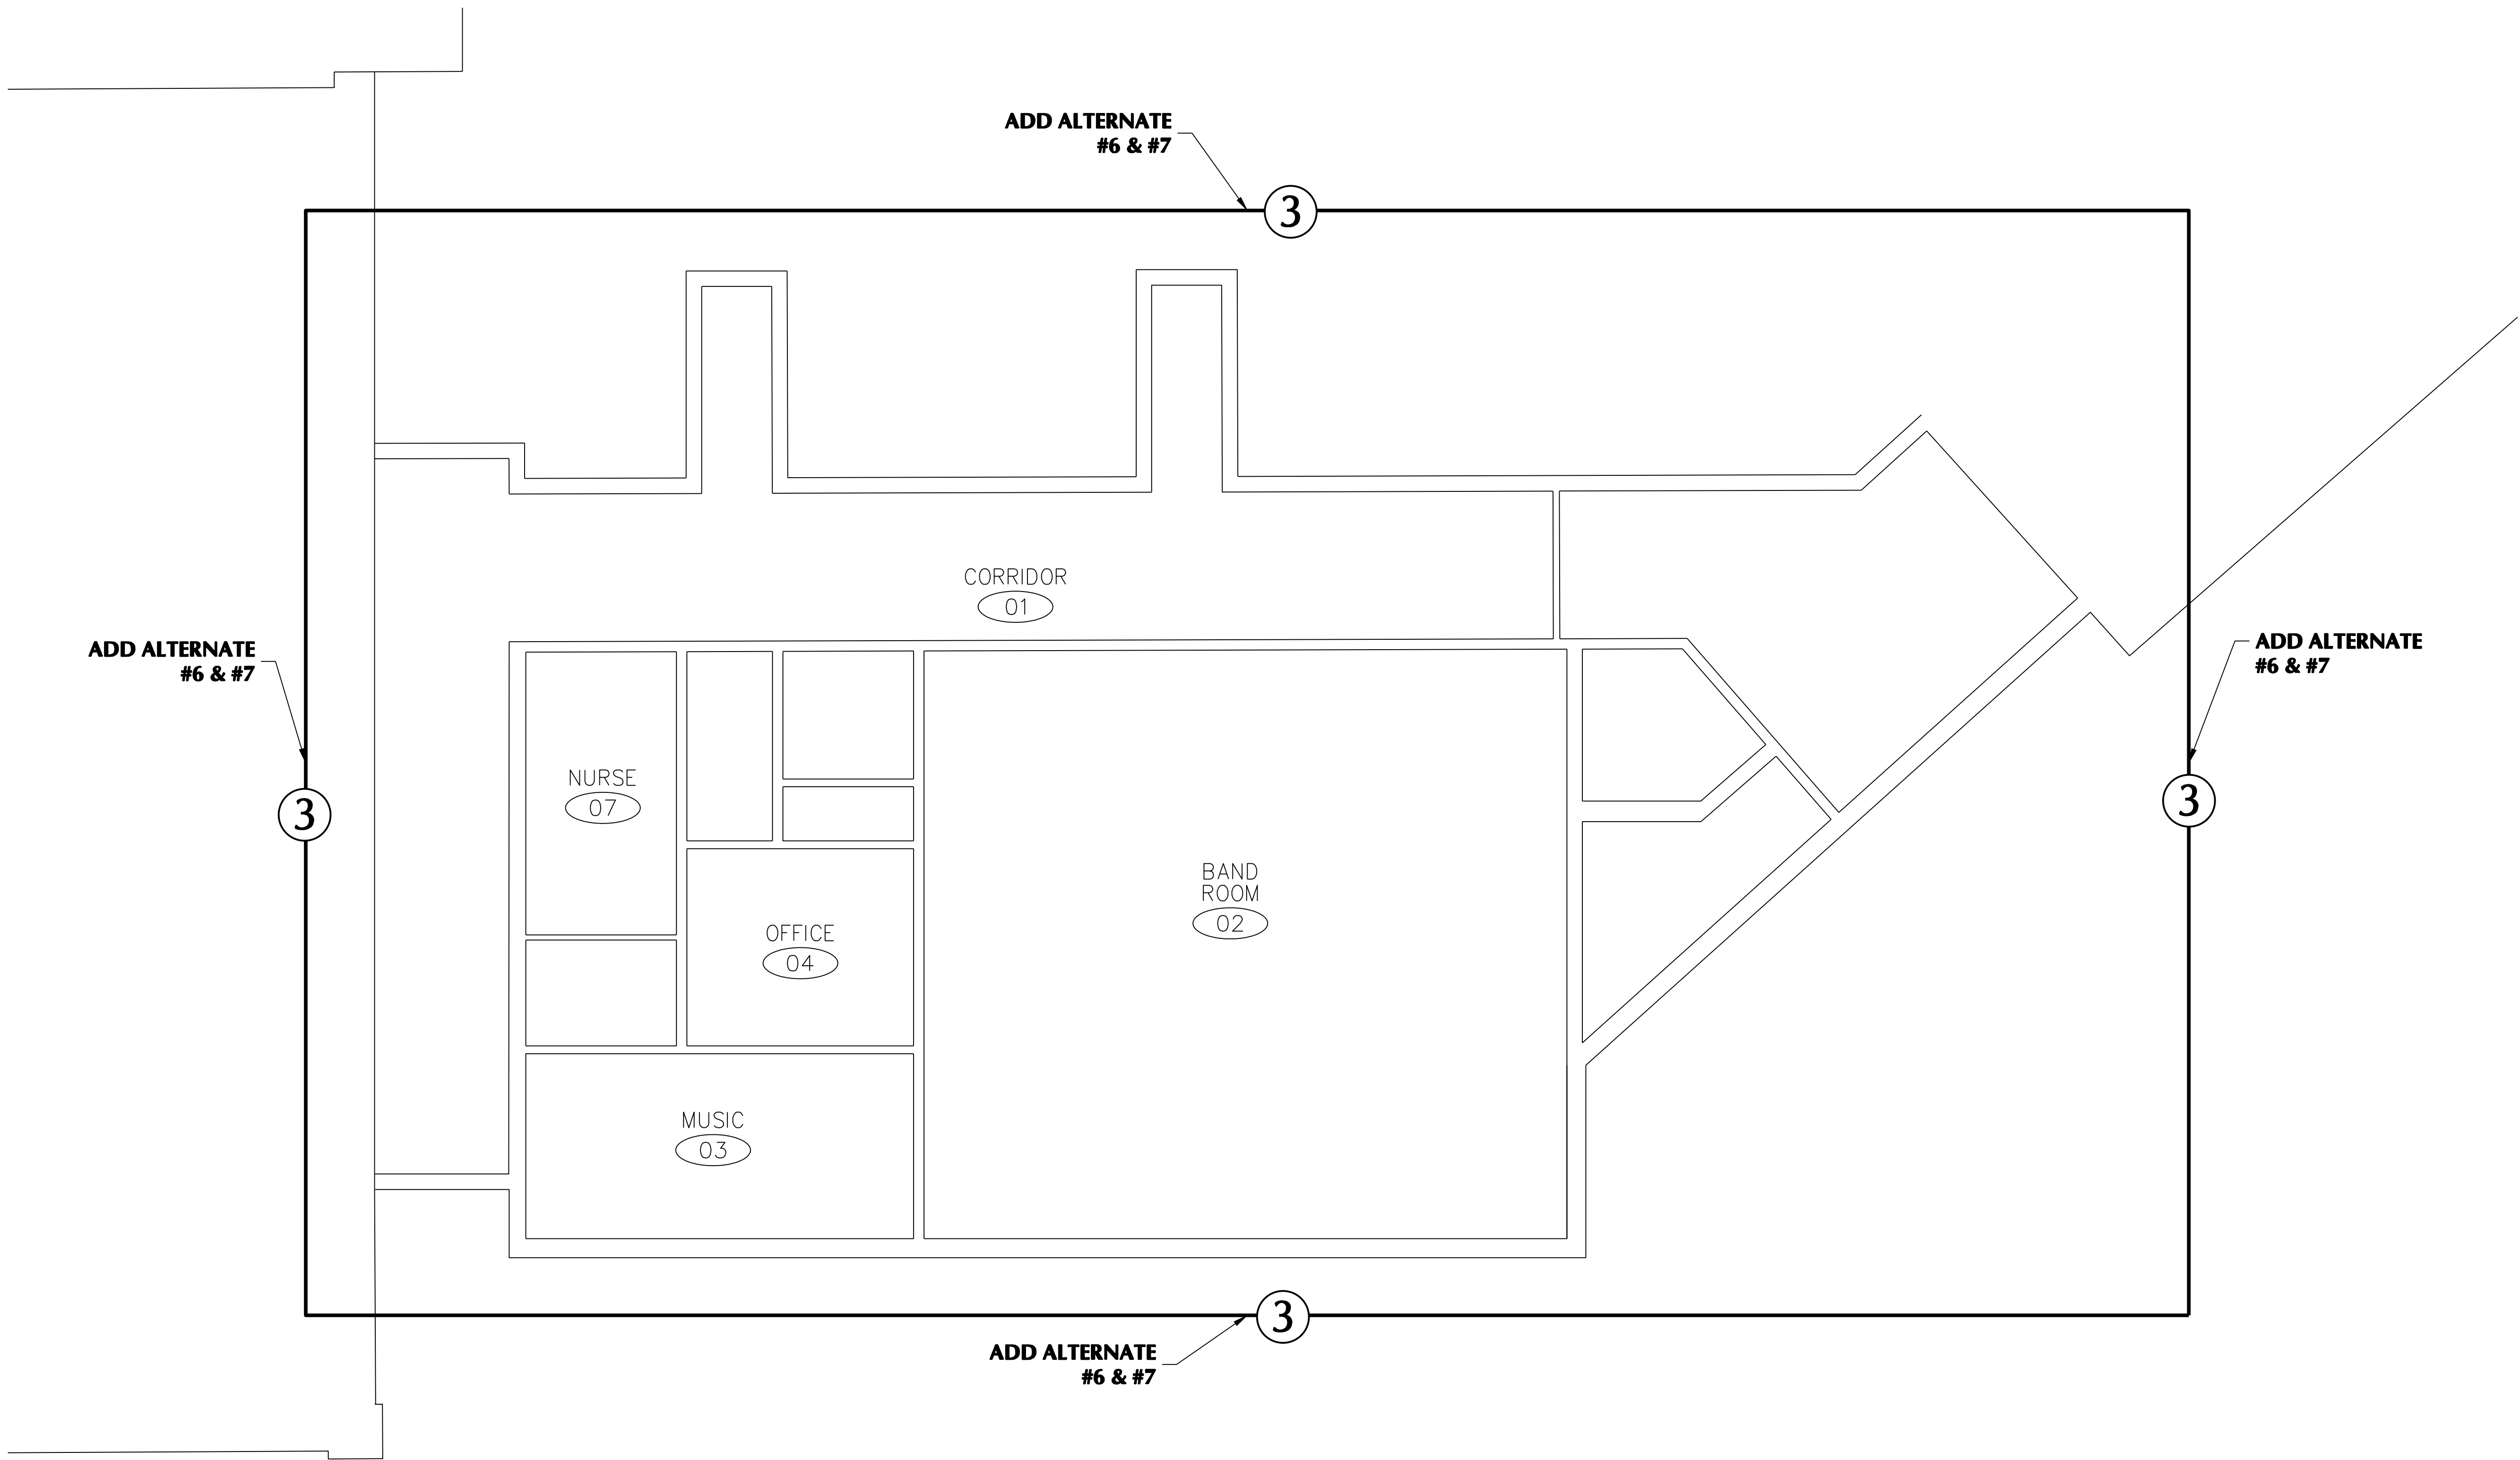Drawing Number:

HM-04